JACKSON SQUARE

WEYMOUTH, MA

AUGUST 4, 2023 SITE PLAN REVIEW

ABBREVIATIONS

ACT

ADA

ARCH

BLDG

BLKG

COL. CONT

CMU

DIM.

DWG.

HM

MEP

MTL.

N.I.C.

N.T.S.

OPNG.

APPROX

ABOVE FINISHED FLOOR ACOUSTIC CEILING TILE AMERICANS WITH DISABILITIES ACT APPROXIMATE **ARCHITECTURAL** AUDIO VISUAL

BUILDING BLOCKING BOTTOM OF CABINET CEILING HEIGHT CENTERLINE COLUMN

CONTINUOUS CONCRETE MASONRY UNIT CONTROL JOINT

DIAMETER DOWN DRAWING existing

ELEVATION ELECTRICAL EQUAL FLOOR DRAIN FACE OF FACE OF CONCRETE

F.O.C. F.O.F. FACE OF FINISH F.O.S. FACE OF STUD GFIC GROUND FAULT INTERCEPTOR CIRCUIT GSM. GALVANIZED SHEET METAL GWB GYPSUM WALL BOARD H OR HVAC HEATING, VENTILATING, AND AIR CONDITIONING H.B. HOSE BIB

HOLLOW METAL MAXIMUM MASONRY OPENING MECH. MECHANICAL MECHANICAL, ELECTRICAL, PLUMBING MINIMUM MISC MISCELLANEOUS

> NOT IN CONTRACT NOT TO SCALE OVER ON CENTER OUTSIDE DIAMETER OPENING **OPPOSITE**

METAL


OPP. P.G. PAINT GRADE PLYWD. **PLYWOOD** PTD. PAINTED R.D. **ROOF DRAIN** REQUIRED R.O. ROUGH OPENING SCHED. **SCHEDULE** STAIN GRADE

SIMILAR S.L.D. SEE LANDSCAPE DRAWINGS SQUARE SPECIFICATION S.S.D. SEE STRUCTURAL DRAWINGS SSTL. STAINLESS STEEL STOR. STORAGE STRUCT. STRUCTURAL SYMMETRICAL SYM. TEMPERED T&G TONGUE AND GROOVE

THK. THICKNESS T.O. TOP OF T.O.S. TOP OF SLAB TUBULAR STEEL TYP. TYPICAL U.O.N. UNLESS OTHERWISE NOTED

V.I.F. VERIFY IN FIELD WITH W/O WITHOUT WD WPM. WOOD WATERPROOFING MEMBRANE

SYMBOLS

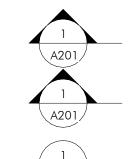

REFERENCE NUMBER **BUILDING SECTION** DRAWING SHEET REFERENCE NUMBER WALL SECTION DRAWING SHEET

REFERENCE NUMBER DRAWING SHEET

REFERENCE NUMBER DRAWING DRAWING SHEET

REFERENCE NUMBER

INTERIOR ELEVATION

REFERENCE NUMBER

EXTERIOR ELEVATION


DRAWING SHEET

DRAWING SHEET NORTH ARROW

X000 APPLIANCE TAG revision tag CENTER LINE



VICINITY MAP

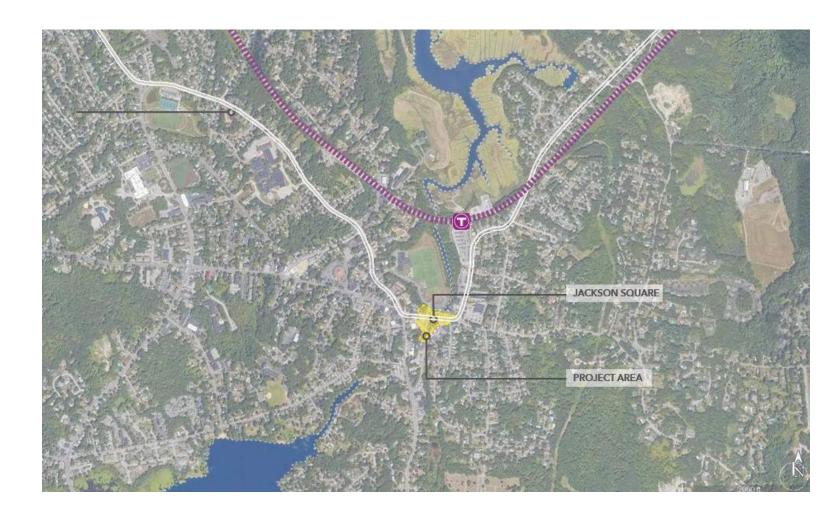

SHEET LIST

GENERAL

A000

A001 PROGRAM AND ZONING ANALYSIS CIVIL EX-1 EXISTING CONDITIONS PLAN EX-2 EXISTING CONDITIONS PLAN EX-3 EXISTING CONDITIONS PLAN

COVER SHEET

C-1 SITE LAYOUT PLAN BUILDINGS A&B C-2 SITE LAYOUT PLAN BUILDINGS C&D C-3 GRADING & DRAINAGE PLAN BUILDINGS A&B C-4 GRADING & DRAINAGE PLAN BUILDINGS C&D C-5 CONSTRUCTION DETAILS C-6 CONSTRUCTION DETAILS C-7 CONSTRUCTION DETAILS C-8 CONSTRUCTION DETAILS C-9 CONSTRUCTION DETAILS C-10 CONSTRUCTION DETAILS C-11 CONSTRUCTION DETAILS C-12 EROSION CONTROL PLAN C-13 EROSION CONTROL PLAN EROSION CONTROL PLAN C-14

ARCHITECTURAL

ARCHITECTURAL SITE PLAN A101A BUILDING A FLOOR PLANS BUILDING A FLOOR PLANS A102 BUILDING B FLOOR PLANS A103 BUILDING C FLOOR PLANS A104 BUILDING D FLOOR PLANS A201 BUILDING A ELEVATIONS A202 BUILDING B ELEVATIONS A203 BUILDING C ELEVATIONS A204 BUILDING D ELEVATIONS A210 BUILDING MATERIALS A301 BROAD STREET SECTION A901 PERSPECTIVE VIEWS A902 PERSPECTIVE VIEWS

LANDSCAPE

LANDSCAPE KEY PLAN LANDSCAPE PLANTING AND LIGHTING PLAN L2 LANDSCAPE PLANTING AND LIGHTING PLAN L3 LANDSCAPE PLANTING AND LIGHTING PLAN ROOF DECK AMENITY ENLARGEMENTS LANDSCAPE PHOTOMETRICS PLAN LANDSCAPE PHOTOMETRICS PLAN LANDSCAPE PHOTOMETRICS PLAN LANDSCAPE DETAILS

LANDSCAPE DETAILS

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MDLA 840 SUMMER STREET

SQUARE


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REVISIONS

MARK ISSUE DATE



DRAWING INFORMATION

ISSUE: <u>SITE PLAN REVIEW</u> AUGUST 4, 2023 PROJECT #: 22034

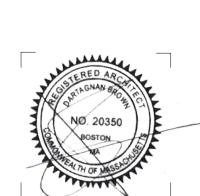SCALE: As indicated

DRAWING TITLE COVER SHEET

REQUIRED B-2 LJSD Mixed Use	PROPOSED	Compliant (Y/N/SP)
LJSD		
		1
Mixed Use		
	Mixed Use ^a	Y
N/A	34,903 s.f.	Y
N/A 206.44 ft.		Y
N/A 206.44 ft.		Y
Max 80% 80%		Y
N/A	Modal	Y
N/A	Modal	Y
N/A	6'-5" east, 3'-9" west	Y
N/A	7'-10"	Y
5 Floors 60 ft.d	5 Floors 59 ft. 7 in.	SP
N/A	218 (85 for property)	Y
N/A	N/A	Υ
Refer to Landscape table	Refer to Landscape table	Y
N/A	1.93	Y
	S.	
	asity Panus (min 10%)	
	N/A N/A N/A Max 80% N/A N/A N/A N/A S Floors 60 ft.d N/A N/A N/A N/A N/A N/A N/A N/	N/A 34,903 s.f. N/A 206.44 ft. N/A 80% N/A Modal N/A Modal N/A 6'-5" east, 3'-9" west N/A 7'-10" 5 Floors 60 ft.d 5 Floors 59 ft. 7 in. N/A 218 (85 for property) N/A N/A Refer to Landscape table Refer to Landscape table N/A 1.93

Fourth Floor Fifth Floor	23,645
Second Floor Third Floor	27,550 27,550
Ground Floor	28,265
Mezzanine	20,930
Basement	24,310

PROGRAM SUMMARY	
Residential Area	48,040
Restaurant Area	0
Commercial Area	2,465
Lobby & Amenity Area	3,130
Common Area	14,555
FAR Building Area	68,190
Garage Parking GSF	98,670
Storage & Utility Area	2,005
Total Building GSF	168,865

UNIT MIX					
	Studio	1 Bedroom	1 Bedroom +	2 Bedroom	Tota
Ground Floor	2	1	1	0	4
Second Floor	7	3	3	3	16
Third Floor	7	3	3	3	16
Fourth Floor	4	2	2	3	11
Fifth Floor	4	8	1	4	17
Total	24	17	10	13	64
Ratio	38%	27%	16%	20%	100%

BUILDING B				
	REQUIRED	PROPOSED	Compliant (Y/N/SP)	
Zoning District	B-2			
Overlay District	UJSD			
Use	Miced Use	Mixed Use ^a	Υ	
Lot Area / Size (Sq. Ft.)	N/A	17,812 s.f.	Υ	
Frontage (ft.)	N/A 197.45 ft.		Υ	
Lot Width (ft.)	N/A 197.45 ft.		Υ	
Lot Coverage	Max 80%	56%	Υ	
Front Yard Setback (ft.)	N/A	Modal	Υ	
Front Yard Setback (ft.) - <i>corner lots</i>	N/A	Modal	Υ	
Side Yard Setback (ft.)	N/A	37'-4" east ^b , 6'-7" west	Υ	
Rear Yard Setback (ft.)	N/A	1' - 10"	Υ	
Height (ft.) and # of Stories	3 Floors 40 ft.	4 Floors 48 ft. 7 in.	N	
Off-Street Parking Spaces	N/A	0 (+51 via easement @ Building A)		
Accessory Structure Setback	N/A N/A		Υ	
Landscaping	Refer to Landscape table	pe table Refer to Landscape table		
Floor Area Ratio	N/A	1.96	Υ	
FOOTNOTES a Permitted via Special Permit b 20'-1" setback from Herring	by the Planning Board and Board Run Brook	d of Zoning Appeals		

BUILDING GROSS SQUARE	
Ground Floor	10,330
Second Floor	10,355
Third Floor	10,355
Fourth Floor	7,755
Total Building GSF	38,795

Residential Area	25,430
Restaurant Area	4,285
Commercial Area	1,335
Lobby & Amenity Area	1,900
Common Area	5,845
FAR Building Area	36,230
Garage Parking GSF	(
Storage & Utility Area	2,565
Total Building GSF	38,795

UNIT MIX					
	Studio	1 Bedroom	1 Bedroom +	2 Bedroom	Total
Ground Floor	0	0	0	0	0
Second Floor	8	3	4	0	15
Third Floor	8	3	4	0	15
Fourth Floor	8	4	0	0	12
Fifth Floor	n/a	n/a	n/a	n/a	0
Total	24	10	8	0	42
Ratio	57%	24%	19%	0%	100%

BUILDING C					
	REQUIRED	PROPOSED	Complian (Y/N/SP)		
Zoning District	B-2				
Overlay District	LJSD		1		
Use	Mixed Use	Mixed Use ^a	Υ		
Lot Area / Size (Sq. Ft.)	N/A	26,522 s.f.	Y		
Frontage (ft.)	N/A 225.69 ft.		Υ		
Lot Width (ft.)	N/A 225.69		Υ		
Lot Coverage	Max 80% 77%		Y		
Front Yard Setback (ft.)	N/A	Modal	Υ		
Front Yard Setback (ft.) - corner lots	N/A	Modal	Y		
Side Yard Setback (ft.)	20 & N/A	20'-0" southe, 7'-6" east, 5'- 8" west	Y		
Rear Yard Setback (ft.)	N/A	N/A (corner)	Υ		
Height (ft.) and # of Stories	5 Floors 60 ft. ^d 5 Floors 58 ft. 7 in.		SP		
Off-Street Parking Spaces	N/A 28 (+47 via easement@ Building A)		Υ		
Accessory Structure Setback	N/A	N/A			
Landscaping	Refer to Landscape table	Refer to Landscape table	Υ		
Floor Area Ratio	N/A	2.68	Y		
	by the Planning Board and Board have been included. Refer to pla				
c Refer to "total project" parki	ng counts on separate chart. Il Permit in LJSD with Afforable D				

BUILDING GROSS SQUARE FOOTAGE		
Ground Floor	17,53	
Second Floor	16,78	
Third Floor	16,78	
Fourth Floor	12,69	
Fifth Floor	10,61	
Total Building GSF	74,39	

Residential Area	45,865
Restaurant Area	2,030
Commercial Area	1,320
Lobby & Amenity Area	4,690
Common Area	20,490
FAR Building Area	61,340
Garage Parking GSF	11,200
Storage & Utility Area	1,855
Total Building GSF	74,395


	Studio	1 Bedroom	1 Bedroom +	2 Bedroom	Tot
Ground Floor	0	0	0	0	
Second Floor	8	5	1	5	1
Third Floor	8	5	1	5	1
Fourth Floor	6	4	3	2	1
Fifth Floor	0	6	1	3	1
Total	22	20	6	15	6
Ratio	35%	32%	10%	24%	100

	BUILDING I)	
	REQUIRED	PROPOSED	Compliant (Y/N/SP)
Zoning District	B-2		
Overlay District	LJSD		
Use	Mixed Use	Mixed Use ^a	Y
Lot Area / Size (Sq. Ft.)	N/A	9,842 s.f.	Y
Frontage (ft.)	N/A	80.30 ft.	Y
Lot Width (ft.)	N/A	80.30 ft.	Y
Lot Coverage	Max 80%	70%	Y
Front Yard Setback (ft.)	N/A	Modal	Y
Front Yard Setback (ft.) - <i>corner lots</i>	N/A	N/A	Y
Side Yard Setback (ft.)		5'-3" east, 6'-7" west	Y
Rear Yard Setback (ft.)	N/A	0'-6"	Y
Height (ft.) and # of Stories	5 Floors 60 ft.d	5 Floors 50 ft. 1 in.	SP
Off-Street Parking Spaces	N/A	13 (+35 via easement @ Building A)	Y
Accessory Structure Setback	N/A	N/A	Y
Landscaping	Refer to Landscape table	Refer to Landscape table	Y
Floor Area Ratio	N/A	2.57	î Y
FOOTNOTES			•
	by the Planning Board and Board	of Zoning Appeals	
	as been included. Refer to plans.		
c Refer to "total project" parkin	ng counts on separate chart. I Permit in LJSD with Afforable De	i+ . D (i- 100/)	

Ground Floor	6,915
Second Floor	7,045
Third Floor	7,045
Fourth Floor	5,330
Fifth Floor	4,695
Total Building GSF	31,030

Residential Area	21,0
Restaurant Area	
Commercial Area	4
Lobby & Amenity Area	2
Common Area	9,2
FAR Building Area	25,2
Garage Parking GSF	5,1
Storage & Utility Area	5
Total Building GSF	31,0

	Studio	1 Bedroom	1 Bedroom +	2 Bedroom	Total
Ground Floor	0	0	0	0	
Second Floor	4	2	2	1	
Third Floor	4	2	2	1	
Fourth Floor	4	2	0	1	
Fifth Floor	1	5	0	0	
Total	13	11	4	3	3
Ratio	42%	35%	13%	10%	1009

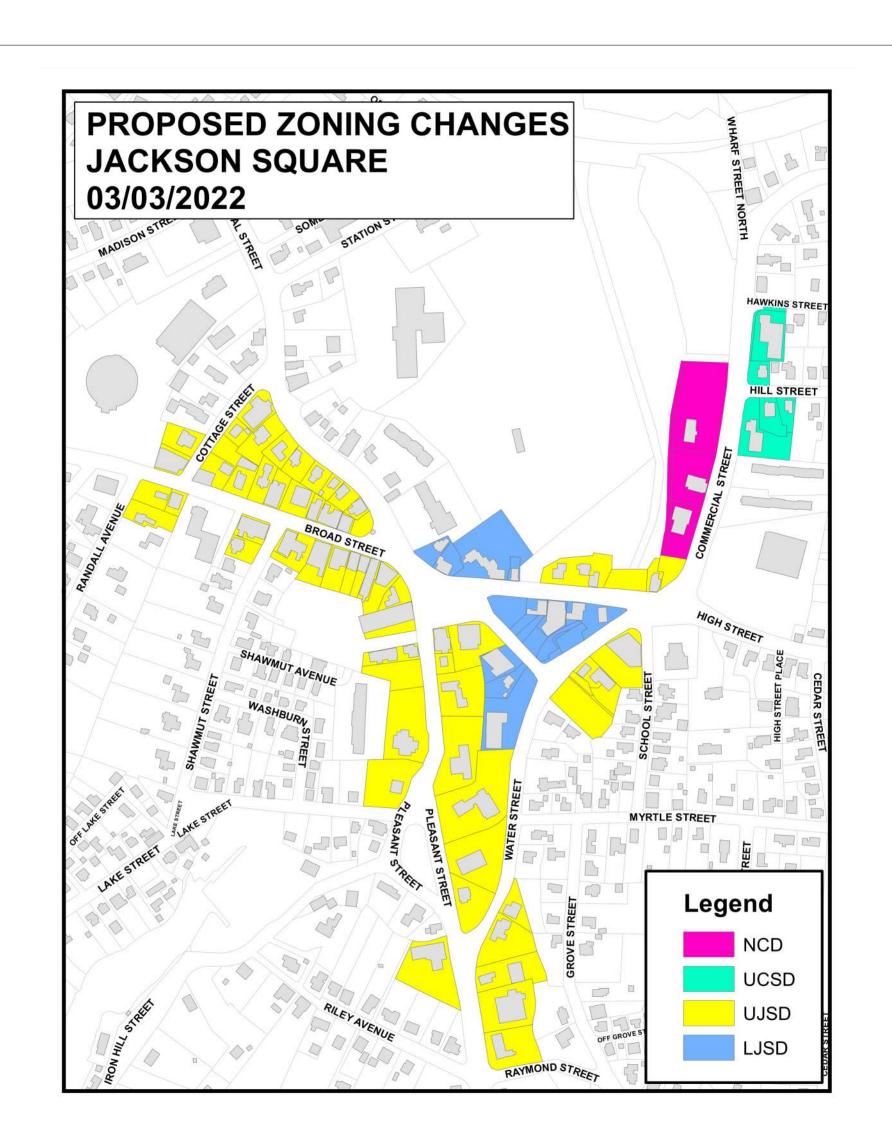

OTAL CROSS COLLARS FOOTAGE					
TOTAL GROSS SQUARE FO	OTAGE	20		52	
	Building A	Building B	Buildings C	Building D	Total
Basement	24,310	n/a	n/a	n/a	24,310
Mezzanine	20,930	n/a	n/a	n/a	20,930
Ground Floor	28,265	10,330	17,530	6,915	63,040
Second Floor	27,550	10,355	16,780	7,045	61,730
Third Floor	27,550	10,355	16,780	7,045	61,730
Fourth Floor	23,645	7,755	12,695	5,330	49,425
Fifth Floor	16,615	n/a	10,610	4,695	31,920
Total Building GSF	168,865	38,795	74,395	31,030	313,085

TOTAL UNIT MIX	or			
	Count	Avg SF	Ratio	Req Spaces
Studio	83	550	41.5%	83
1 Bedroom	58	690	29%	87
1 Bedroom +	28	820	14%	42
2 Bedroom	31	1025	15.5%	47
Total	200	702	100%	259

TOTAL PROGRAM SUMMARY	
Residential Area	140,350
Restaurant Area	6,315
Commercial Area	5,610
Lobby & Amenity Area	9,980

Total Ground Floor Area	23,490
Ground Floor Commercial Area	11,925
Grond Floor Commercial Ratio	51%

SQUARE F	OOTAGE	·		6	
	Building A	Building B	Buildings C	Building D	Total
	24,310	n/a	n/a	n/a	24,310
	20,930	n/a	n/a	n/a	20,930
	28,265	10,330	17,530	6,915	63,040
	27,550	10,355	16,780	7,045	61,730
	27,550	10,355	16,780	7,045	61,730
	23,645	7,755	12,695	5,330	49,425
	16,615	n/a	10,610	4,695	31,920
GSF	168,865	38,795	74,395	31,030	313,085

*100 Seats	
	at the same terms

tal Ground Floor Area	23,490
ound Floor Commercial Area	11,925
ond Floor Commercial Ratio	51%

OTAL PARKING SUMMARY	
otal Off-Street Spaces	259
Garage Spaces	259
Surface Spaces	0
otal Required Spaces	289
Required Residential	259
Required Commercial	40
75% Commercial	30
otal Bicycle Spaces	13

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CMK DEVELOPMENT PARTNERS 97 LIBBEY PARKWAY SUITE 304 WEYMOUTH, MA 02189

CONSULTANTS


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LANDSCAPEMDLA

840 SUMMER STREET SUITE #201A BOSTON, MA 02127

DRAWING TITLE PROGRAM AND ZONING

ANALYSIS DRAWING NUMBER

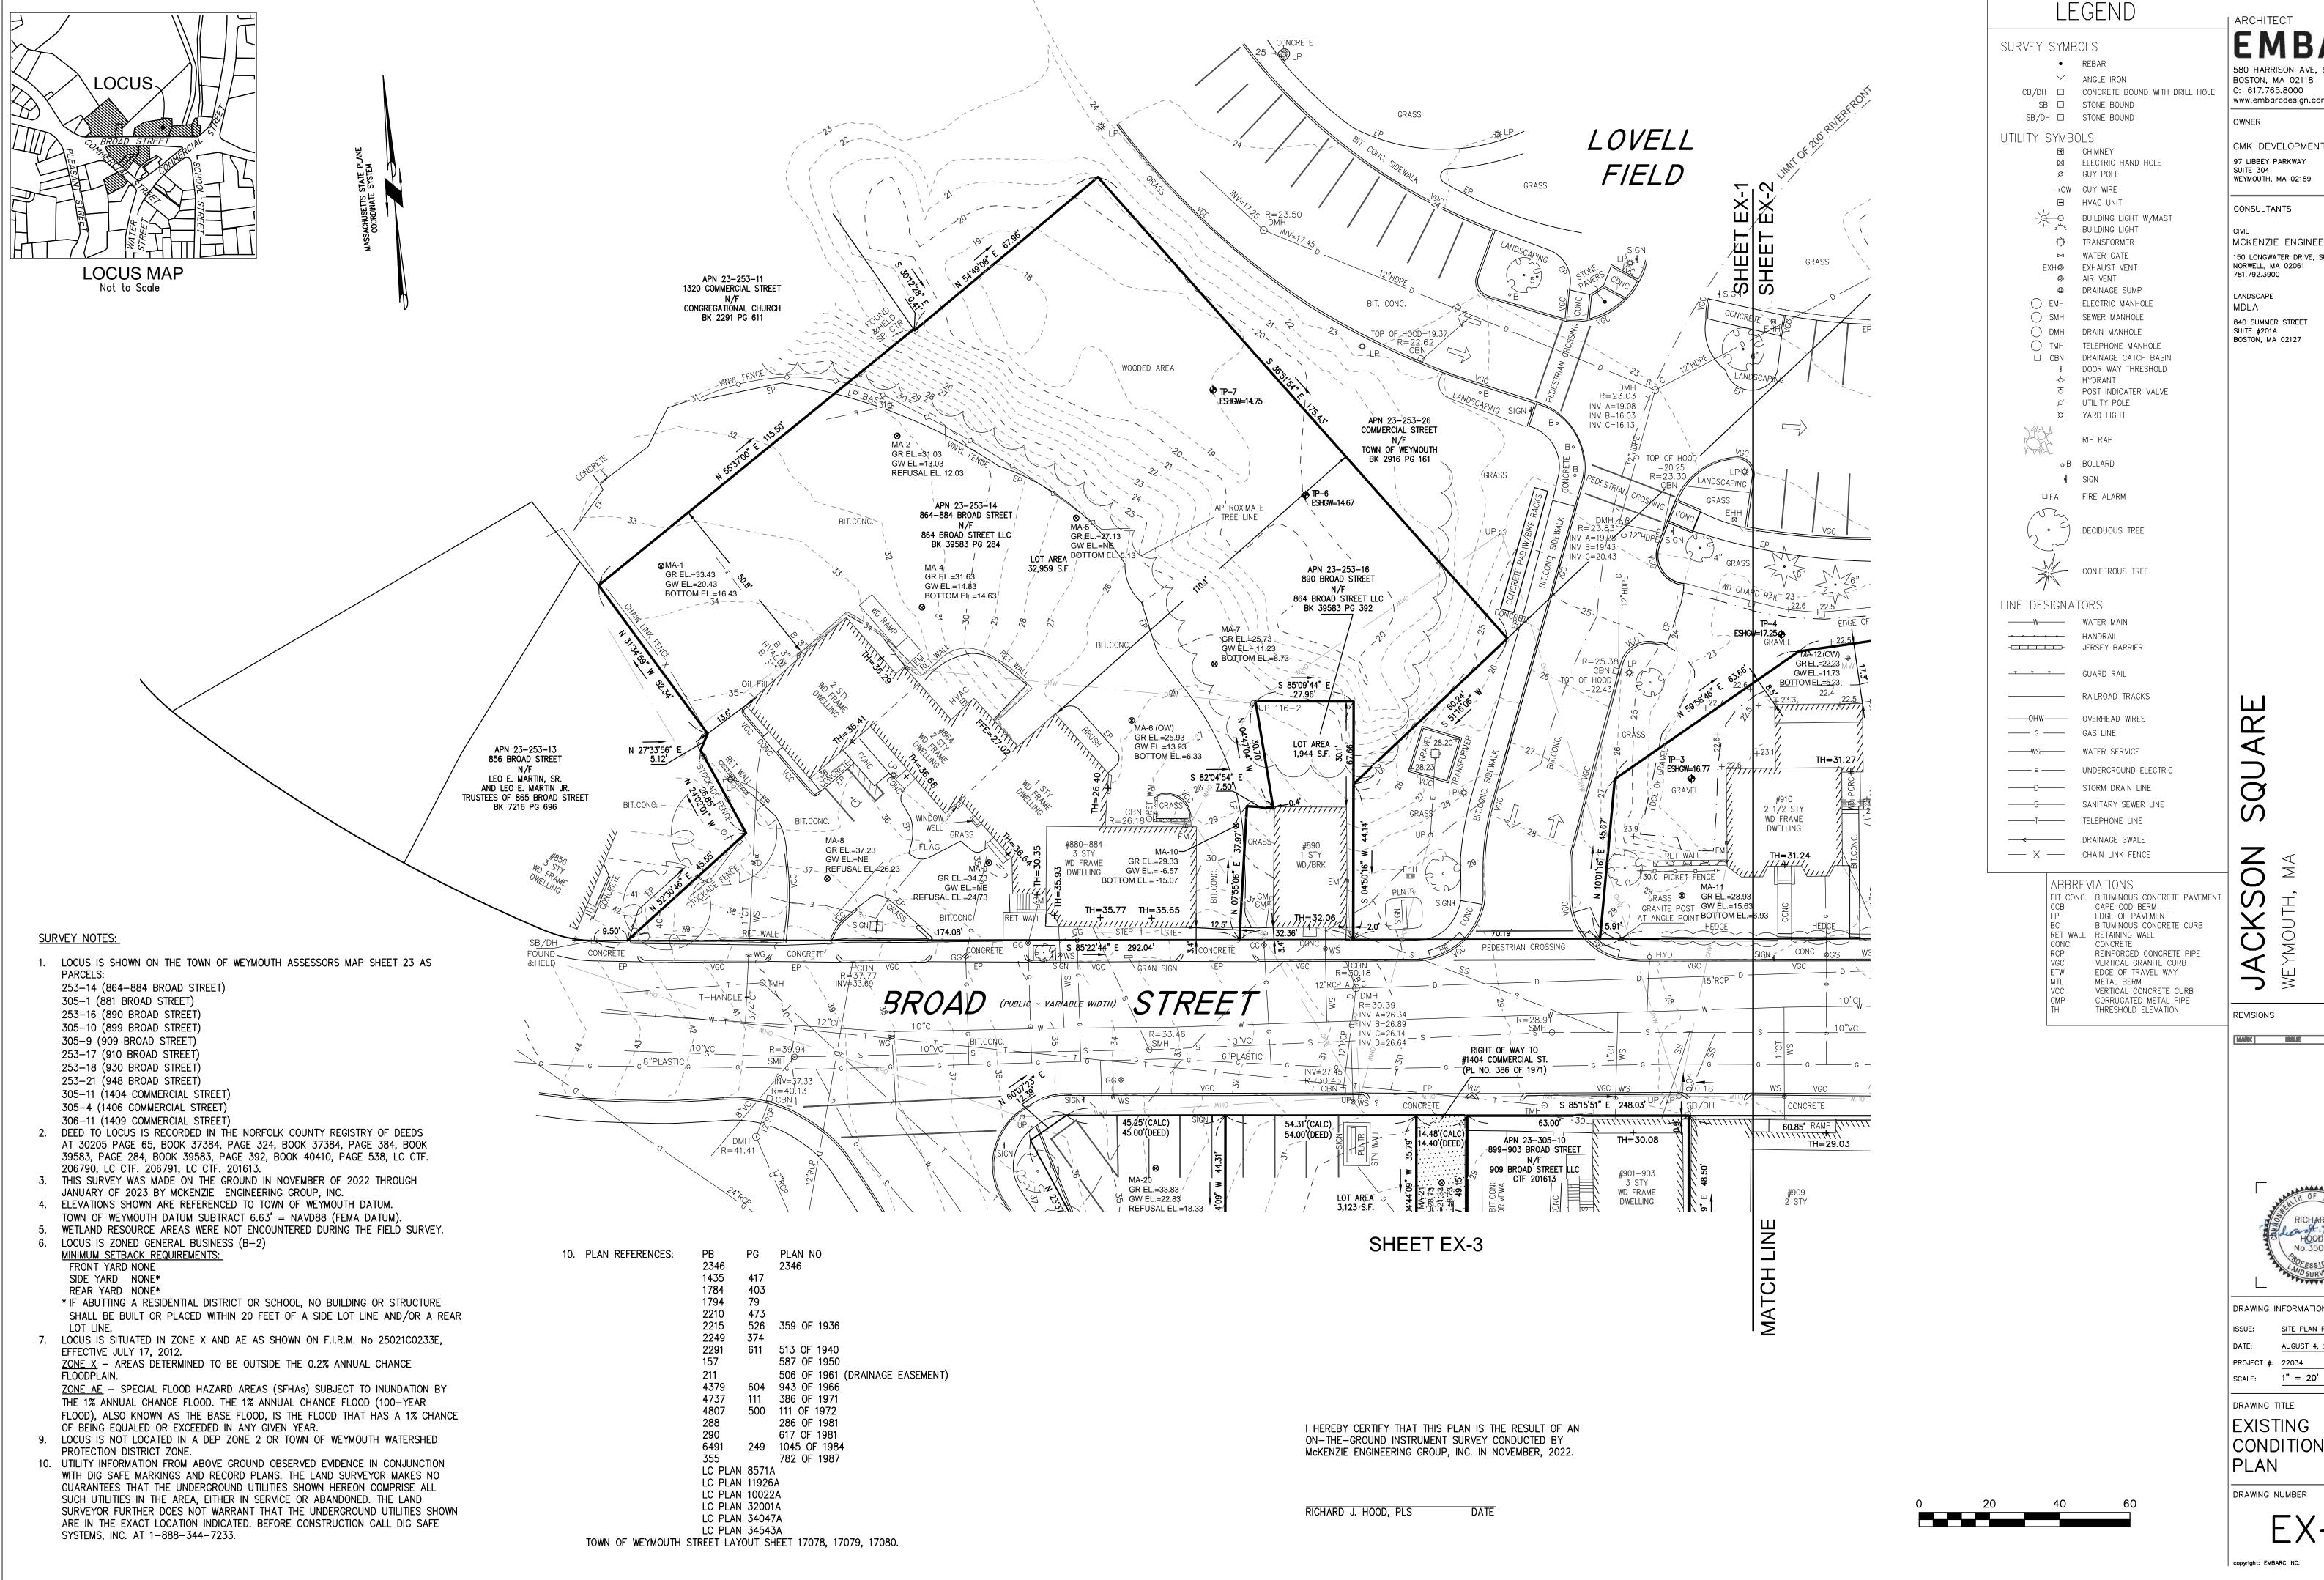

ARCHITECT

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781.792.3900 LANDSCAPE

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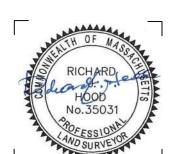
MARK ISSUE DATE

REVIEW

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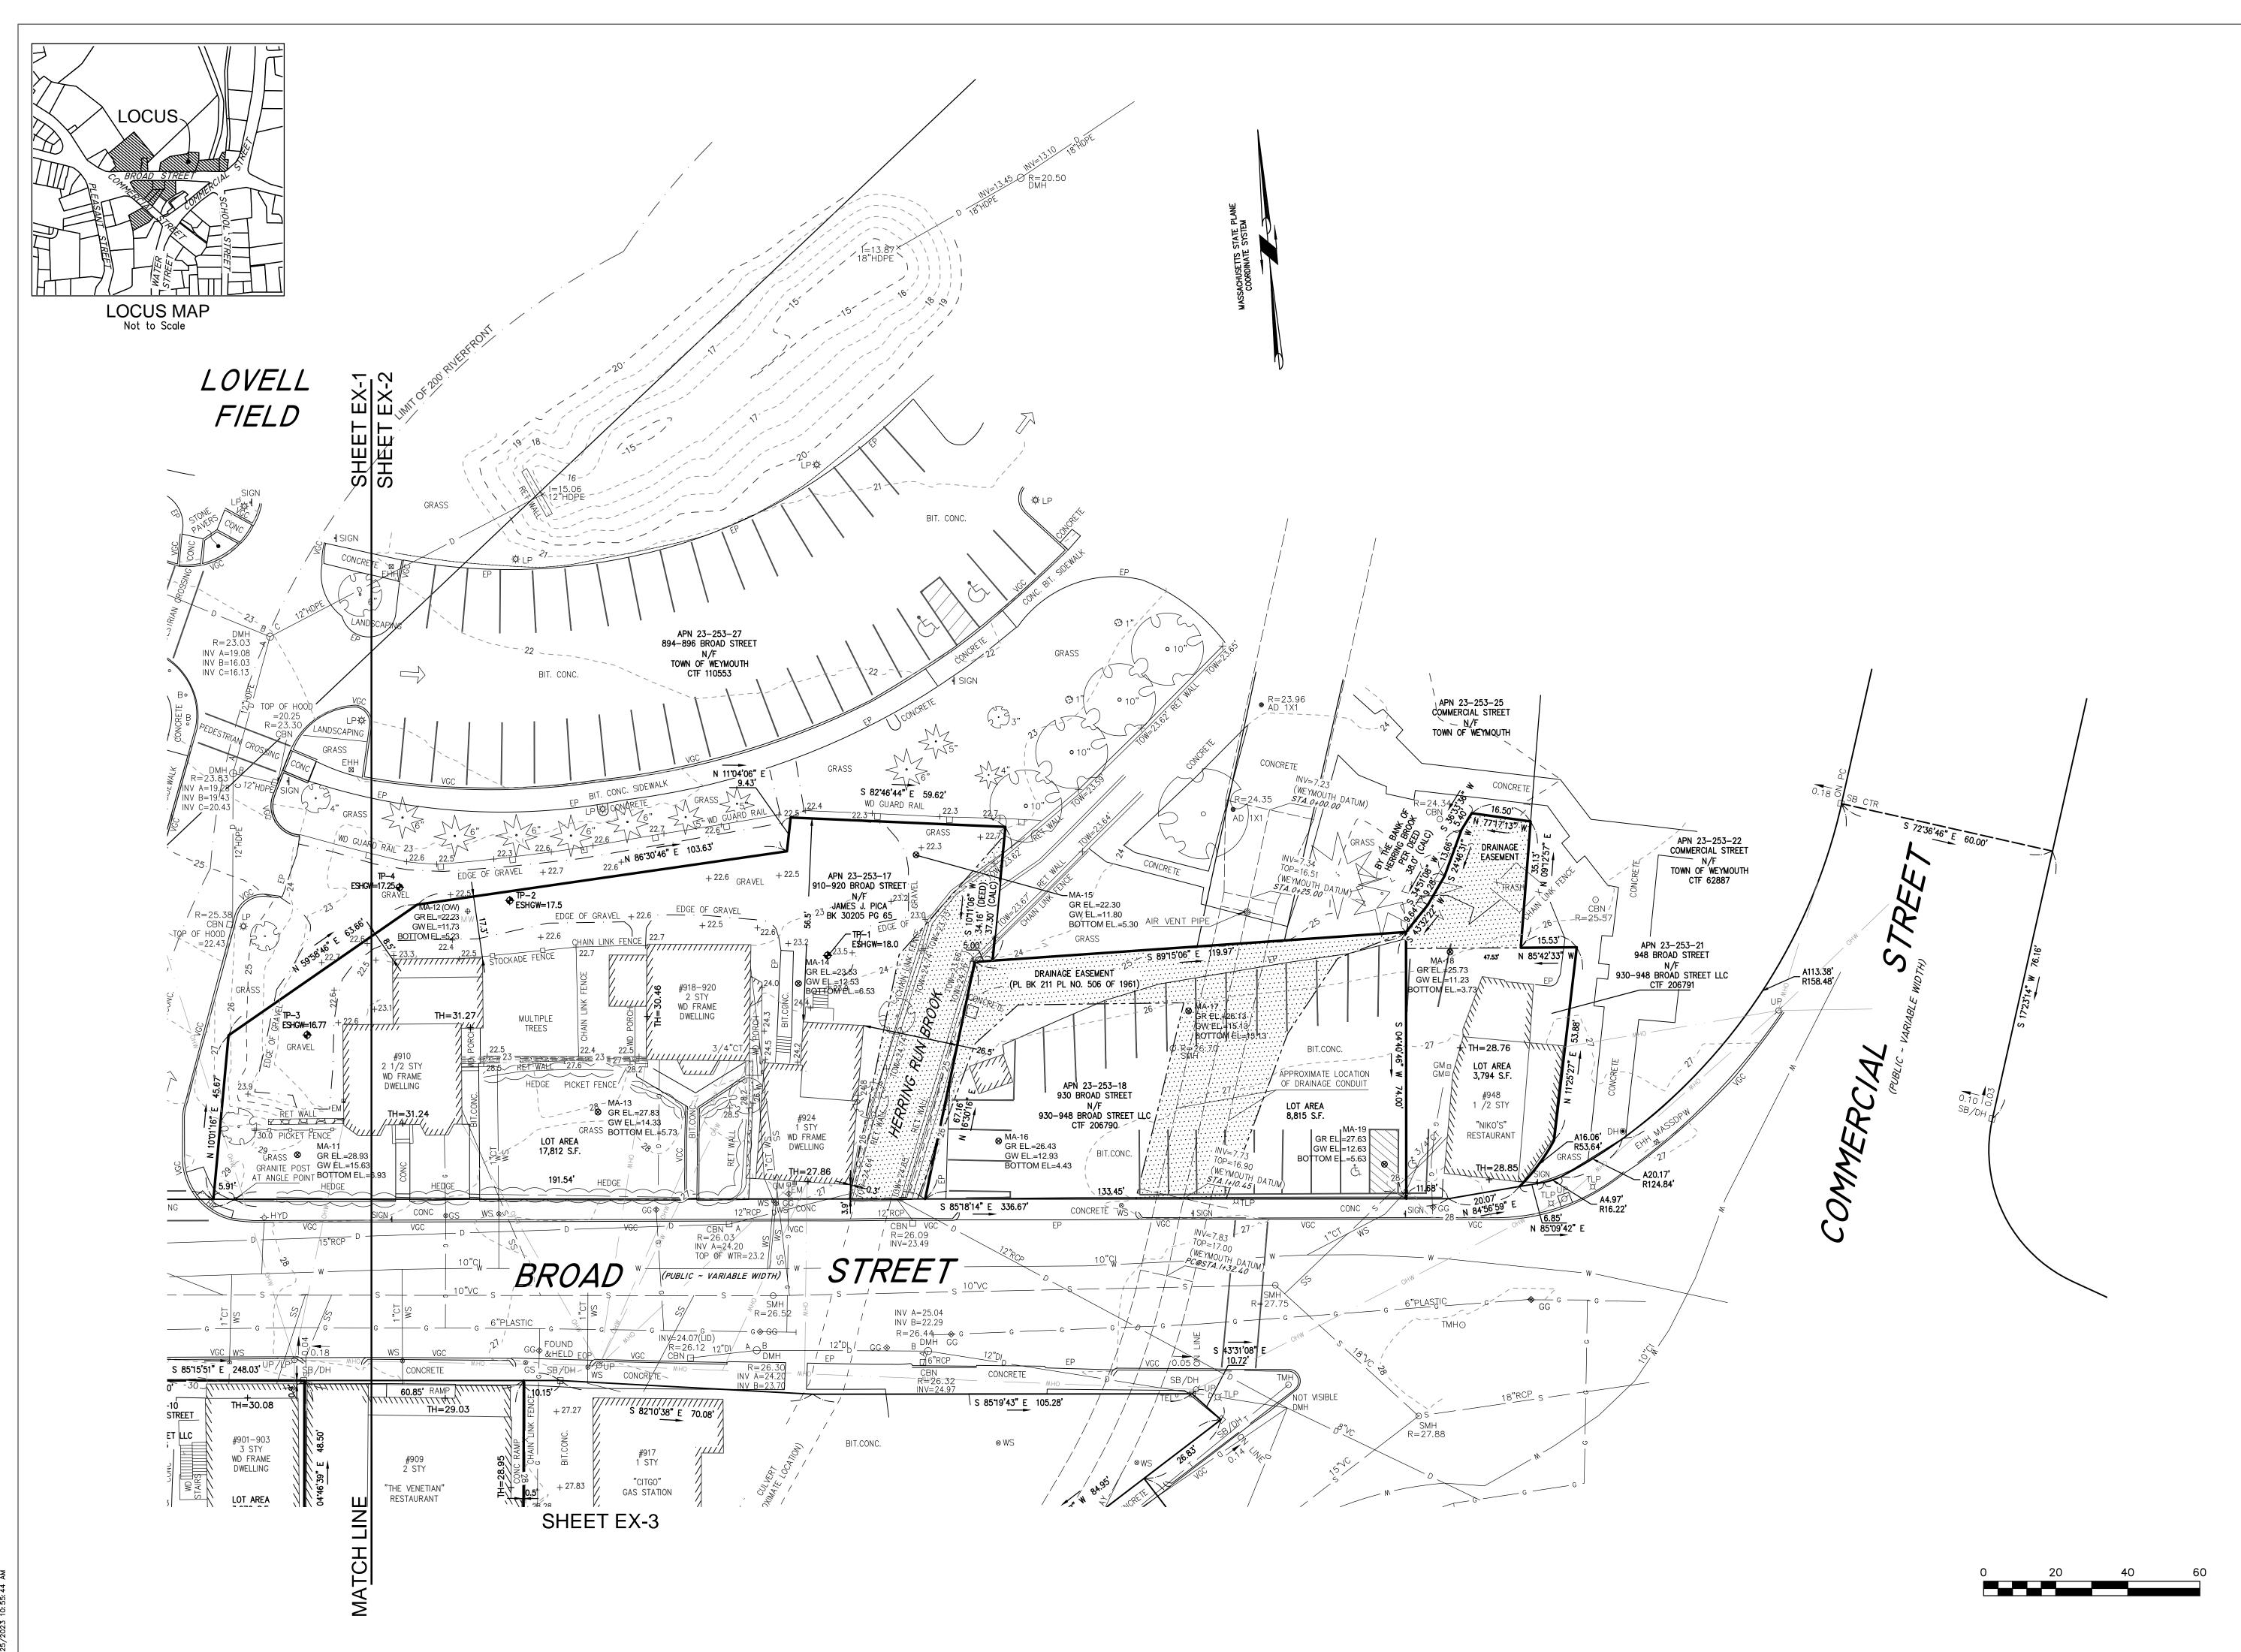
DRAWING INFORMATION

SITE PLAN REVIEW AUGUST 4, 2023 PROJECT #: 22034

DRAWING TITLE

EXISTING CONDITIONS PLAN

DRAWING NUMBER



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PLAN REVIEW

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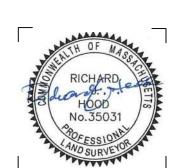
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DRAWING INFORMATION

ISSUE: SITE PLAN REVIEW

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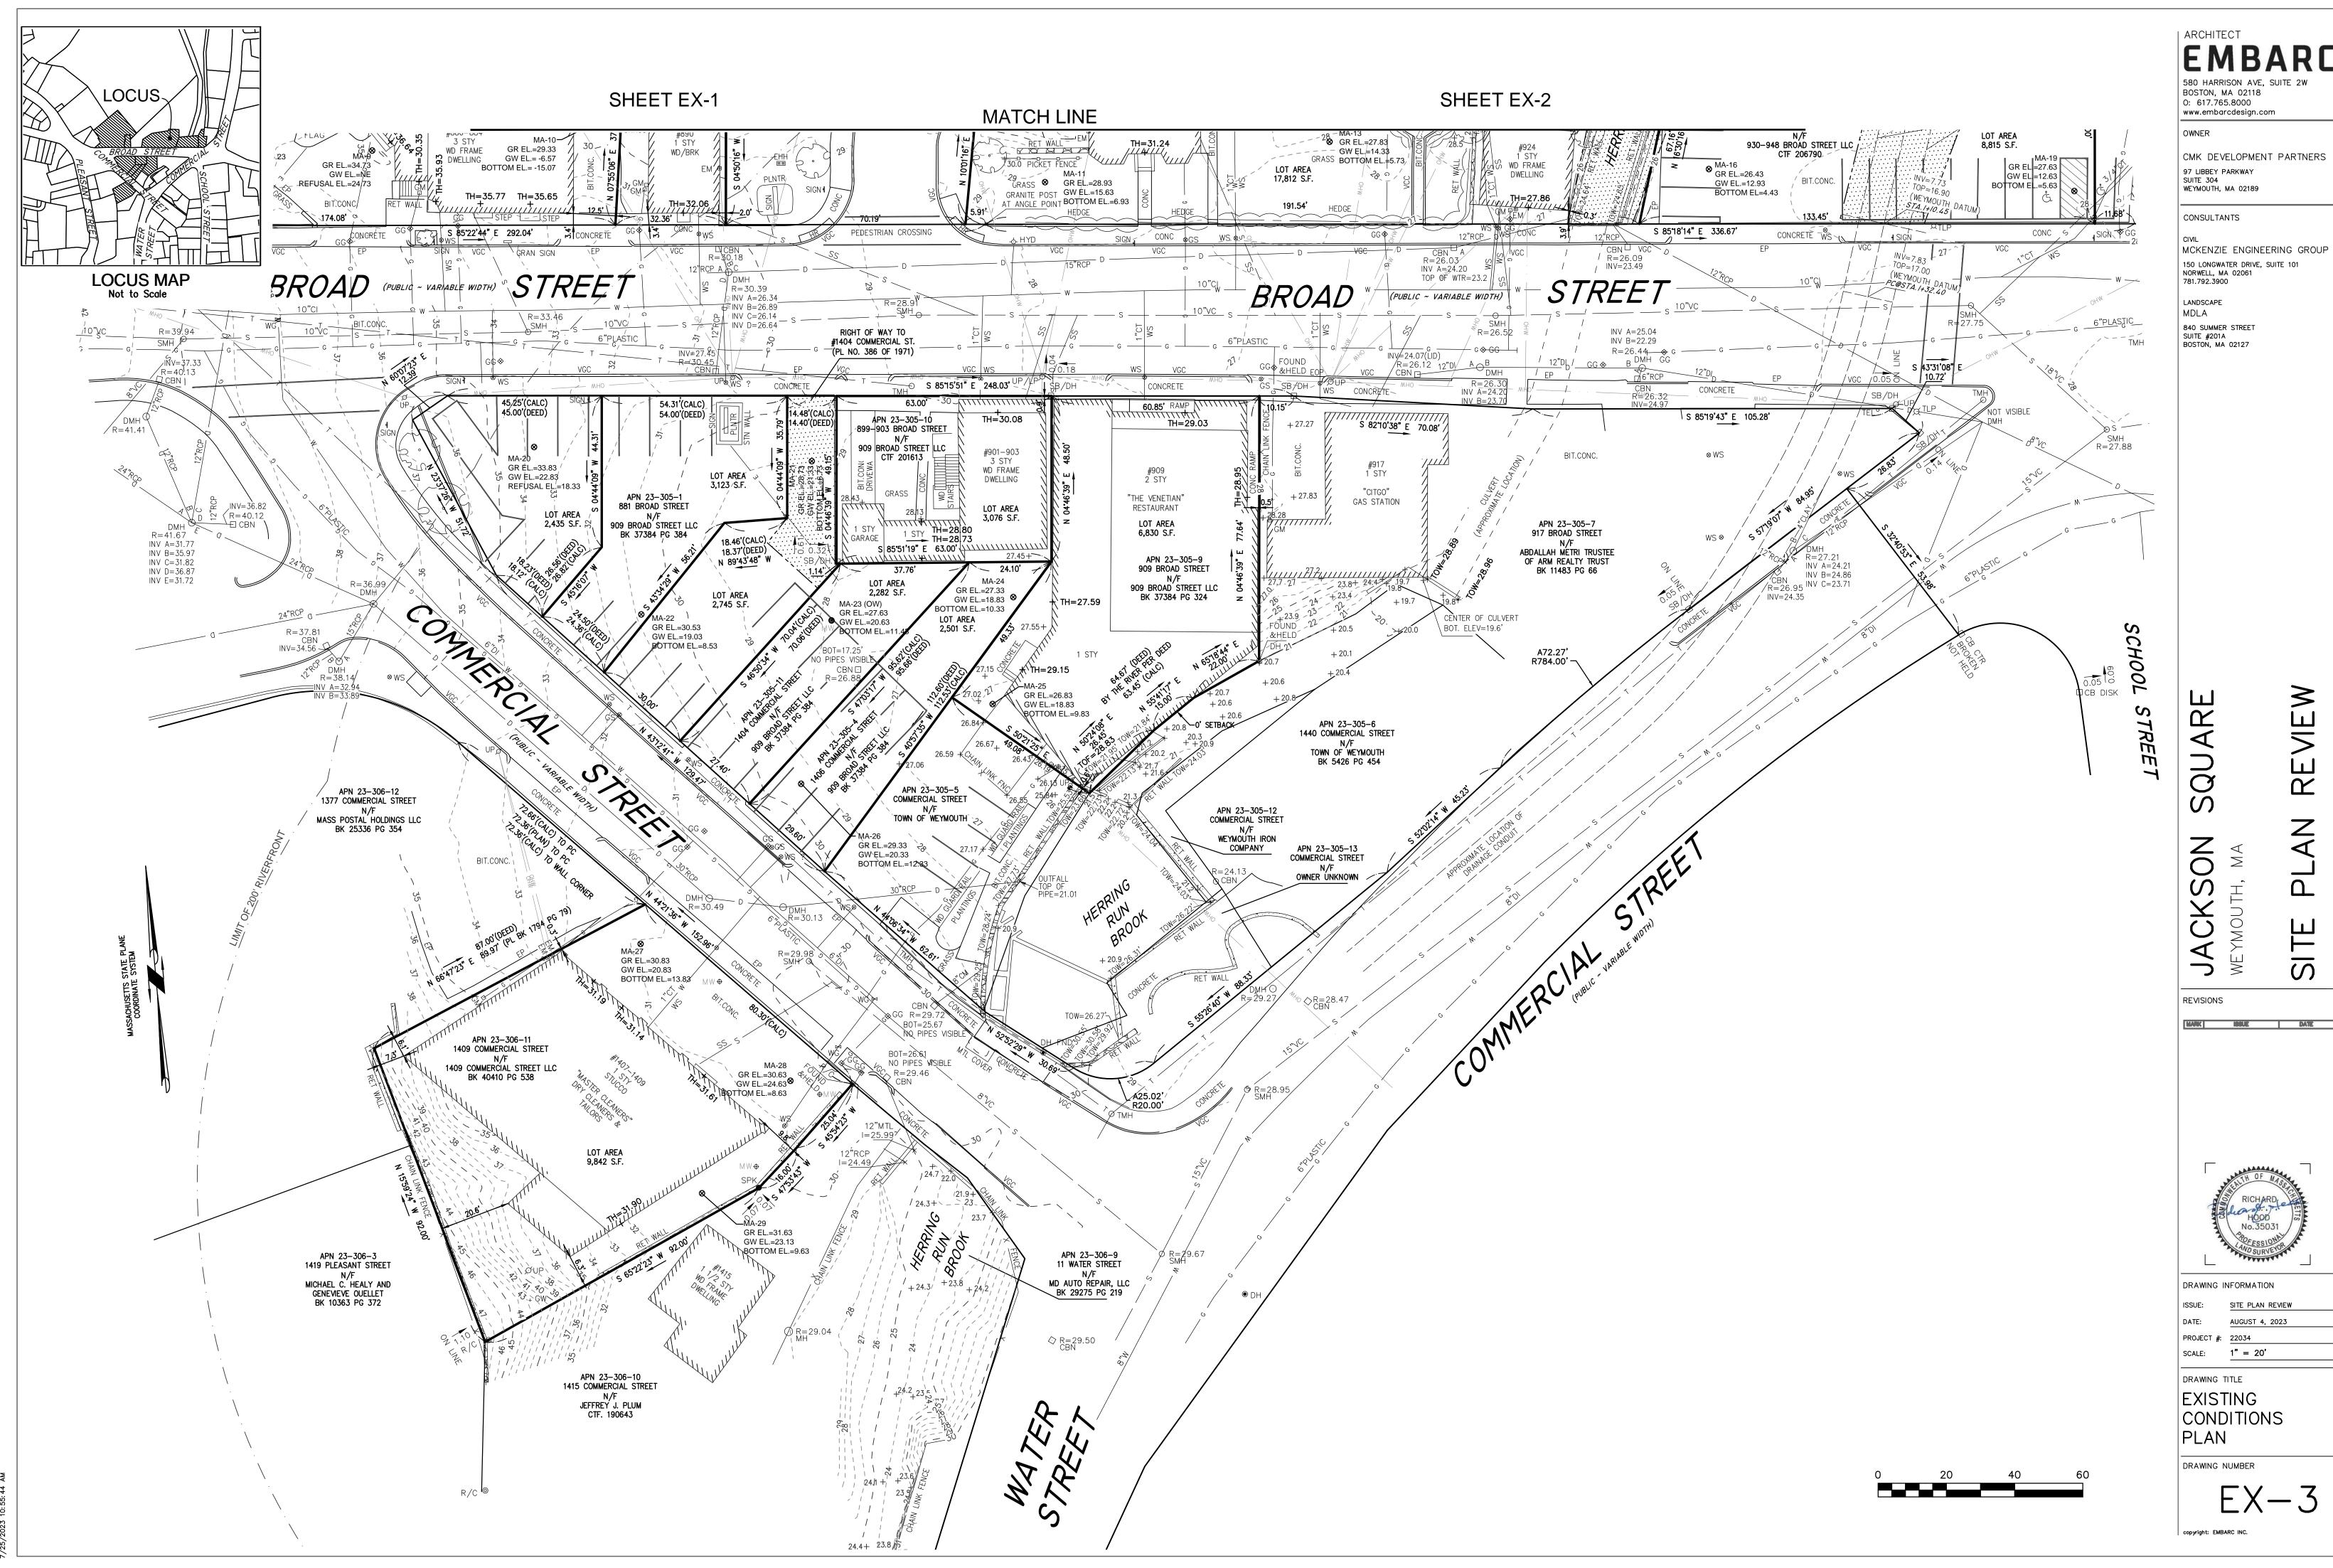
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SCALE: 1" = 20'


EXISTING CONDITIONS PLAN


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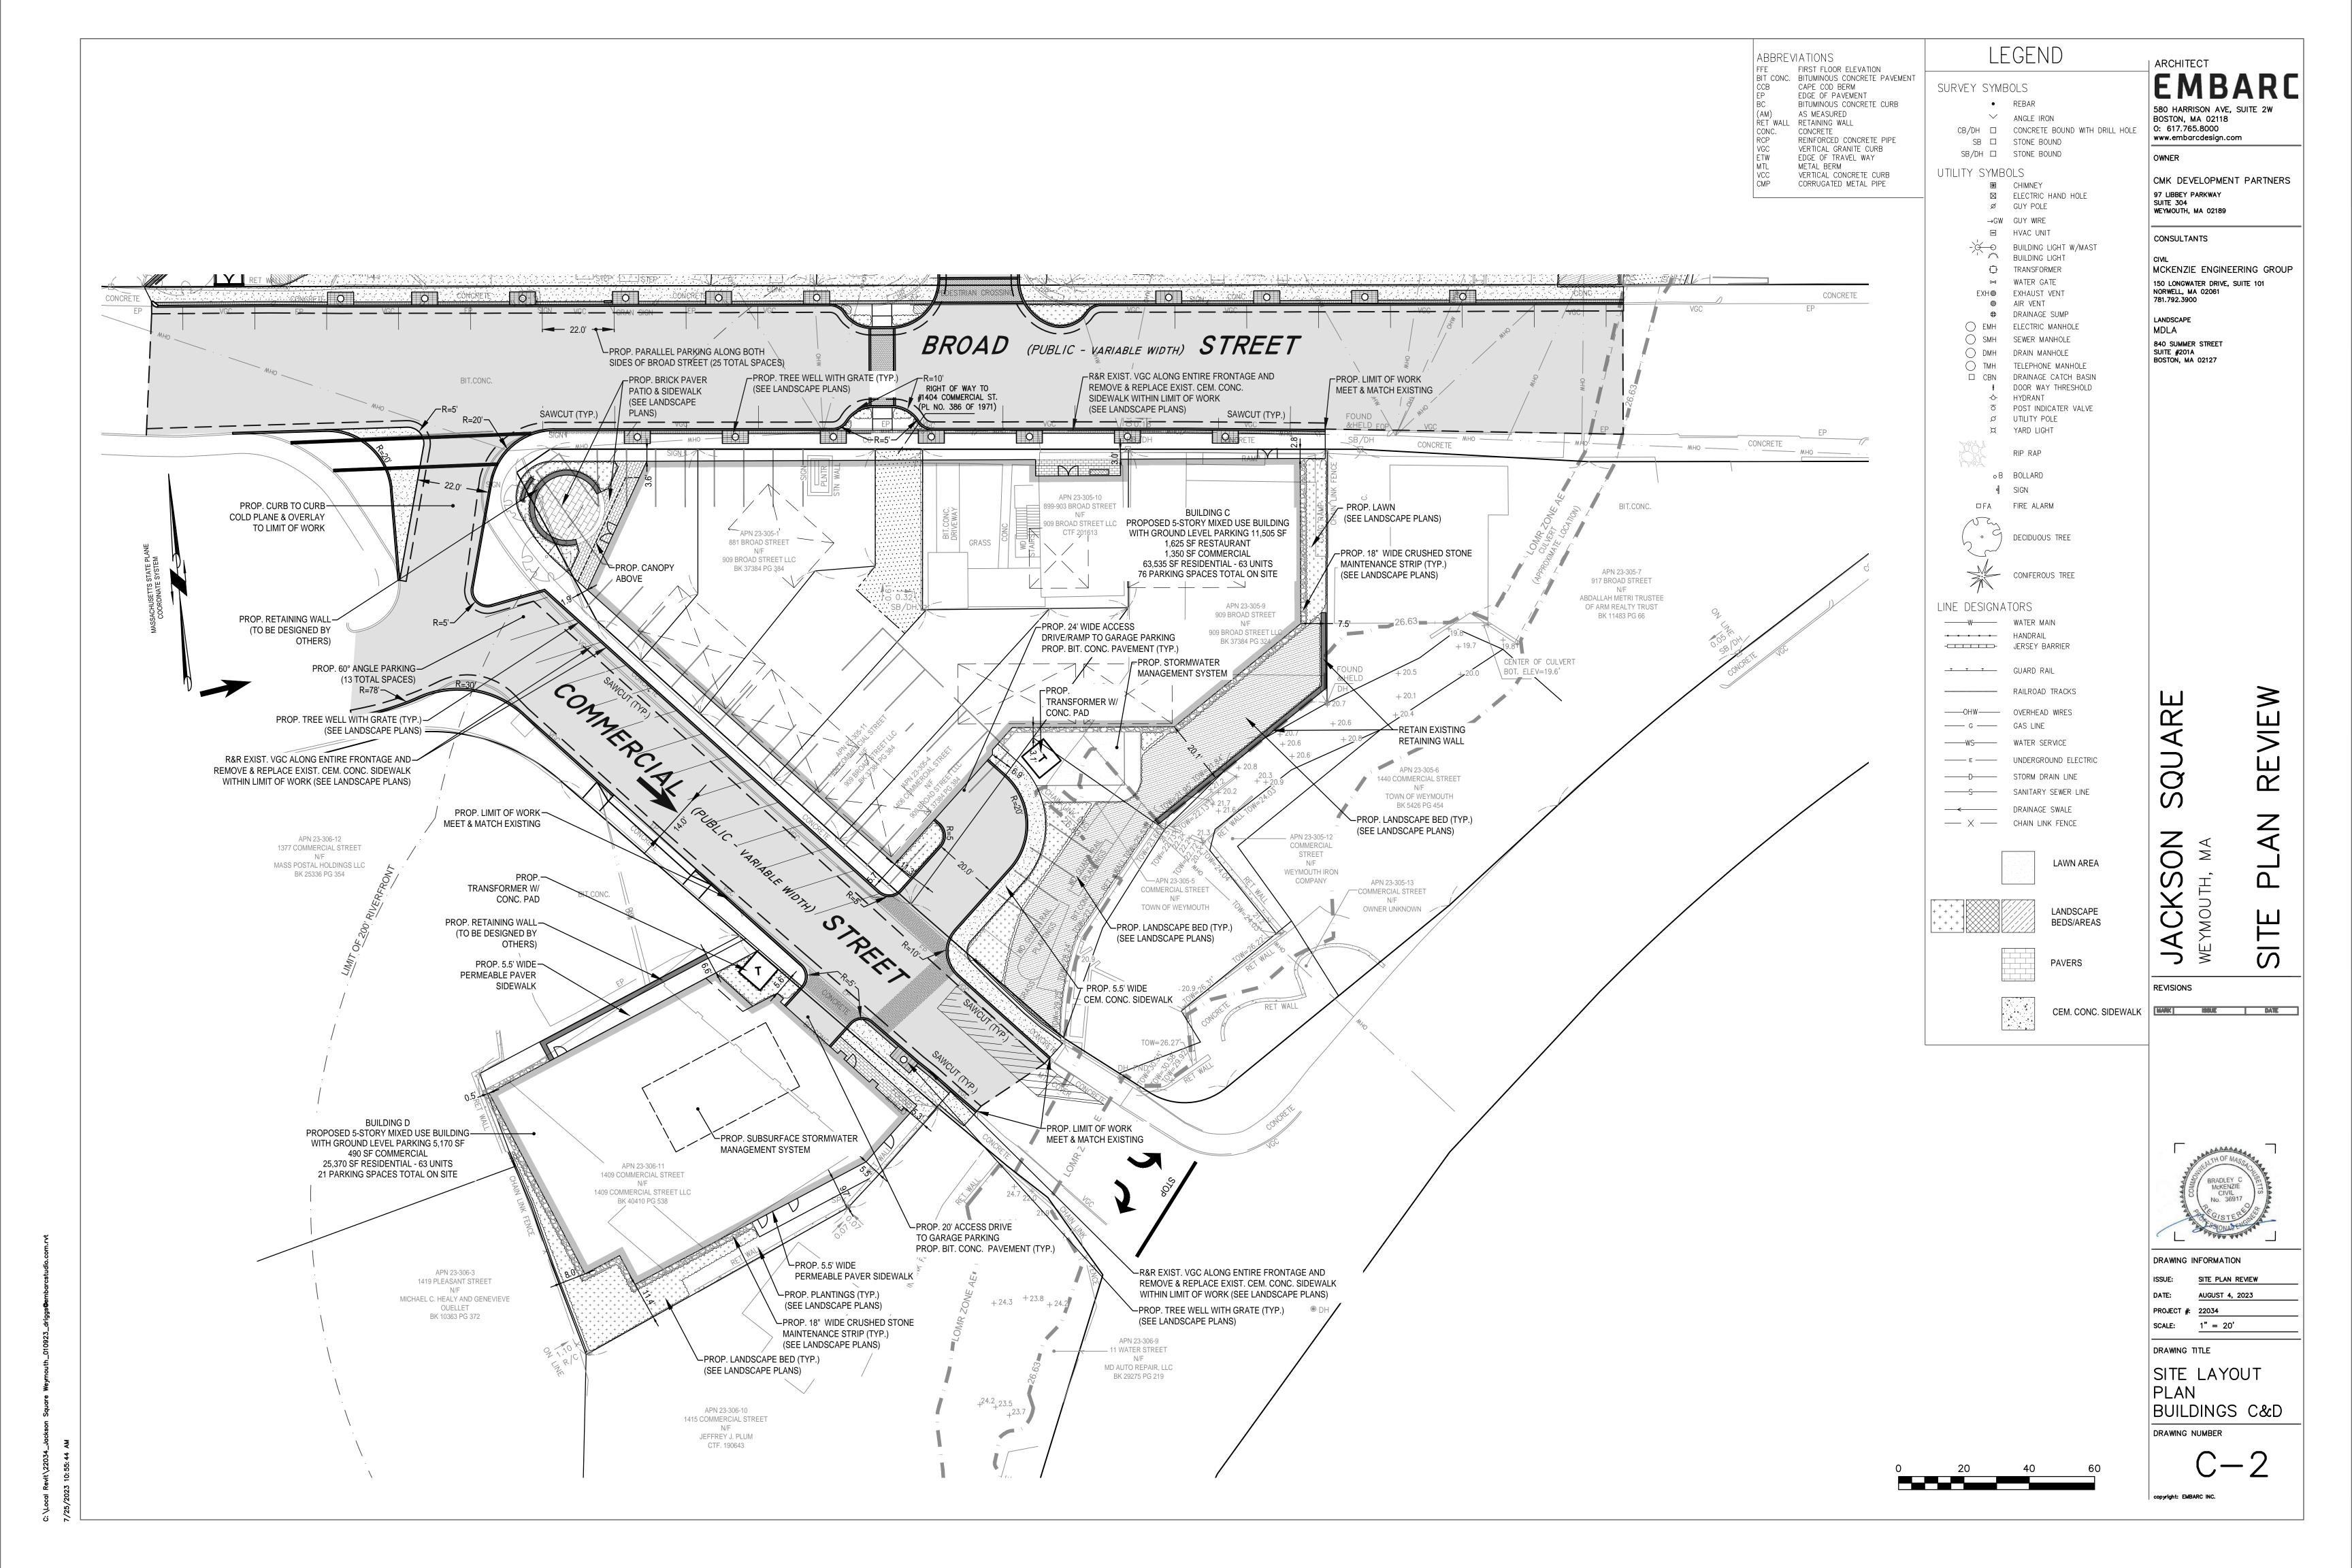
EX-2




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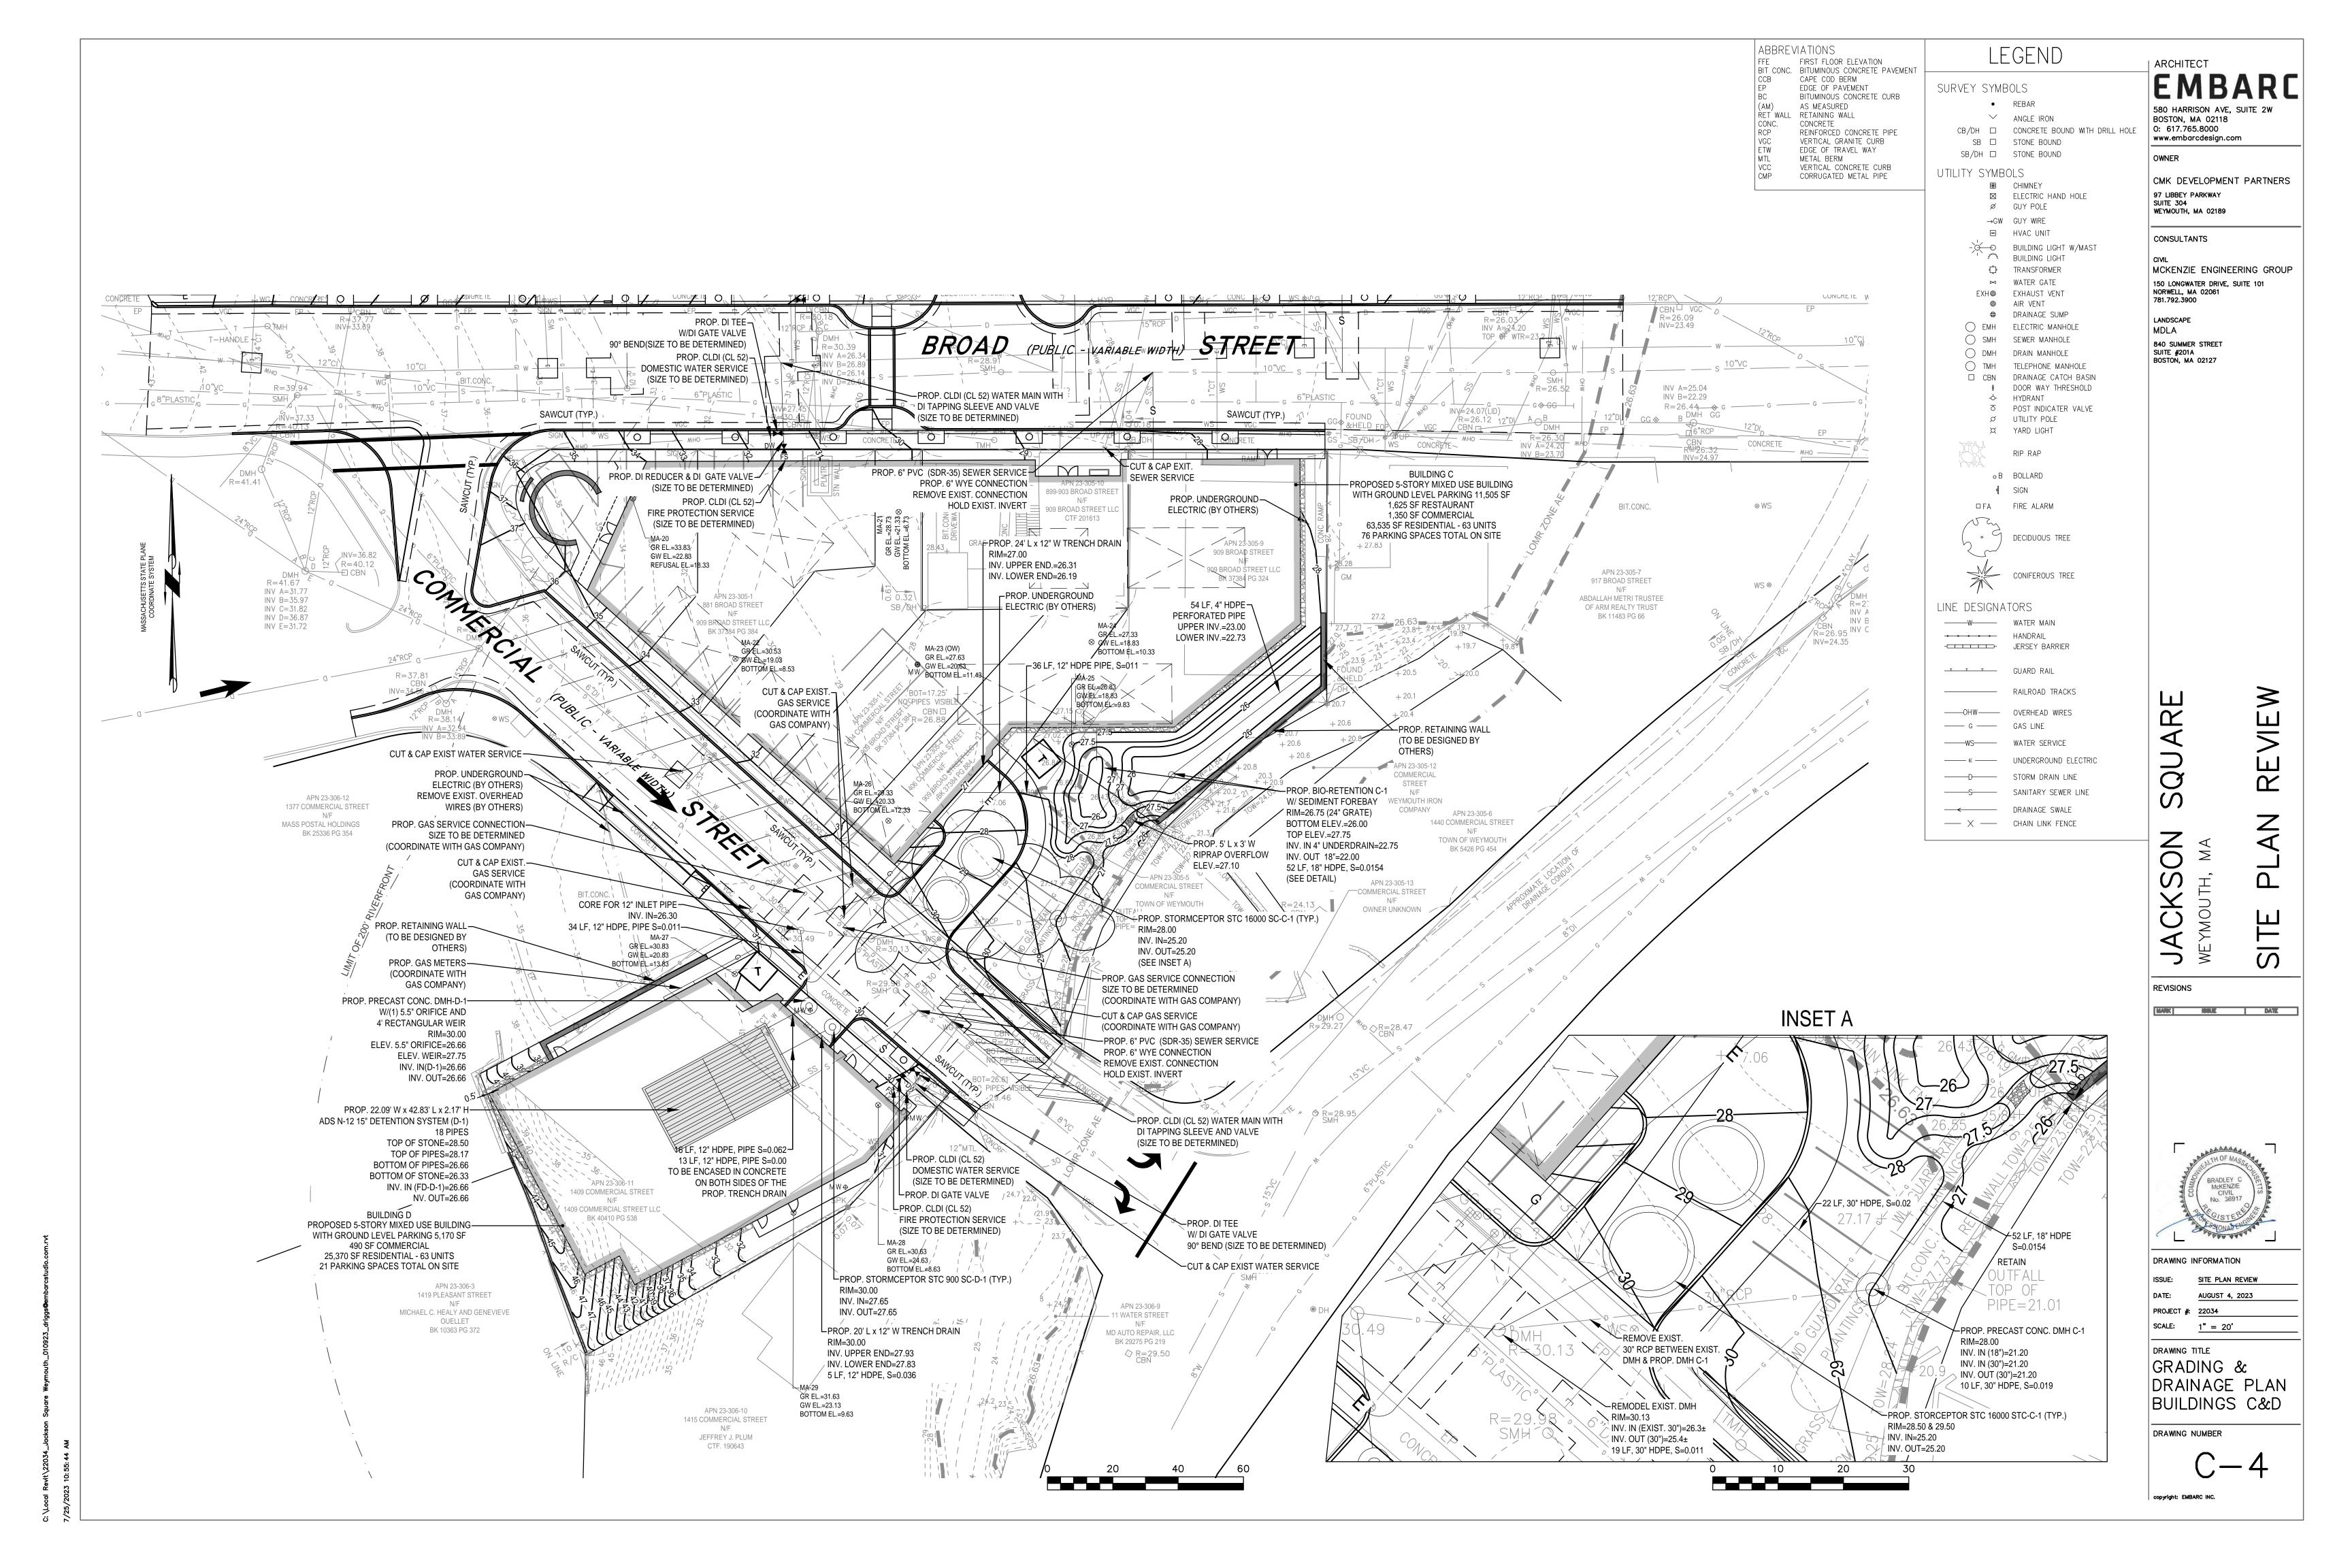




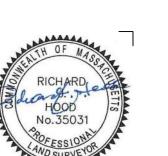

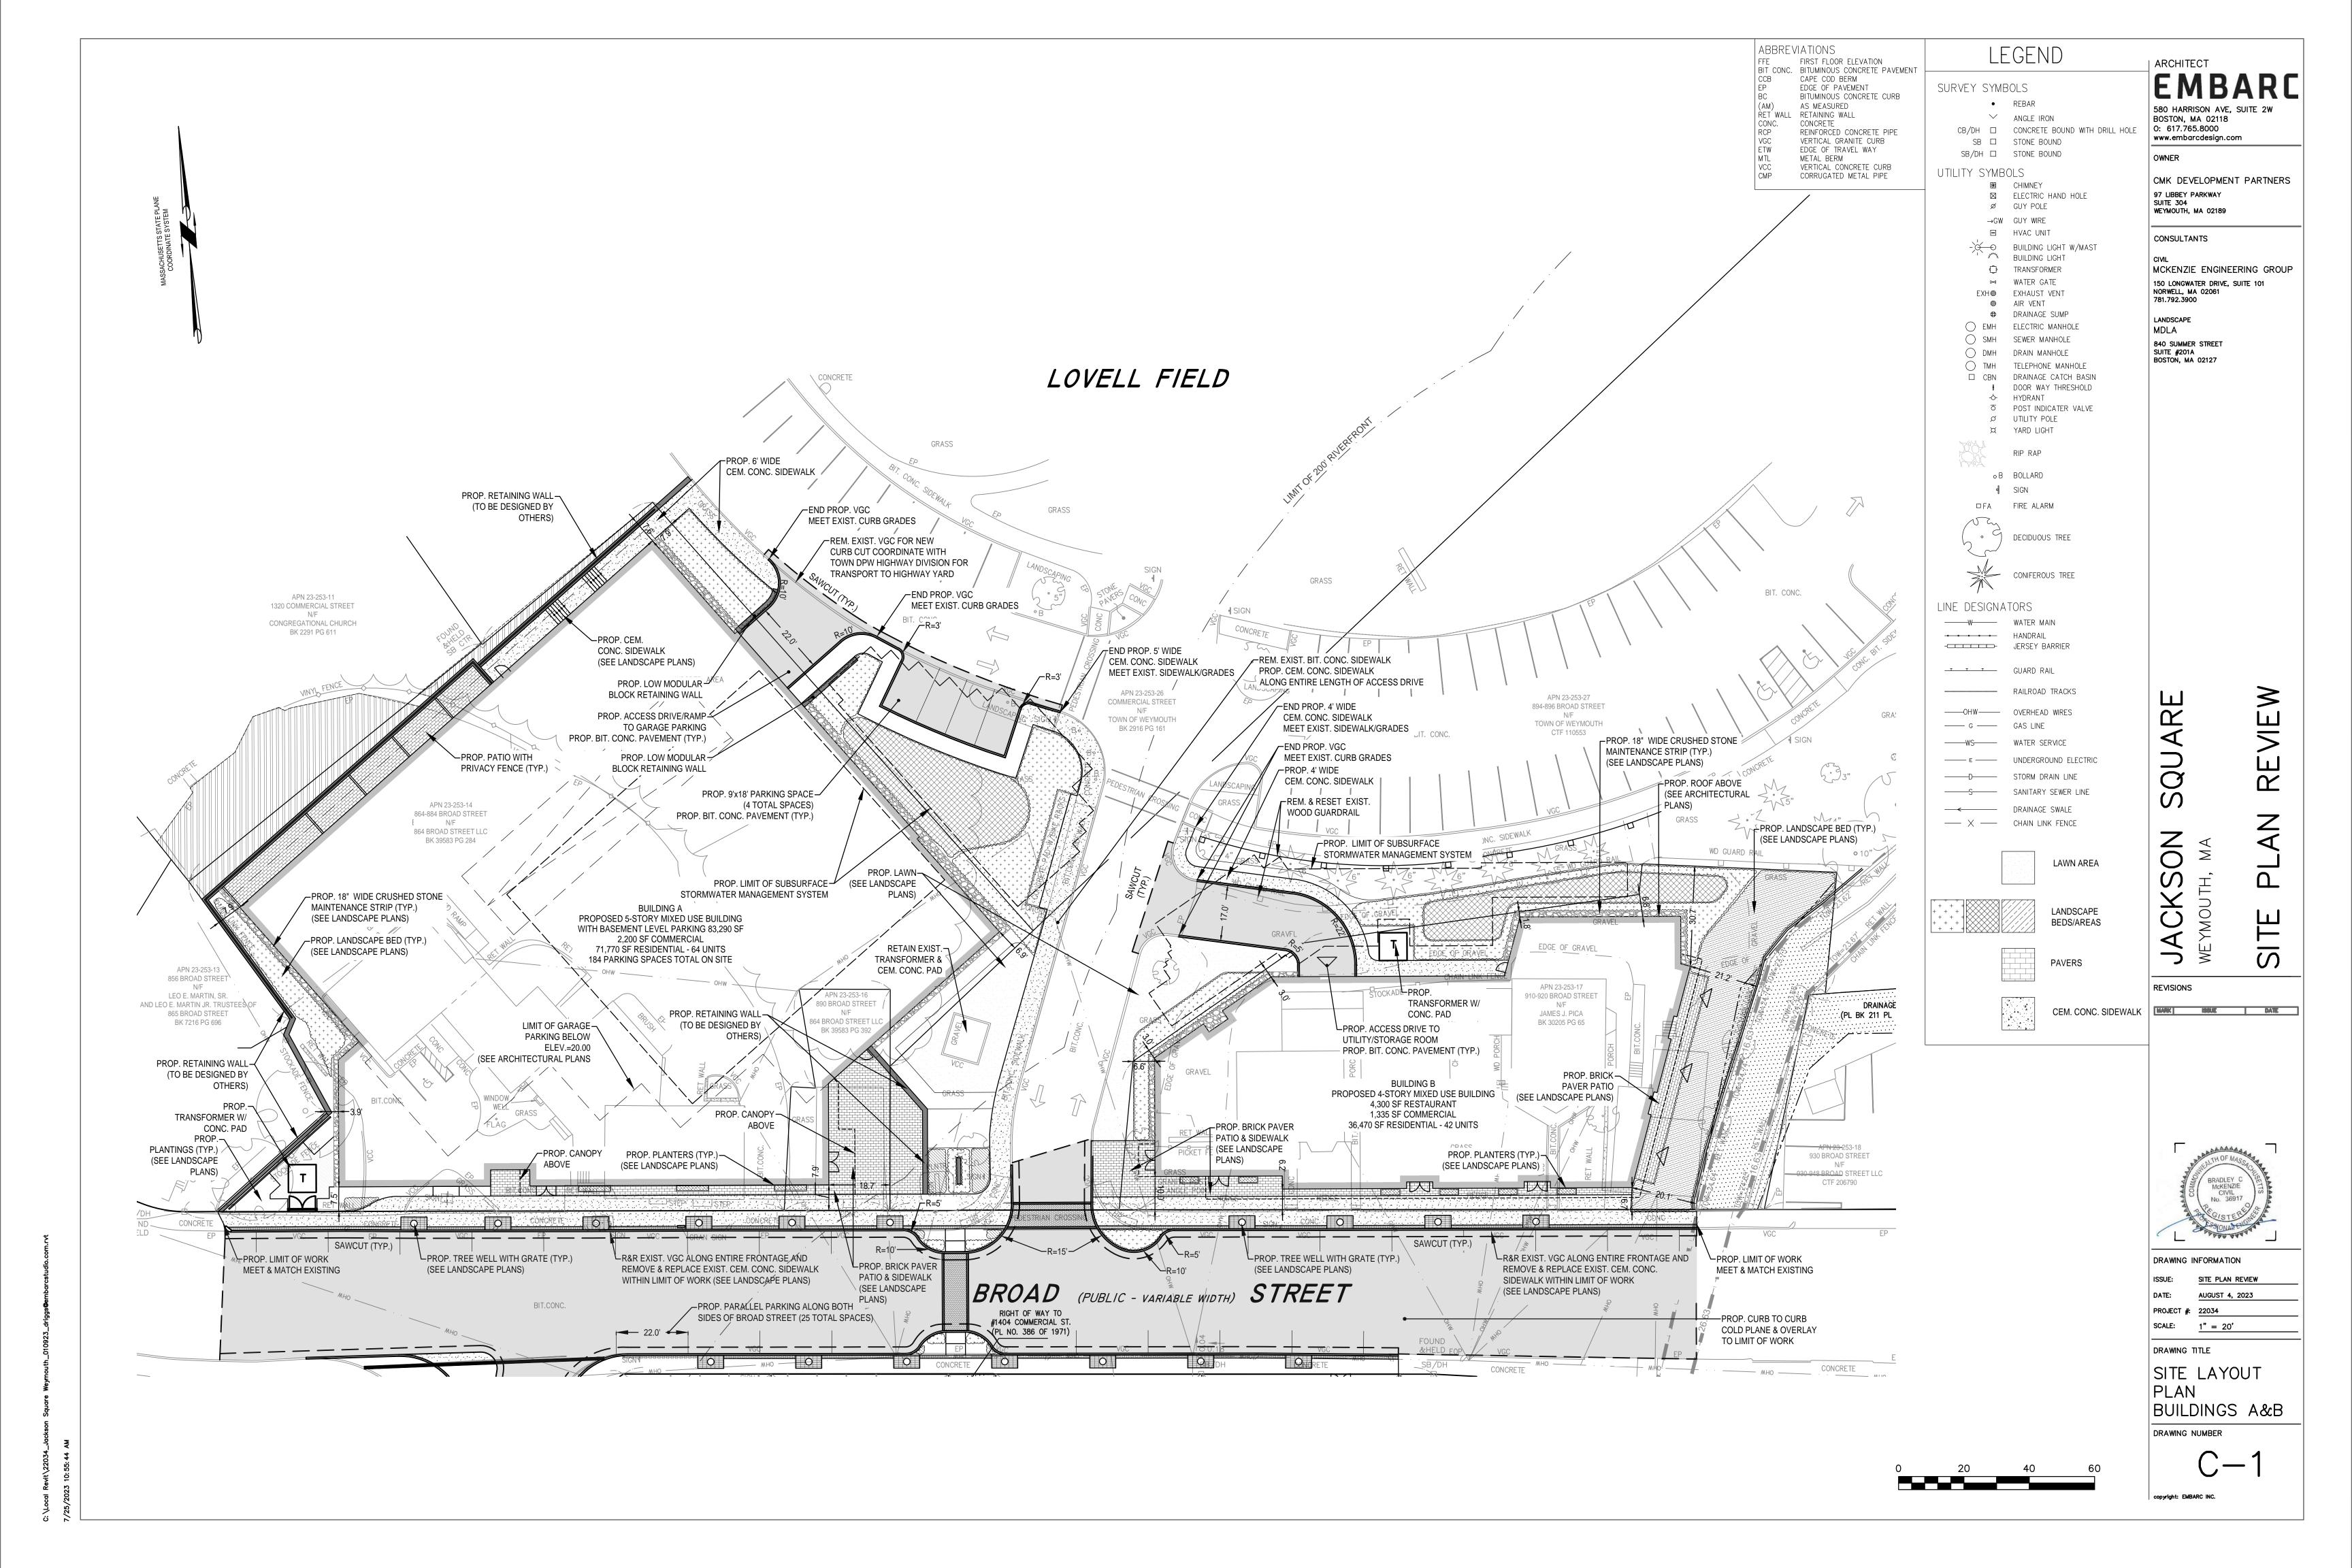
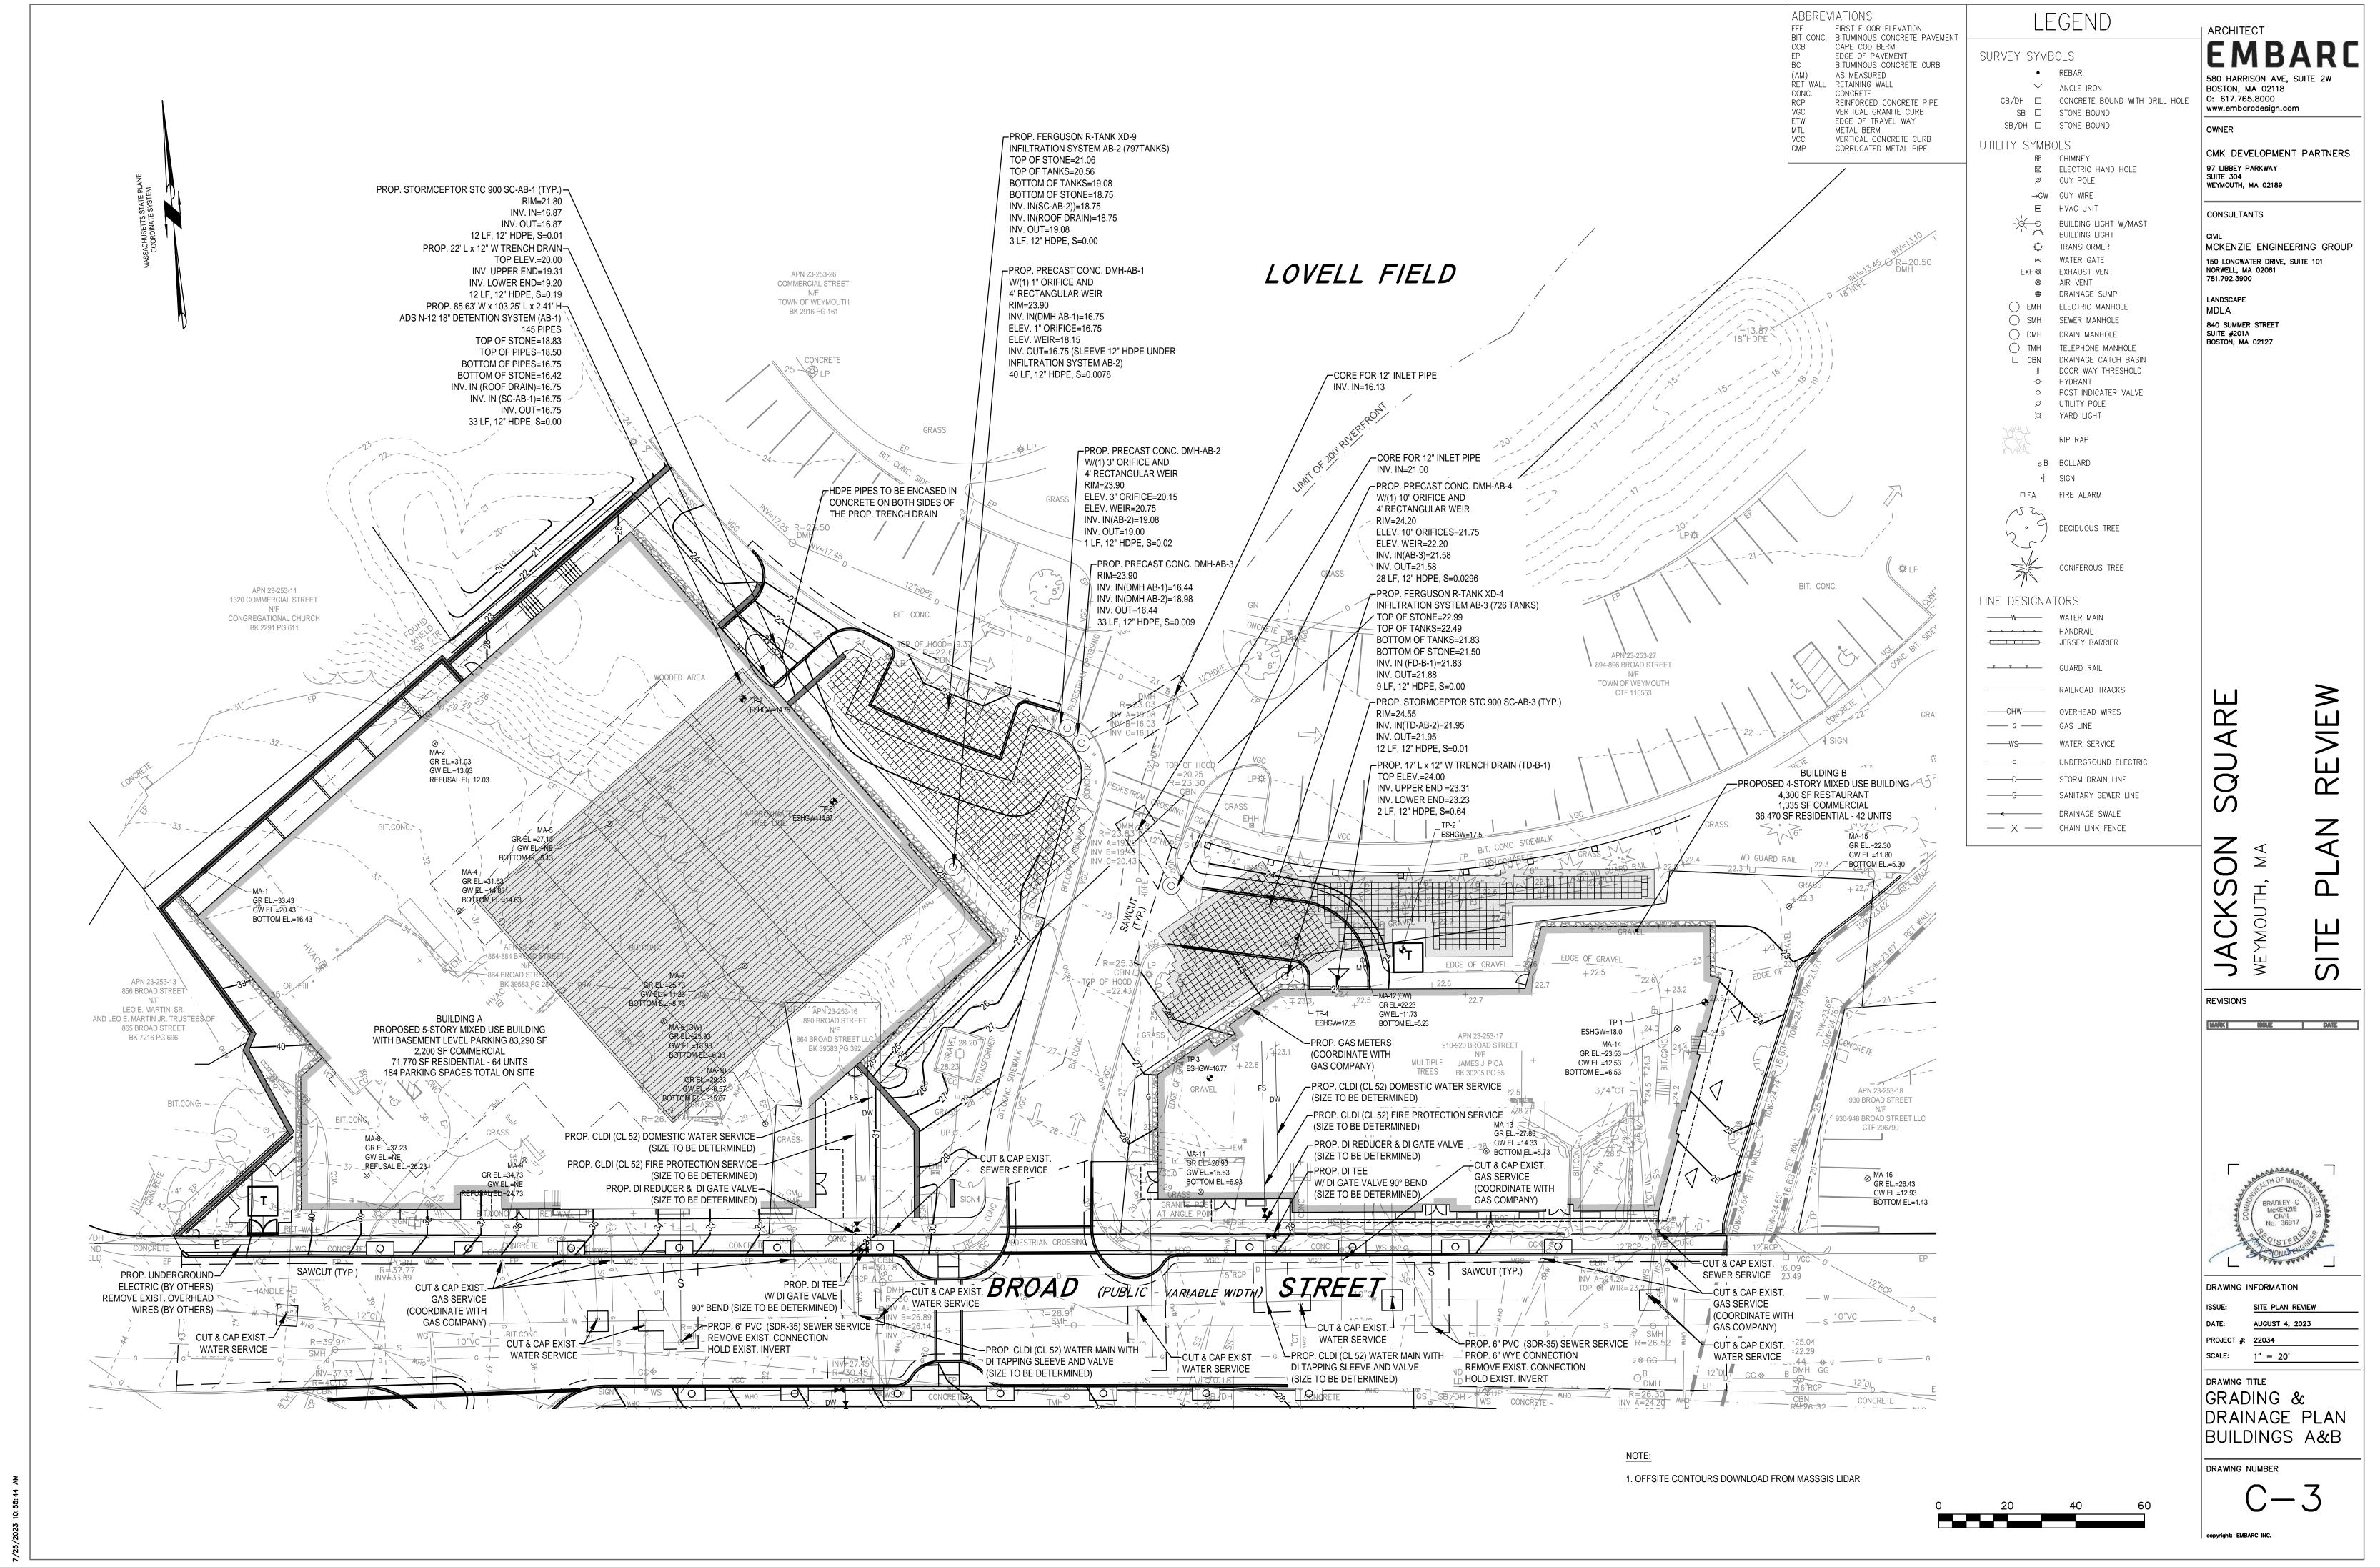
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MAX.

1% MIN.

SECTION A-A

SIDEWALK THRU DRIVEWAYS WITHOUT CURB RETURNS

SCALE: N.T.S.

TRANSITION (TYP.)

6" - 4,000 PSI, 3/4", 610 TYPE II

CEMENT CONCRETE SIDEWALK

8" GRAVEL BORROW SUBBASE

(TYPE B, MASSDOT M1.03.0)

95% COMPACTION

SUBGRADE

DRIVEWAY APRON

WIDTH VARIES

5% MIN.

5% MIN.

3.0' MIN.

SIDEWALK

2% MAX. -

1% MIN.

PAVER STRIP

PLANS)

(SEE LANDSCAPE


DRIVEWAY


(SEE PLANS)


APPROXIMATE


SIDEWALK


RIGHT-OF-WAY

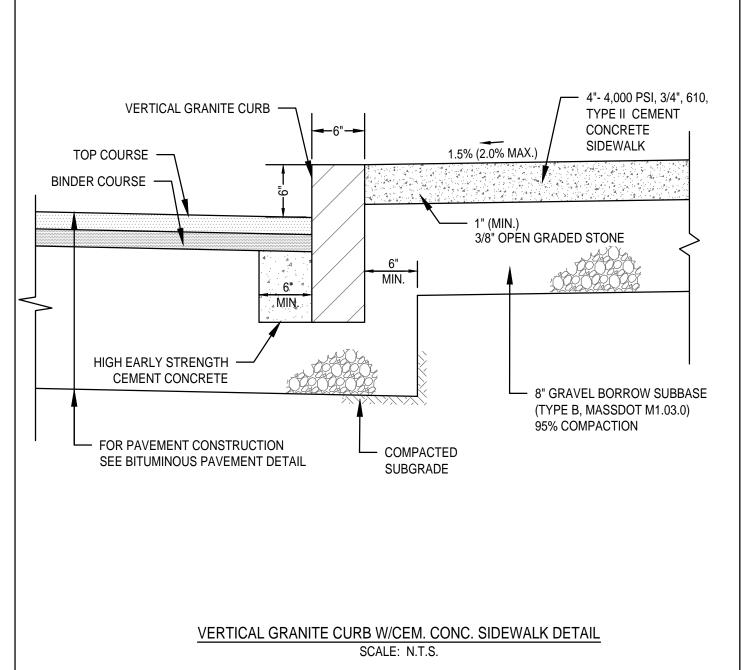


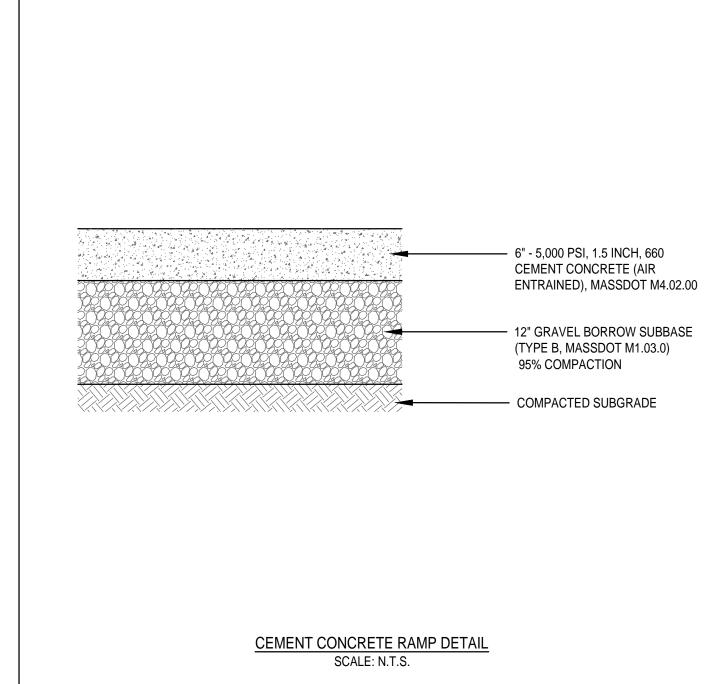

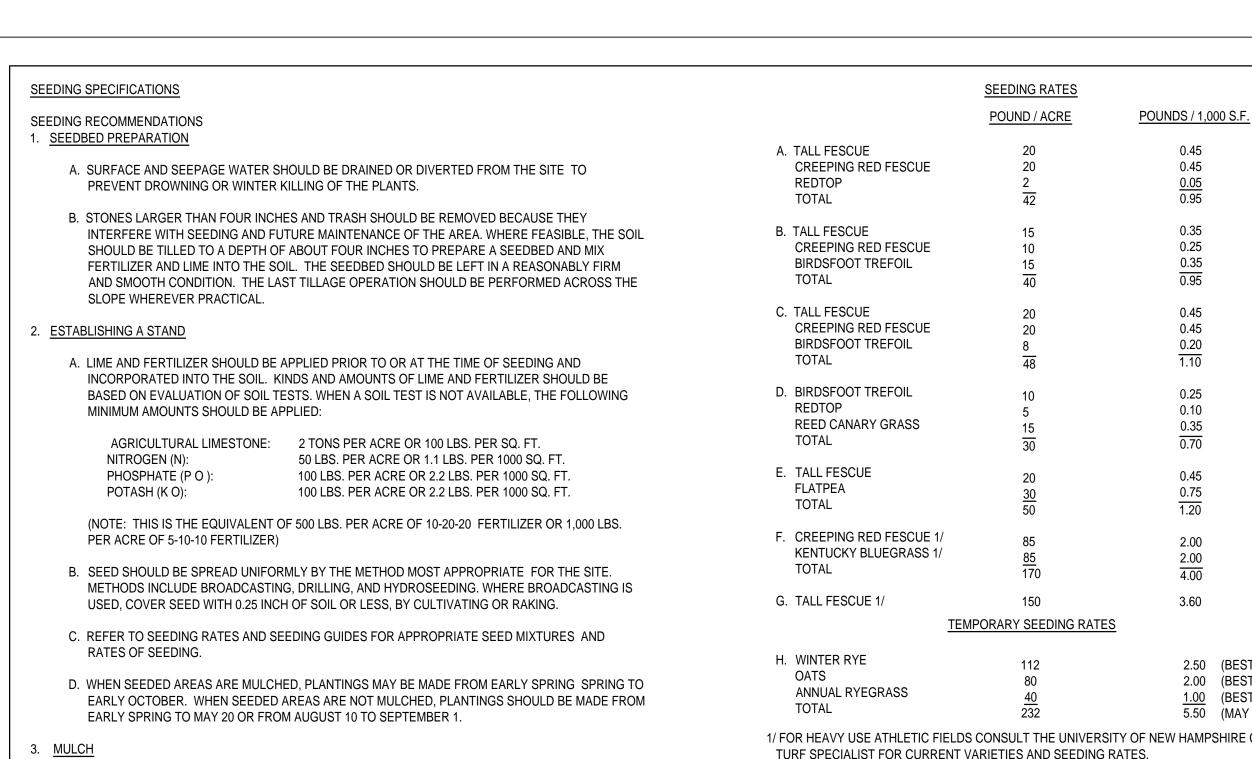


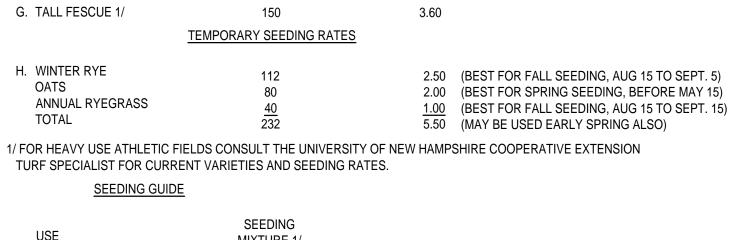


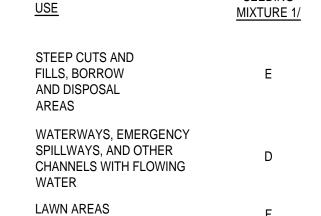


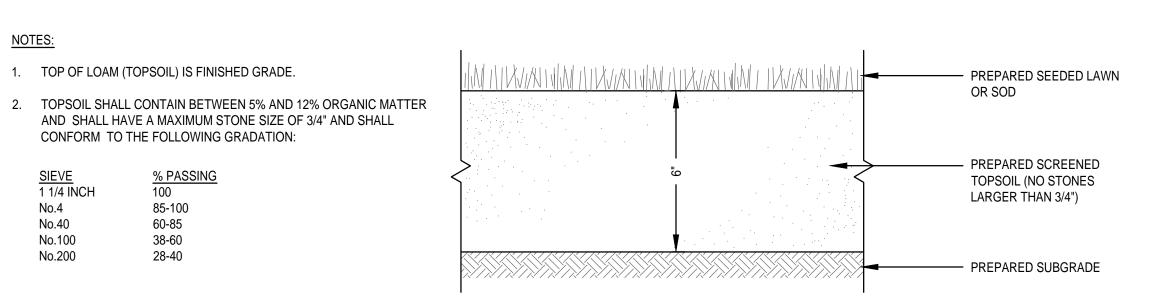

SEEDED OR SODDED LAWN DETAIL SCALE: N.T.S.

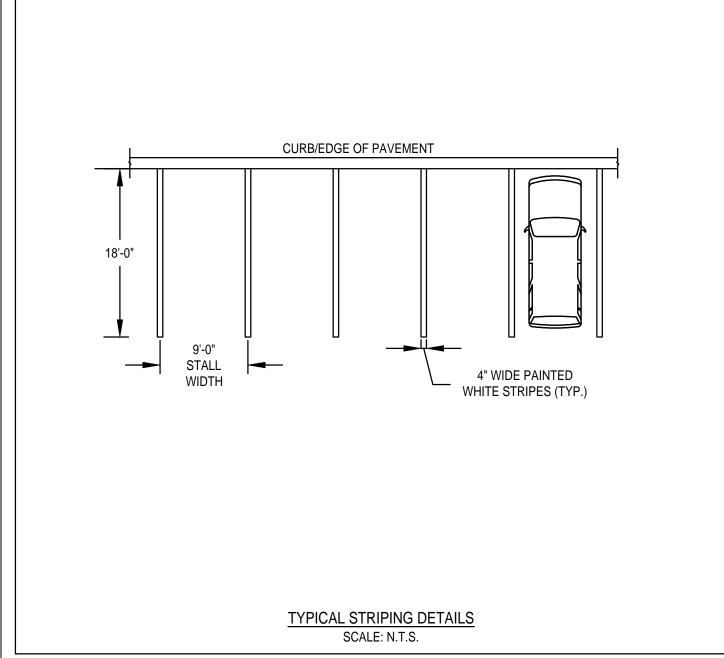

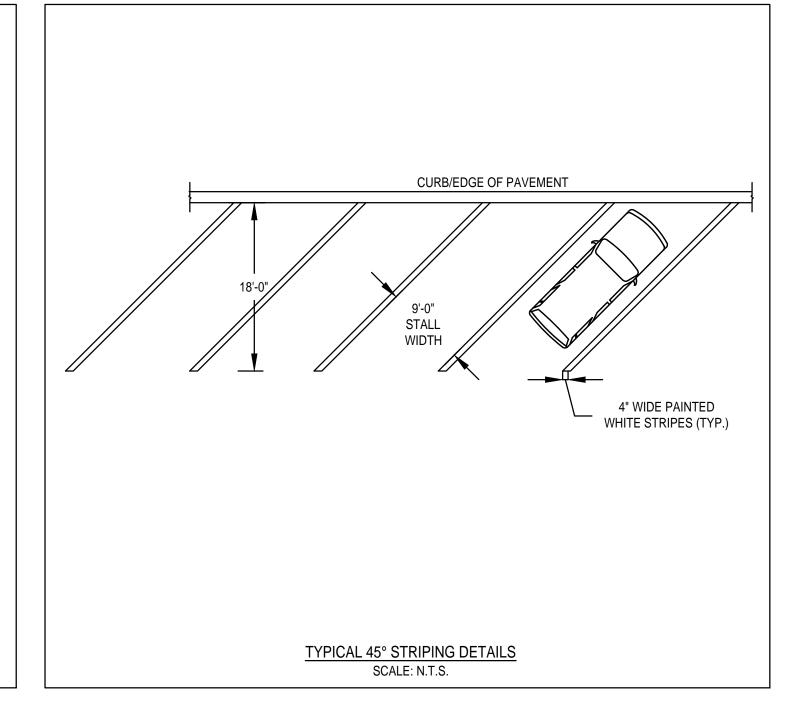

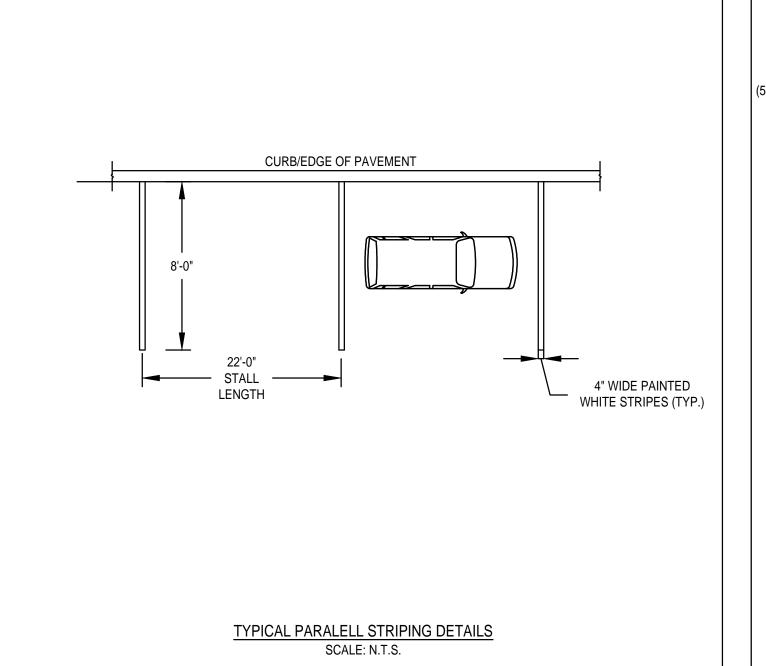

A. HAY, STRAW, OR OTHER MULCH, WHEN NEEDED, SHOULD BE APPLIED IMMEDIATELY AFTER

A. PLANTED AREAS SHOULD BE PROTECTED FROM DAMAGE BY FIRE, GRAZING, TRAFFIC, AND

B. FERTILIZATION NEEDS SHOULD BE DETERMINED BY ONSITE INSPECTIONS. SUPPLEMENTAL

BECAUSE MOST PERENNIALS TAKE 2 TO 3 YEARS TO BECOME ESTABLISHED.

AND SHALL HAVE A MAXIMUM STONE SIZE OF 3/4" AND SHALL

FERTILIZER IS USUALLY THE KEY TO FULLY COMPLETE THE ESTABLISHMENT OF THE STAND

C. IN WATERWAYS, CHANNELS, OR SWALES WHERE UNIFORM FLOW CONDITIONS ARE ANTICIPATED

OCCASIONAL MOWING MAY BE NECESSARY TO CONTROL GROWTH OF WOODY VEGETATION.

PRACTICES OPERATION AND MAINTENANCE PLAN"

TOP OF LOAM (TOPSOIL) IS FINISHED GRADE.

CONFORM TO THE FOLLOWING GRADATION:

% PASSING

85-100

60-85

38-60

28-40

4. MAINTENANCE TO ESTABLISH A STAND

DENSE WEED GROWTH.

NOTES:


1 1/4 INCH

No.40

No.100

No.200

B. MULCH WILL BE HELD IN PLACE USING TECHNIQUES AS SPECIFIED IN THE "BEST MANAGEMENT

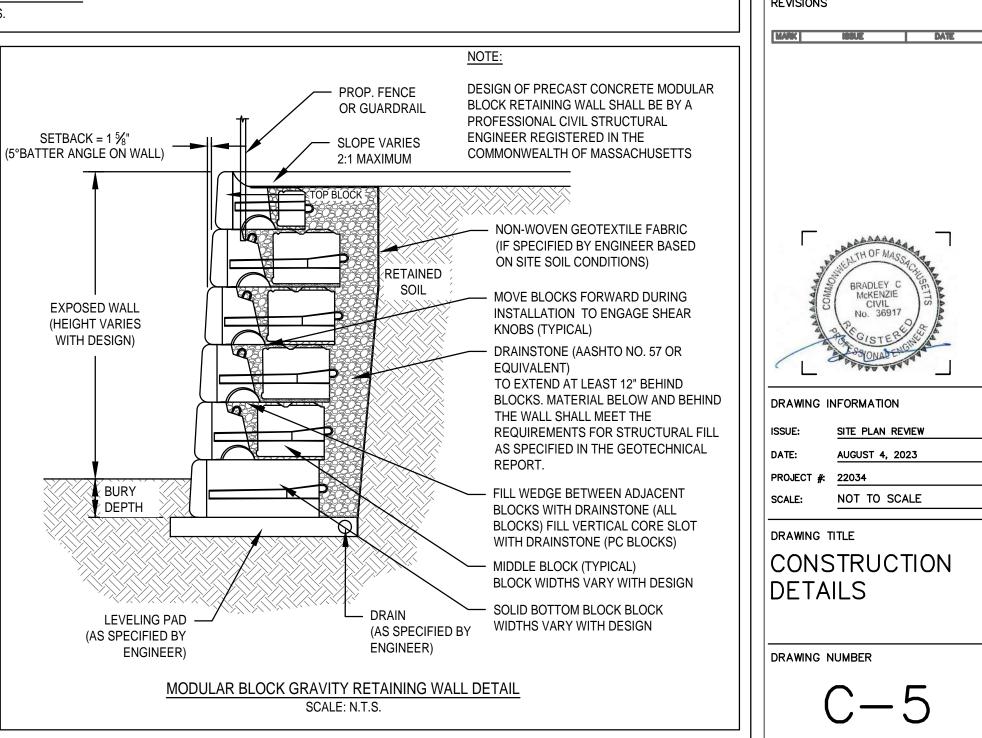

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REVISIONS

DRAWING INFORMATION


PROJECT #: 22034

SCALE: NOT TO SCALE DRAWING TITLE


CONSTRUCTION

GENERAL UTILITY NOTES

- THE CONTRACTOR IS SPECIFICALLY CAUTIONED THAT THE LOCATION AND/OR ELEVATION OF EXISTING UTILITIES AND STRUCTURES AS SHOWN ON THESE PLANS IS BASED ON RECORDS OF VARIOUS UTILITY COMPANIES AND WHERE POSSIBLE, MEASUREMENTS TAKEN IN THE FIELD. THIS INFORMATION IS NOT TO BE RELIED UPON AS BEING EXACT OR COMPLETE. THE LOCATION OF ALL UNDERGROUND UTILITIES AND STRUCTURES SHALL BE VERIFIED IN THE FIELD BY THE CONTRACTOR PRIOR TO THE START OF CONSTRUCTION THE CONTRACTOR MUST CONTACT THE APPROPRIATE UTILITY COMPANY, ANY GOVERNING PERMITTING AUTHORITY, AND "DIGSAFE" AT LEAST 72 HOURS PRIOR TO ANY EXCAVATION WORK TO REQUEST EXACT FIELD LOCATION OF UTILITIES AND THE ENGINEER SHALL BE NOTIFIED IN WRITING OF ANY UTILITIES INTERFERING WITH THE PROPOSED CONSTRUCTION AND APPROPRIATE REMEDIAL ACTION TAKEN BEFORE PROCEEDING WITH THE WORK. IT SHALL BE THE RESPONSIBILITY OF THE CONTRACTOR TO RELOCATE ALL EXISTING UTILITIES WHICH CONFLICT WITH THE PROPOSED IMPROVEMENTS SHOWN ON THE PLAN.
- THE CONTRACTOR SHALL BE RESPONSIBLE FOR ESTABLISHING AND MAINTAINING ALL CONTROL POINTS AND BENCHMARKS NECESSARY FOR THE WORK.
- THE CONTRACTOR SHALL EXCAVATE THE TEST PITS IN THE LOCATIONS SHOWN ON THE PLAN PRIOR TO COMMENCING WORK TO VERIFY THE ELEVATIONS AND LOCATIONS OF EXISTING UTILITIES. THE CONTRACTOR SHALL PROVIDE THE OWNER AND ENGINEER WITH THE RESULTS PRIOR TO COMMENCING ANY WORK.
- ALL WATER SERVICES SHALL BE INSTALLED WITH 5' OF COVER EXCEPT AS NOTED OR DETAILED OTHERWISE.
- DOMESTIC WATER SERVICES 2 INCHES AND SMALLER SHALL BE TYPE K COPPER TUBING AND SHALL BE INSTALLED WITH APPROPRIATELY SIZED CORPORATION STOP WITH APPROVED SADDLE, CURB STOP, GATE AND BOX.
- 6. SEE SHEET D-4 FOR WEYMOUTH WATER DEPT. CONSTRUCTION DETAILS.
- THE CONTRACTOR SHALL PROVIDE INLET PROTECTION, SUCH AS SILT SACKS, AT ALL CATCH BASINS TO PREVENT SEDIMENT FROM ENTERING THE EXTENDED DETENTION WETLAND AREA. INLET PROTECTION WILL ALLOW THE STORM DRAIN INLETS TO BE USED BEFORE FINAL STABILIZATION.
- 8. THE CONTRACTOR SHALL PROVIDE SIEVE ANALYSIS SUBMITTALS TO THE ENGINEER FOR APPROVAL PRIOR TO INSTALLATION OF THE SAND/SILT MATERIAL TO BE USED.

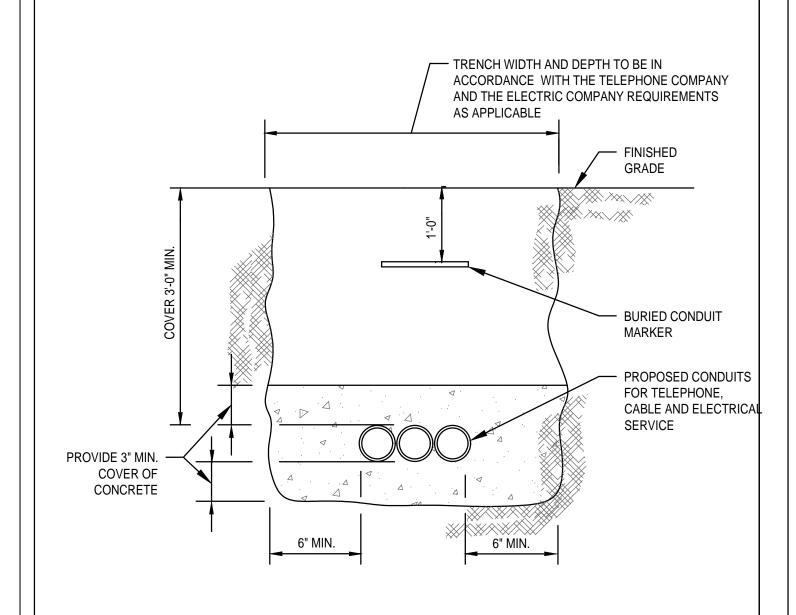


TYPICAL ELECTRIC/TELEPHONE/CABLE CONDUIT (US-UTILITY SERVICE)

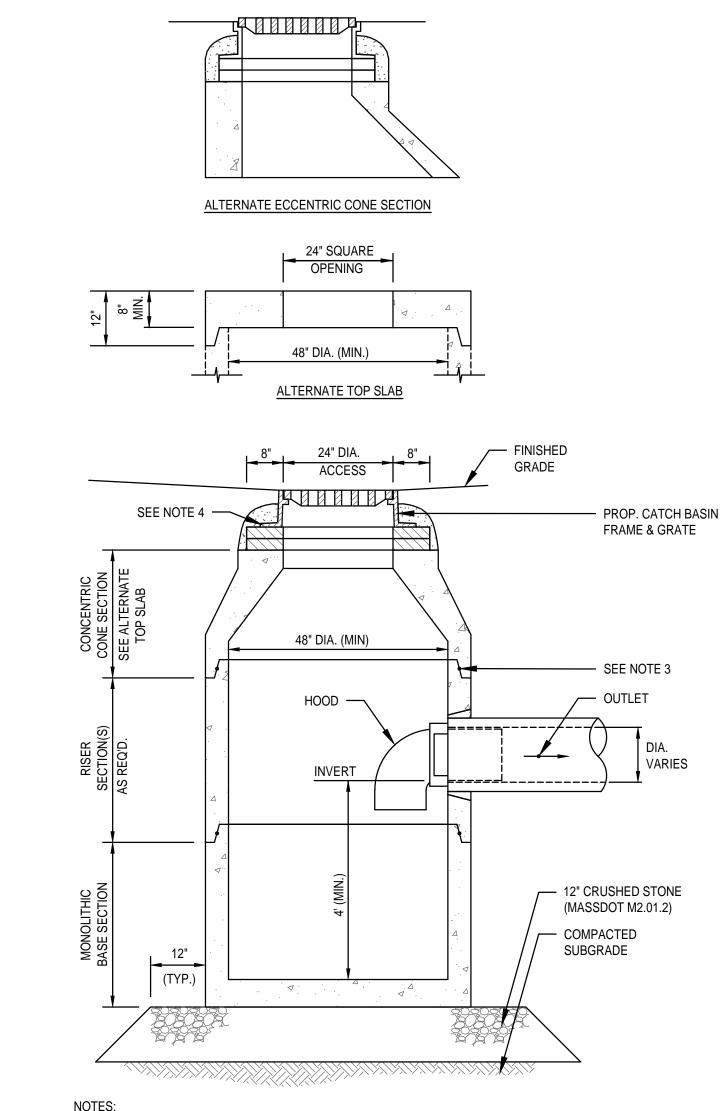

- 1. ALL SECTIONS SHALL BE DESIGNED FOR HS-20 LOADING.
- 2. PROVIDE "V" KNOCKOUTS FOR PIPES WITH 2" MAX. CLEARANCE TO OUTSIDE OF PIPE. MORTAR ALL PIPE CONNECTIONS.
- 3. MORTAR ALL PIPE CONNECTIONS. JOINT SEALANT BETWEEN PRECAST SECTIONS SHALL BE PREFORMED BUTYL RUBBER.
- 4 CATCH BASIN FRAME AND GRATE SHALL BE SET IN FULL MORTAR BED. ADJUST TO GRADE WITH CLAY BRICK AND MORTAR (2 BRICK COURSES TYPICALLY, 5 BRICK COURSES MAXIMUM).


CATCH BASIN W/HOOD SCALE: N.T.S.

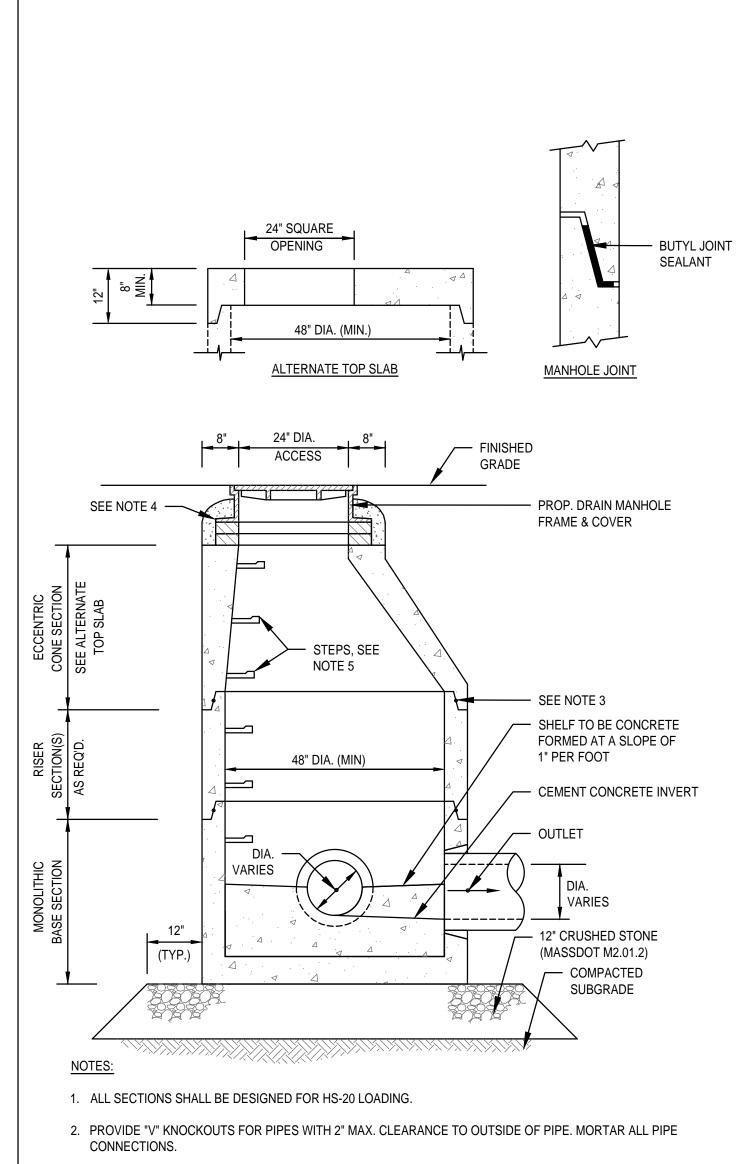


- 3. JOINT SEALANT BETWEEN PRECAST SECTIONS SHALL BE PREFORMED BUTYL RUBBER.
- 4. DRAIN MANHOLE FRAME AND COVER SHALL BE SET IN FULL MORTAR BED. ADJUST TO GRADE WITH CLAY BRICK AND MORTAR (2 BRICK COURSES TYPICALLY, 5 BRICK COURSES MAXIMUM).
- 5. COPOLYMER MANHOLE STEPS SHALL BE INSTALLED AT 12" O.C. FOR THE FULL DEPTH OF THE STRUCTURE.

DRAIN MANHOLE DETAIL

SCALE: N.T.S.

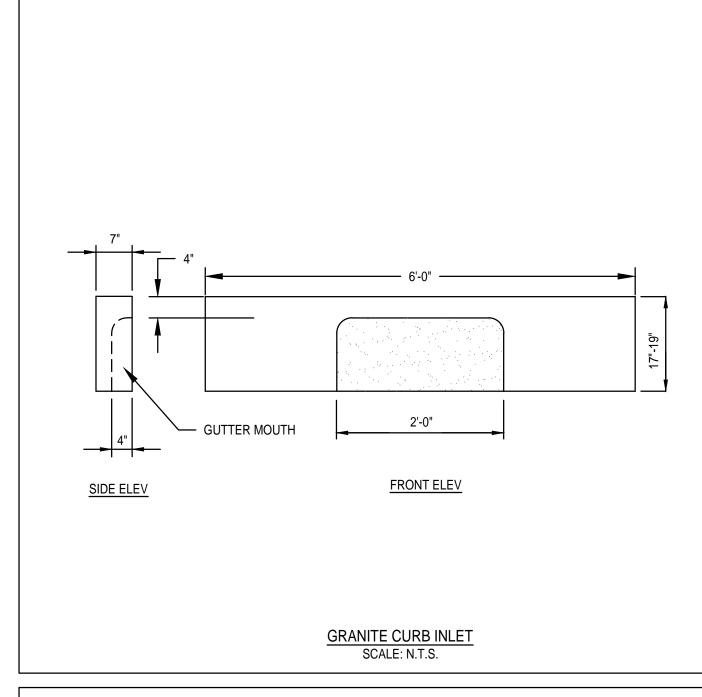

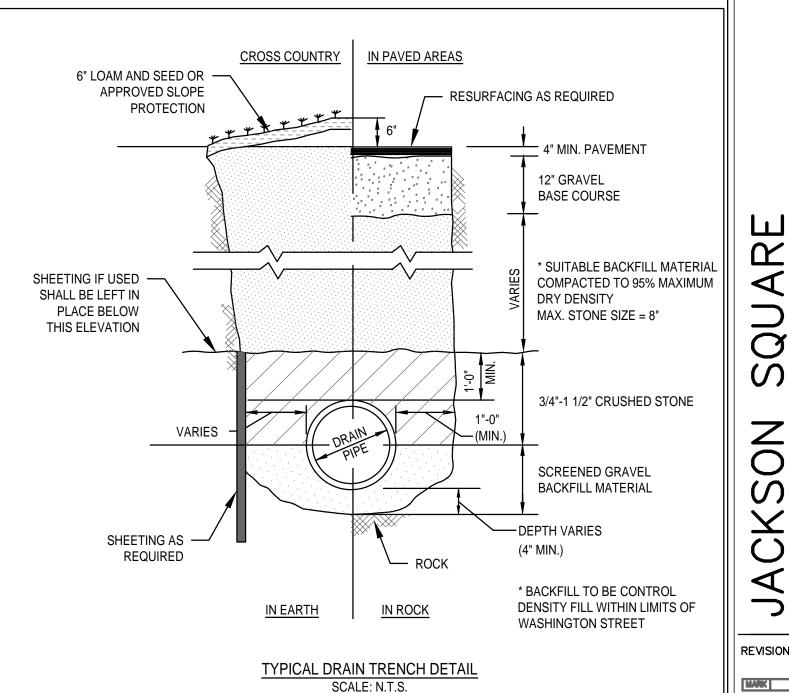

ARCHITECT **EMBARC**

BOSTON, MA 02118 0: 617.765.8000 www.embarcdesign.com

CMK DEVELOPMENT PARTNERS

CONSULTANTS

781.792.3900

97 LIBBEY PARKWAY SUITE 304 WEYMOUTH, MA 02189

MCKENZIE ENGINEERING GROUP 150 LONGWATER DRIVE, SUITE 101 NORWELL, MA 02061

LANDSCAPE MDLA 840 SUMMER STREET


SUITE #201A BOSTON, MA 02127

VIEW

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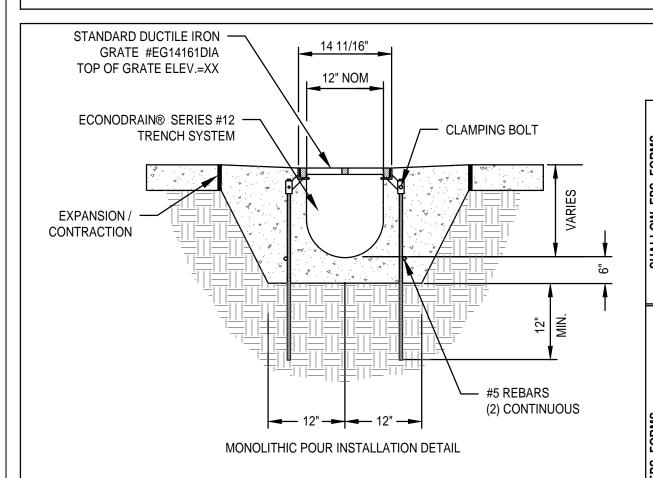
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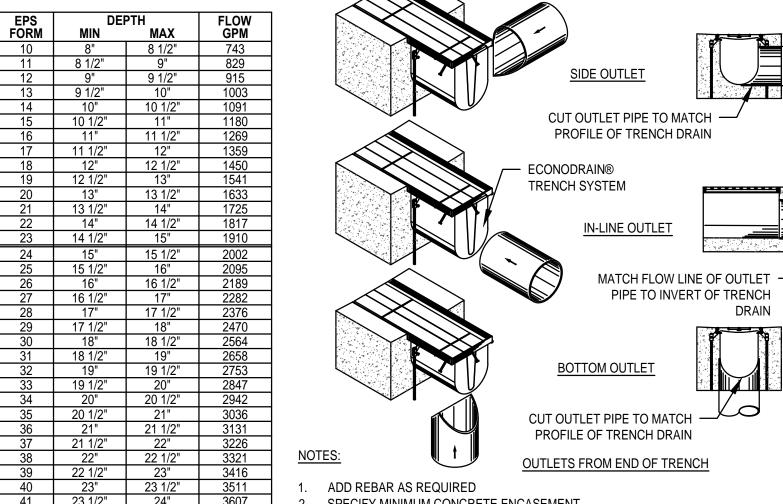
DRAWING TITLE

CONSTRUCTION DETAILS

DRAWING NUMBER

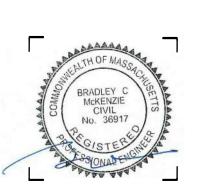

- 1. ADD REBAR AS REQUIRED.
- 2. SPECIFY REQUIRED DIMENSIONS (LABELED WITH *) USING 6" EACH SIDE OF STEEL
- FRAME AND BELOW EPS FORM AS A RECOMMENDED MINIMUM. 3. SHOW TOP OF GRATE ELEVATION IN PLAN VIEW.
- 4. EXPANSION / CONTRACTION JOINT PER LOCAL ENGINEERING REGULATIONS AND
- 5. STANDARD CHANNEL LENGTH IS 8'-0" (96").
- GUIDELINES. **EPS FORM CHART** 6. STANDARD CHANNEL SLOPE IS 0.5%. ECONODRAIN® SERIES #12 TRENCH DRAIN SCALE: N.T.S.




SPECIFY MINIMUM CONCRETE ENCASEMENT.

4" MINIMUM CONCRETE COVERAGE OF OUTLET PIPE IS RECOMMENDED (LABELED WITH *). FINAL CONCRETE THICKNESS PER LOCAL ENGINEERING REGULATIONS AND GUIDELINES.

CONSTRUCTION NOTES:

- INSTALLATION TO BE COMPLETE IN ACCORDANCE WITH MANUFACTURES SPECIFICATIONS.
- SECURE OUTLET PIPE PRIOR TO CONCRETE OPERATIONS.

3. FOR ILLUSTRATION ONLY - DO NOT SCALE

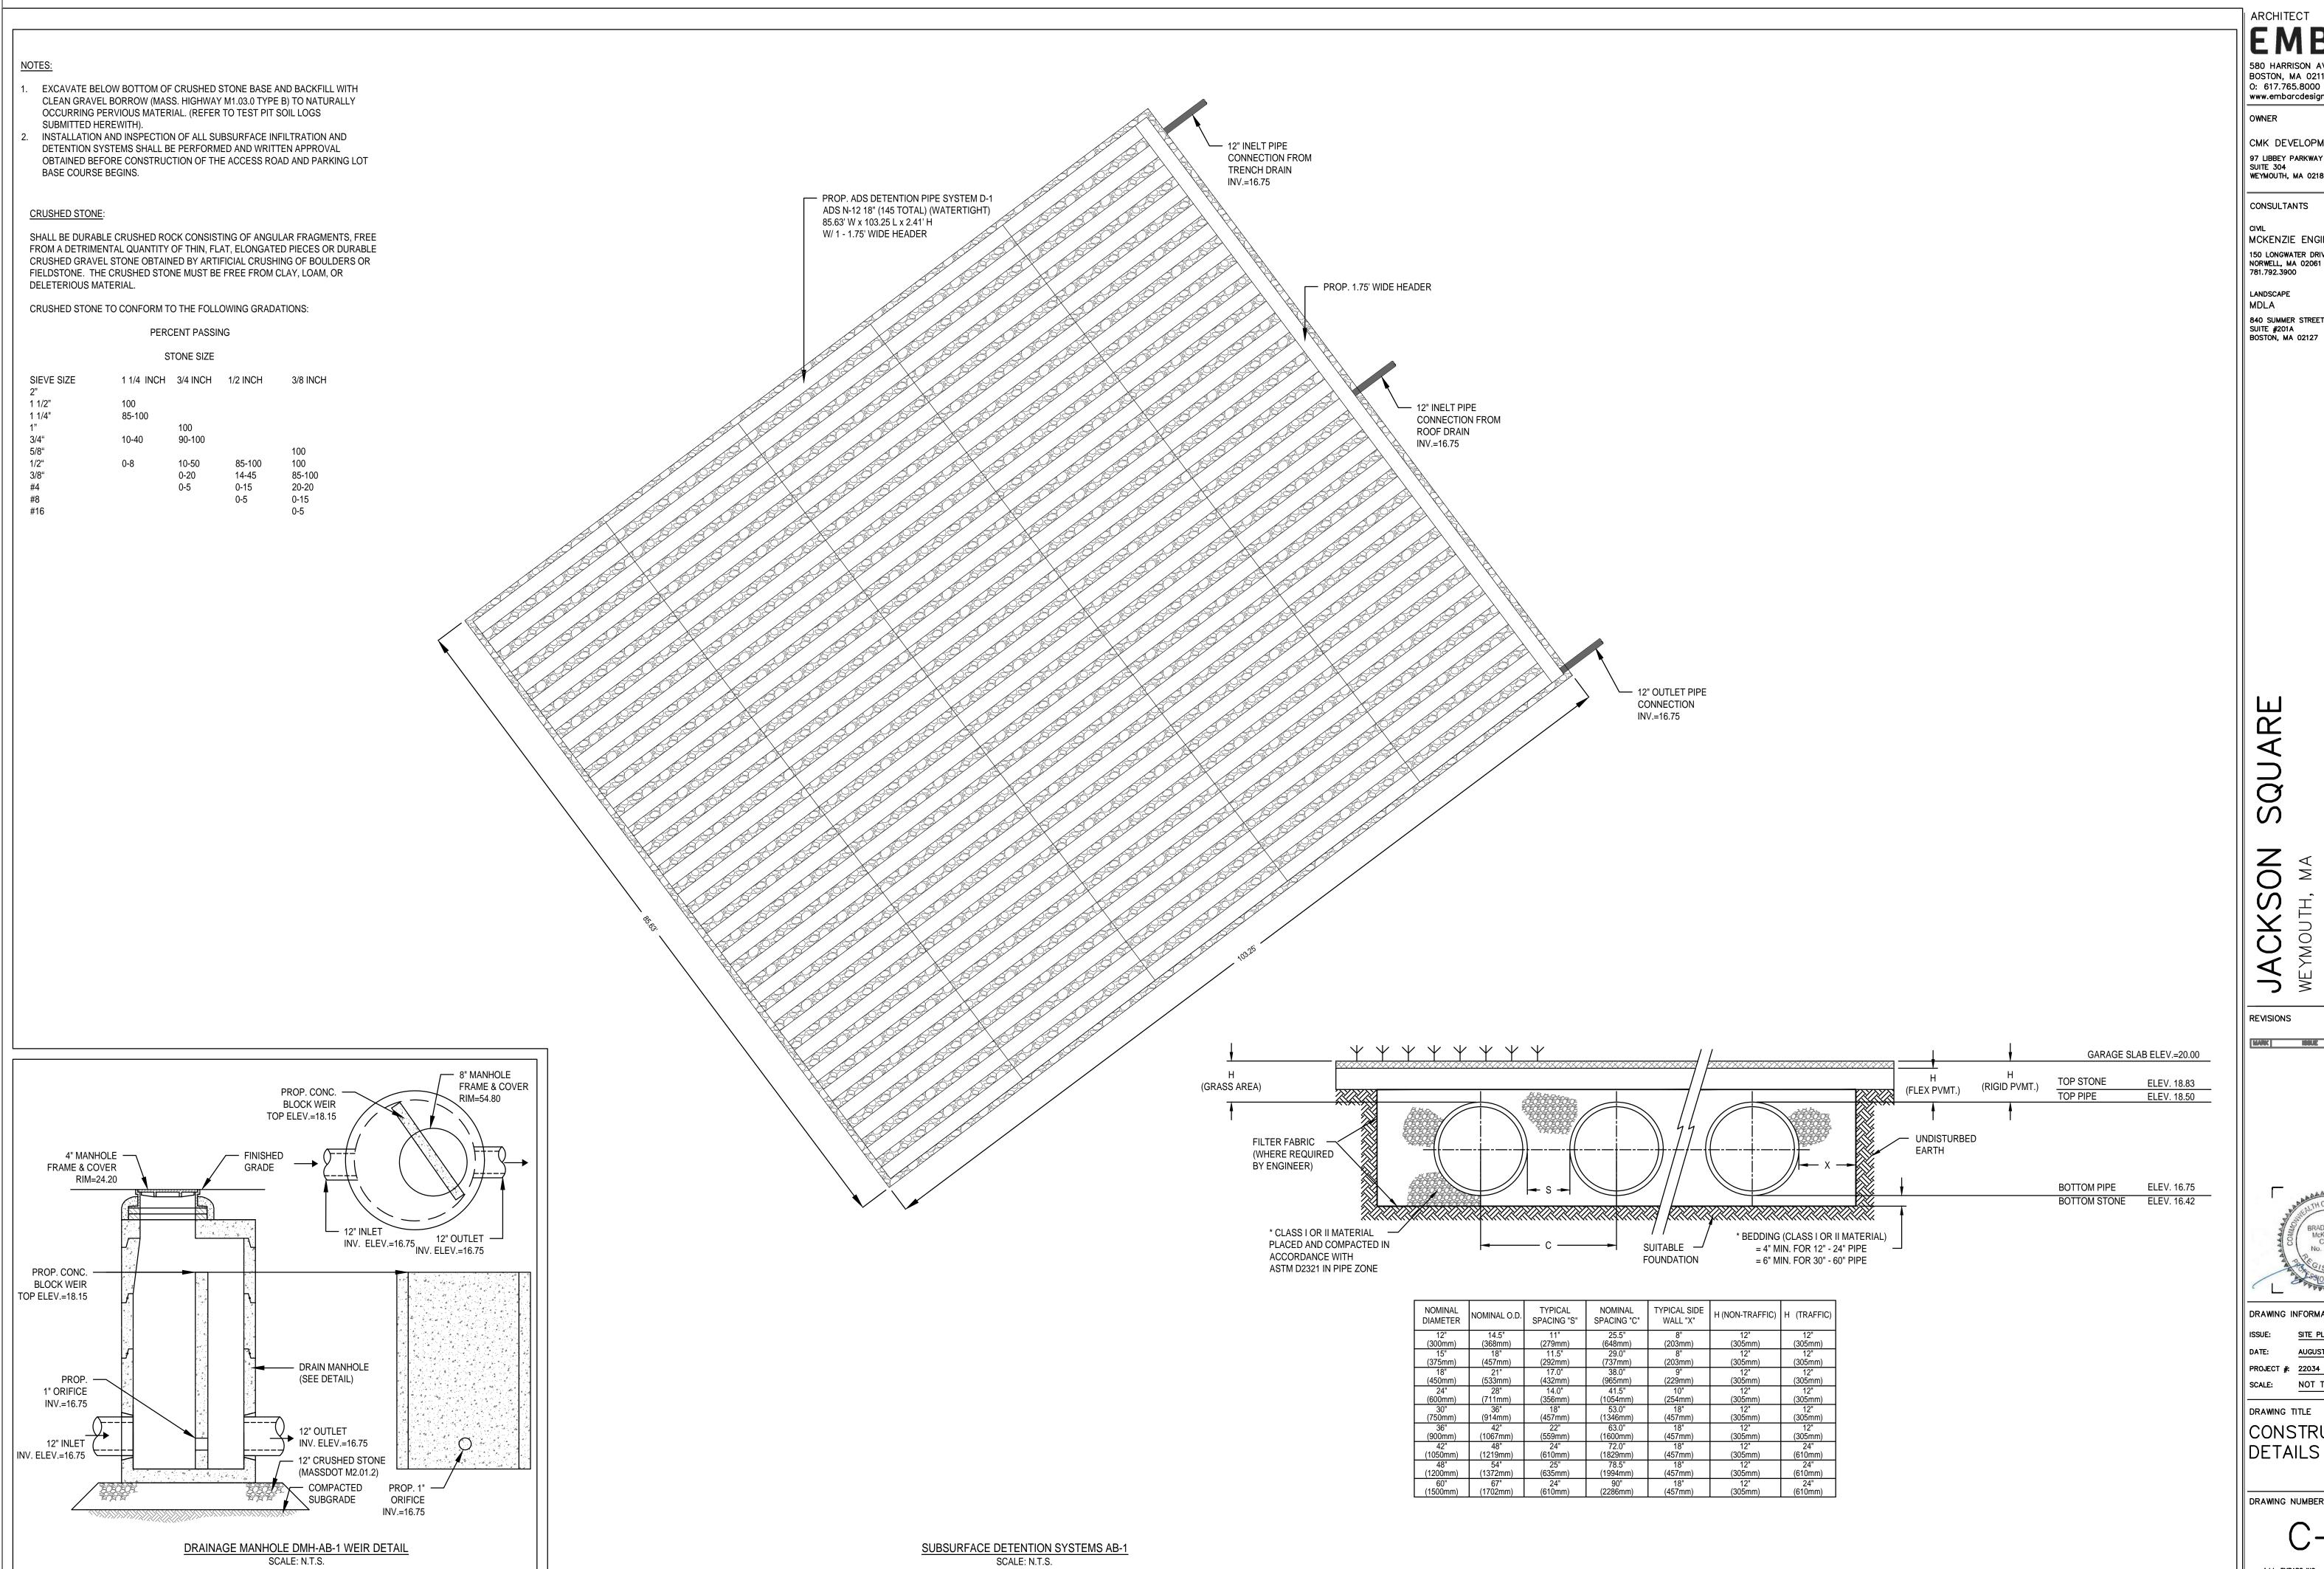

BOSTON, MA 02118

0: 617.765.8000 www.embarcdesign.com

CMK DEVELOPMENT PARTNERS 97 LIBBEY PARKWAY SUITE 304 WEYMOUTH, MA 02189

CONSULTANTS

MCKENZIE ENGINEERING GROUP 150 LONGWATER DRIVE, SUITE 101

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PROJECT #: 22034

SCALE: NOT TO SCALE

DRAWING TITLE

CONSTRUCTION DETAILS

4. FOR INFILTRATION APPLICATIONS, GEOTEXTILE ENVELOPING R-TANK SHALL BE ACF M200 (PER SPEC SECTION 2.02A) AND BASE SHALL BE 4" MIN. UNCOMPACTED FREE DRAINING BACKFILL (SPEC SECTION 2.03A) TO PROVIDE A LEVEL BASE. SURFACE MUST BE SMOOTH, FREE OF LUMPS OR DEBRIS, AND EXTEND 2' BEYOND R-TANK^{XD}

BASE: 4" MIN. FREE DRAINING BACKFILL (SPEC

SECTION 2.03B) COMPACTED TO 95% STANDARD

PROCTOR DENSITY IS REQUIRED TO PROVIDE A

LEVEL BASE SURFACE. MUST BE SMOOTH, FREE

R-TANK^{XD} FOOTPRINT. A BEARING CAPACITY OF

R-TANK^{XD} TANK WRAP & EXCAVATION ENVELOPE DETAIL

OF LUMPS OR DEBRIS, AND EXTEND 2' BEYOND

INSTALLING R-TANK^{XD}. NATIVE SOILS MAY BE ACCEPTABLE IF DETERMINED TO BE STABLE BY

2,000 PSF MUST BE ACHIEVED PRIOR TO

OWNER'S ENGINEER.

6" MIN. to 200" MAX. LANDSCAPE MDLA 840 SUMMER STREET SUITE #201A BOSTON, MA 02127

TP-7

ESHGW ELEV. 14.75

19.08 BOTTOM TANKS

18.75 BOTTOM STONE

COVER FROM FINISH GRADE

TO TOP OF TANK:

12" OUTLET PIPE

- SIDE BACKFILL: 24" MIN. OF FREE

COMPACT SIDE BACKFILL WITH

12" LIFTS.

DRAINING BACKFILL (SPEC SECTION

CLASS GW, GP, SW OR SP). MUST BE

2.03B): STONE <1.5" OR SOIL (USCS —

FREE FROM LUMPS, DEBRIS AND OTHER

POWERED MECHANICAL COMPACTOR IN

SHARP OBJECTS. SPREAD EVENLY TO PREVENT R-TANK^{XD} MOVEMENT.

12" INLET PIPE-

4" MIN.—

R-TANK^{XD} UNITS WRAPPED IN 8 _

OZ NONWOVEN GEOTEXTILE (OR

EQUAL), LOADING RATING: 240.2

PSI (MODULE ONLY)

EXCAVATION LINE -

SUBSURFACE INFILTRATION SYSTEMS AB-2 SCALE: N.T.S.

R-TANK XD 4

9.79'

TOTAL COVER: 6" MINIMUM AND 200" MAXIMUM. INITIAL COVER -

UP TO 12" MUST BE FREE DRAINING BACKFILL (SPEC SECTION

2.03B): STONE <1.5" OR SOIL (USCS CLASS GW, GP, SW OR SP).

ADDITIONAL FILL MAY BE STRUCTURAL FILL (SPEC SECTION

2.03C): STONE OR SOIL (USCS CLASS SM, SP, SW, GM, GP OR

GW) WITH MAX CLAY CONTENT<10%, MAX 25% PASSING NO.

200 SIEVE, AND MAX PLASTICITY INDEX OF 4. CONTACT ACF ENVIRONMENTAL IF MORE THAN 200" OR LESS THAN 6" OF TOP BACKFILL IS REQUIRED (FROM TOP OF TANK TO TOP OF

UTILITY MARKERS AT CORNERS (TYP.)

(TYP. OF 726)

- INSPECTION PORT (TYP.

VERIFIED BY ENGINEER)

LOCATIONS TO BE

STONE PERIMETER

12" INLET PIPE

TRENCH DRAIN

INV.=21.83

CONNECTION FROM

— 4" MANHOLE FRAME & COVER PROP. CONC. RIM=23.90 **BLOCK WEIR** TOP ELEV.=20.75 4" MANHOLE -**FINISHED** FRAME & COVER GRADE RIM=23.90 INV. ELEV.=19.08 12" OUTLET — INV. ELEV.=19.00 PROP. CONC. -**BLOCK WEIR** TOP ELEV.=20.75

DRAINAGE MANHOLE DMH-AB-2 WEIR DETAIL

SCALE: N.T.S.

1. EXCAVATE BELOW BOTTOM OF CRUSHED STONE BASE AND BACKFILL WITH

OCCURRING PERVIOUS MATERIAL. (REFER TO TEST PIT SOIL LOGS

2. INSTALLATION AND INSPECTION OF ALL SUBSURFACE INFILTRATION AND

DETENTION SYSTEMS SHALL BE PERFORMED AND WRITTEN APPROVAL

OBTAINED BEFORE CONSTRUCTION OF THE ACCESS ROAD AND PARKING LOT

SUBMITTED HEREWITH).

BASE COURSE BEGINS.

CLEAN GRAVEL BORROW (MASS. HIGHWAY M1.03.0 TYPE B) TO NATURALLY

3/8 INCH

100

85-100

20-20

0-15

14-45

0-15

DELETERIOUS MATERIAL.

PROP. — 3" ORIFICE

INV.=20.15

12" INLET

INV. ELEV.=19.08

SIEVE SIZE

1 1/2"

1 1/4"

CRUSHED STONE TO CONFORM TO THE FOLLOWING GRADATIONS:

100

85-100

10-40

PERCENT PASSING

STONE SIZE

1 1/4 INCH 3/4 INCH 1/2 INCH

90-100

10-50

0-20

— DRAIN MANHOLE (SEE DETAIL) 12" OUTLET INV. ELEV.=19.00 - 12" CRUSHED STONE (MASSDOT M2.01.2) COMPACTED PROP.3" — SUBGRADE ORIFICE INV.=20.15

CRUSHED STONE:

FIELDSTONE. THE CRUSHED STONE MUST BE FREE FROM CLAY, LOAM, OR

PERCENT PASSING STONE SIZE

1 1/4 INCH 3/4 INCH 1/2 INCH 1 1/2" 85-100 1 1/4" 90-100 14-45 85-100 0-15 20-20 0-5 0-15

SHALL BE DURABLE CRUSHED ROCK CONSISTING OF ANGULAR FRAGMENTS, FREE FROM A DETRIMENTAL QUANTITY OF THIN, FLAT, ELONGATED PIECES OR DURABLE CRUSHED GRAVEL STONE OBTAINED BY ARTIFICIAL CRUSHING OF BOULDERS OR DELETERIOUS MATERIAL.

12" OUTLET PIPE CONNECTION INV.=21.83

CRUSHED STONE TO CONFORM TO THE FOLLOWING GRADATIONS:

SUBSURFACE INFILTRATION SYSTEMS AB-3 SCALE: N.T.S.

1. FOR COMPLETE MODULE DATA, SEE APPROPRIATE R-TANK^{XD} MODULE SHEET .

2. INSTALLATIONS PER THIS DETAIL MEET GUIDELINES OF HL-93 LOADING PER THE AASHTO LRFD BRIDGE DESIGN SPECIFICATIONS, CUSTOMARY U.S. UNITS, 7TH EDITION, 2014 WITH 2015 AND 2016 INTERIM REVISIONS. 3. PRE-TREATMENT STRUCTURES NOT SHOWN. 4. FOR INFILTRATION APPLICATIONS, GEOTEXTILE ENVELOPING R-TANK SHALL BE ACF M200 (PER SPEC SECTION 2.02A) AND BASE SHALL BE 4" MIN. UNCOMPACTED FREE DRAINING BACKFILL (SPEC SECTION 2.03A) TO PROVIDE A

LEVEL BASE. SURFACE MUST BE SMOOTH, FREE OF LUMPS OR DEBRIS, AND EXTEND 2' BEYOND R-TANK^{XD} COVER FROM FINISH GRADE TO TOP OF TANK:

6" MIN. to 200" MAX.

COMPACT SIDE BACKFILL WITH

POWERED MECHANICAL COMPACTOR IN

12" INLET PIPE-21.83 BOTTOM TANKS 21.50 BOTTOM STONE 4" MIN.—— R-TANK^{XD} UNITS WRAPPED IN 8 _ -12" OUTLET PIPE OZ NONWOVEN GEOTEXTILE (OR - SIDE BACKFILL: 24" MIN. OF FREE EQUAL), LOADING RATING: 240.2 BASE: 4" MIN. FREE DRAINING BACKFILL (SPEC SECTION 2.03B) COMPACTED TO 95% STANDARD DRAINING BACKFILL (SPEC SECTION PSI (MODULE ONLY) TP-2 PROCTOR DENSITY IS REQUIRED TO PROVIDE A 2.03B): STONE <1.5" OR SOIL (USCS EXCAVATION LINE -ESHGW ELEV. 17.50 LEVEL BASE SURFACE. MUST BE SMOOTH, FREE CLASS GW, GP, SW OR SP). MUST BE OF LUMPS OR DEBRIS, AND EXTEND 2' BEYOND FREE FROM LUMPS, DEBRIS AND OTHER R-TANK^{XD} FOOTPRINT. A BEARING CAPACITY OF SHARP OBJECTS. SPREAD EVENLY TO PREVENT R-TANK^{XD} MOVEMENT. 2,000 PSF MUST BE ACHIEVED PRIOR TO

PAVED

SURFACE

OWNER'S ENGINEER. 12" LIFTS. R-TANK^{XD} TANK WRAP & EXCAVATION ENVELOPE DETAIL

INSTALLING R-TANK^{XD}. NATIVE SOILS MAY BE

ACCEPTABLE IF DETERMINED TO BE STABLE BY

ARCHITECT

BOSTON, MA 02118 0: 617.765.8000

97 LIBBEY PARKWAY

WEYMOUTH, MA 02189

CONSULTANTS

NORWELL, MA 02061

781.792.3900

SUITE 304

www.embarcdesign.com

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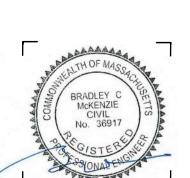
150 LONGWATER DRIVE, SUITE 101

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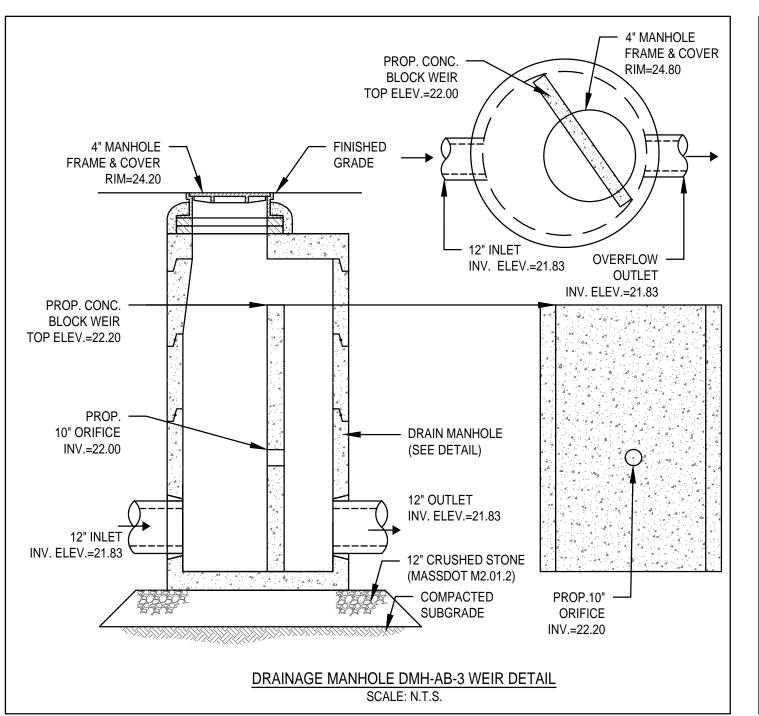



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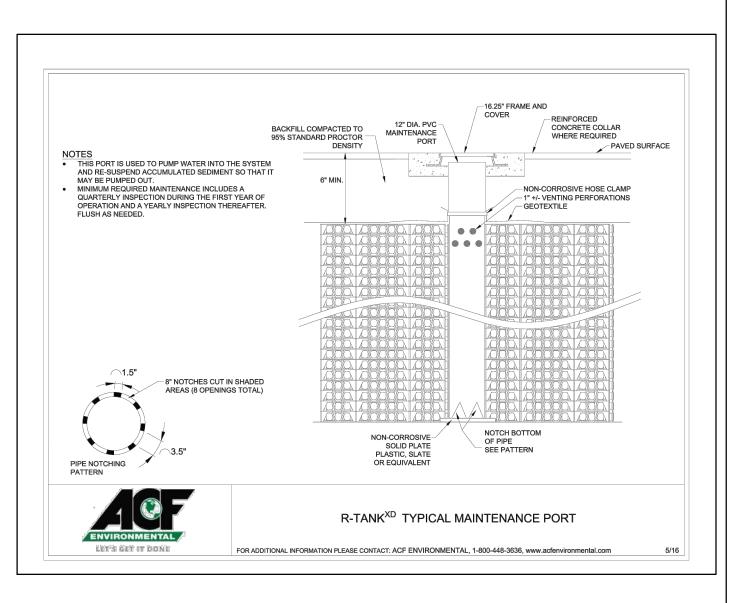
AUGUST 4, 2023 PROJECT #: 22034 SCALE: NOT TO SCALE


DRAWING TITLE

CONSTRUCTION DETAILS





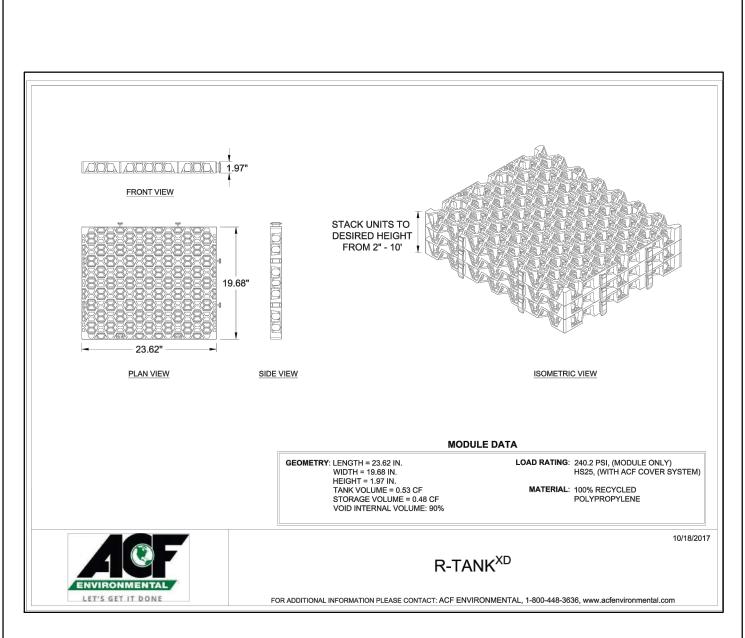

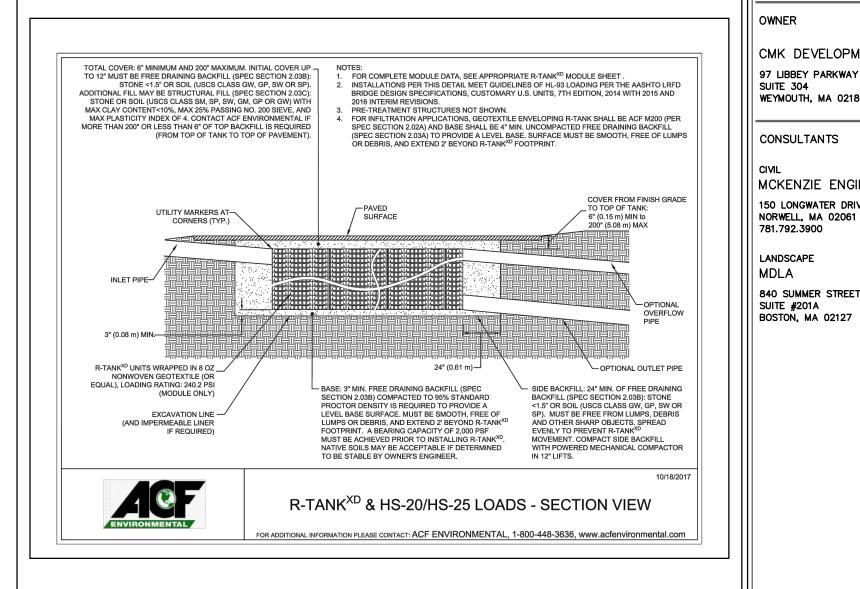



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OWNER

CMK DEVELOPMENT PARTNERS 97 LIBBEY PARKWAY SUITE 304 WEYMOUTH, MA 02189

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MCKENZIE ENGINEERING GROUP 150 LONGWATER DRIVE, SUITE 101

LANDSCAPE MDLA 840 SUMMER STREET

SUITE #201A BOSTON, MA 02127

NOTES:

- EXCAVATE BELOW BOTTOM OF CRUSHED STONE BASE AND BACKFILL WITH CLEAN GRAVEL BORROW (MASS. HIGHWAY M1.03.0 TYPE B) TO NATURALLY OCCURRING PERVIOUS MATERIAL. (REFER TO TEST PIT SOIL LOGS SUBMITTED HEREWITH).
- INSTALLATION AND INSPECTION OF ALL SUBSURFACE INFILTRATION AND DETENTION SYSTEMS SHALL BE PERFORMED AND WRITTEN APPROVAL OBTAINED BEFORE CONSTRUCTION OF THE ACCESS ROAD AND PARKING LOT BASE COURSE BEGINS.

CRUSHED STONE:


SHALL BE DURABLE CRUSHED ROCK CONSISTING OF ANGULAR FRAGMENTS, FREE FROM A DETRIMENTAL QUANTITY OF THIN, FLAT, ELONGATED PIECES OR DURABLE CRUSHED GRAVEL STONE OBTAINED BY ARTIFICIAL CRUSHING OF BOULDERS OR FIELDSTONE. THE CRUSHED STONE MUST BE FREE FROM CLAY, LOAM, OR DELETERIOUS MATERIAL.


CRUSHED STONE TO CONFORM TO THE FOLLOWING GRADATIONS:


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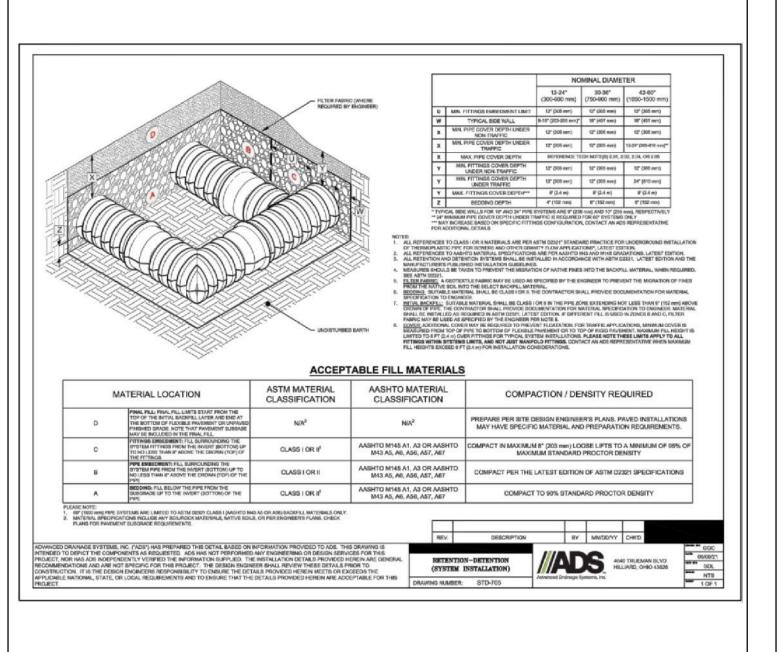
STONE SIZE


SIEVE SIZE	1 1/4 INCH	3/4 INCH	1/2 INCH	3/8 INCH
2"				
1 1/2"	100			
1 1/4"	85-100			
1"		100		
3/4"	10-40	90-100		
5/8"				100
1/2"	0-8	10-50	85-100	100
3/8"		0-20	14-45	85-100
#4		0-5	0-15	20-20
#8			0-5	0-15
#16				0-5




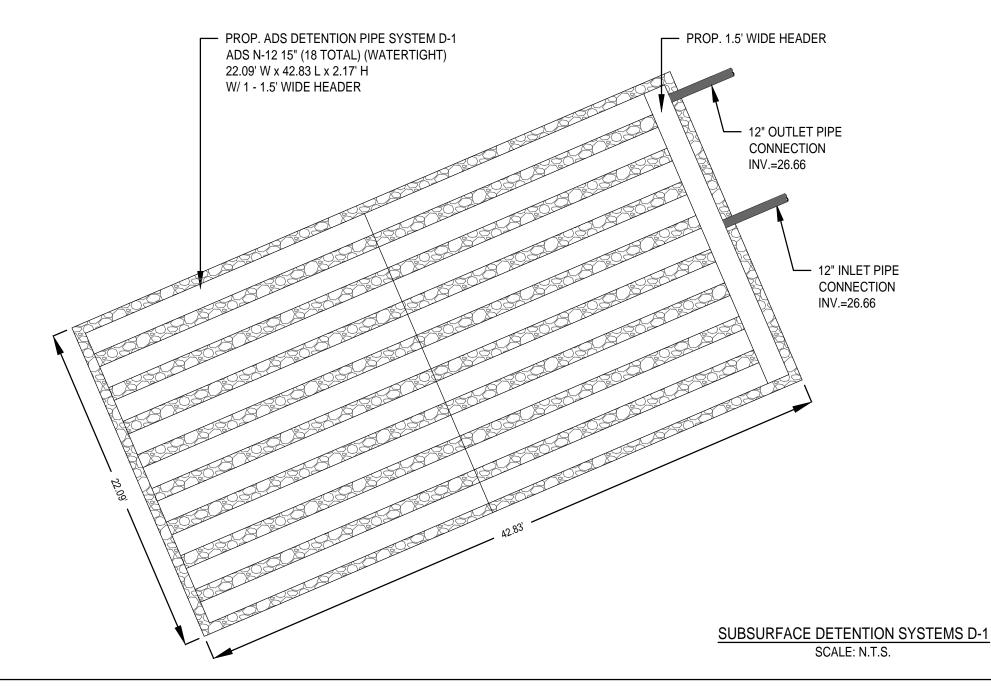

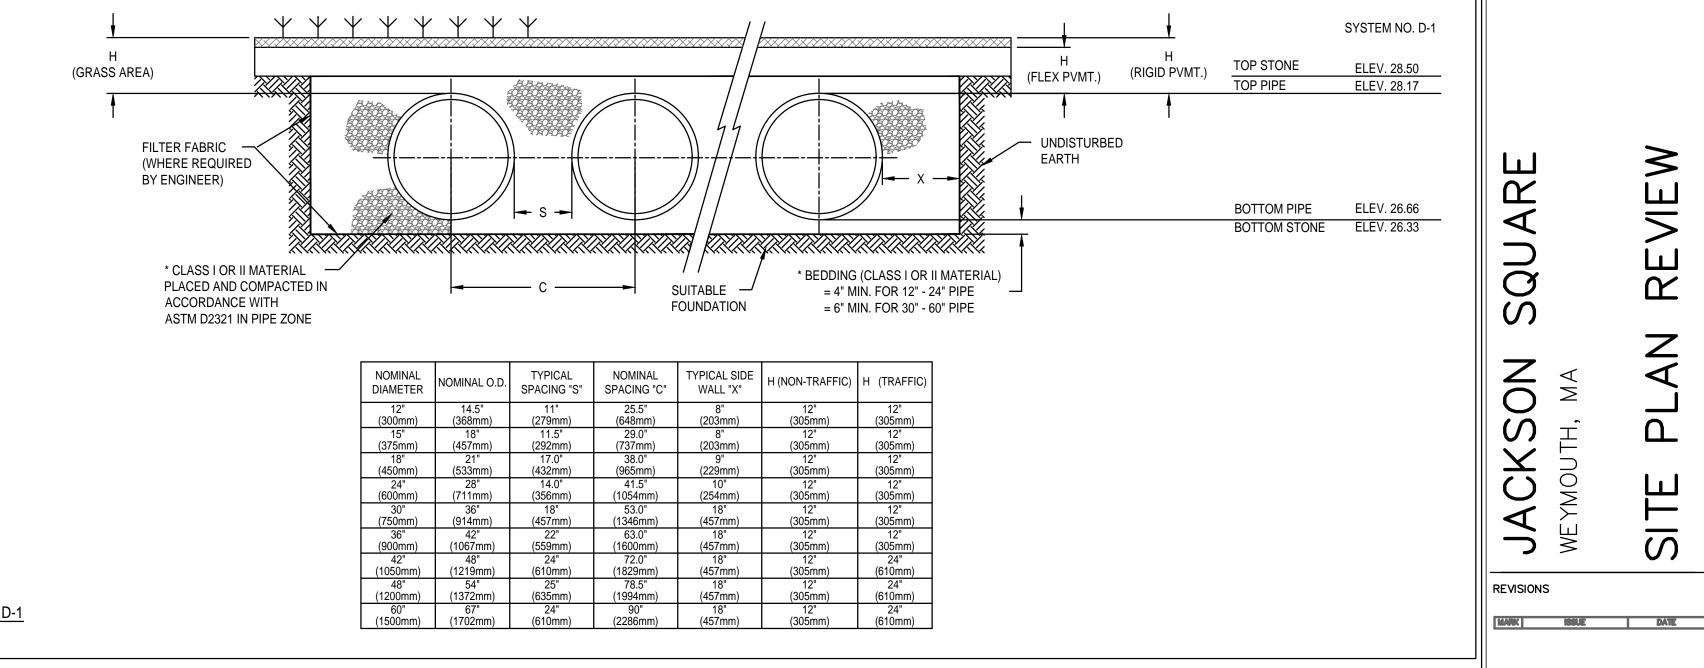

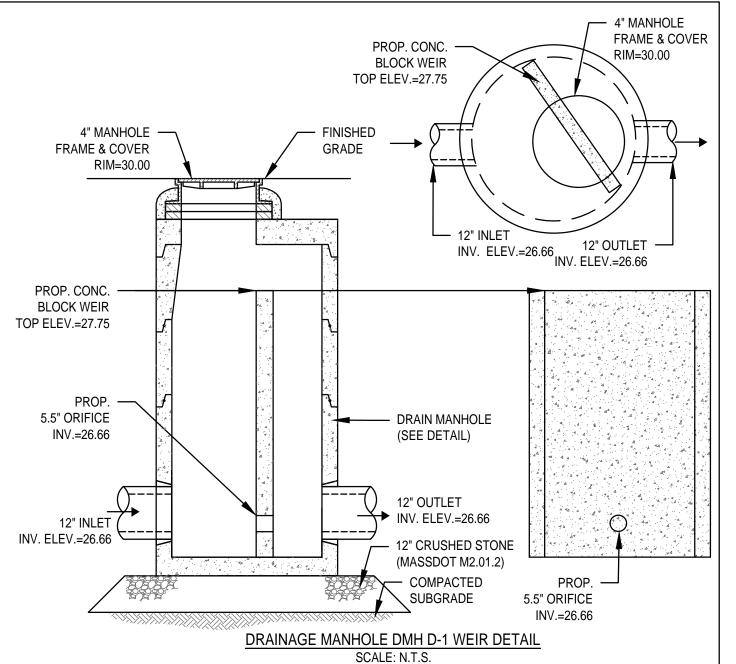

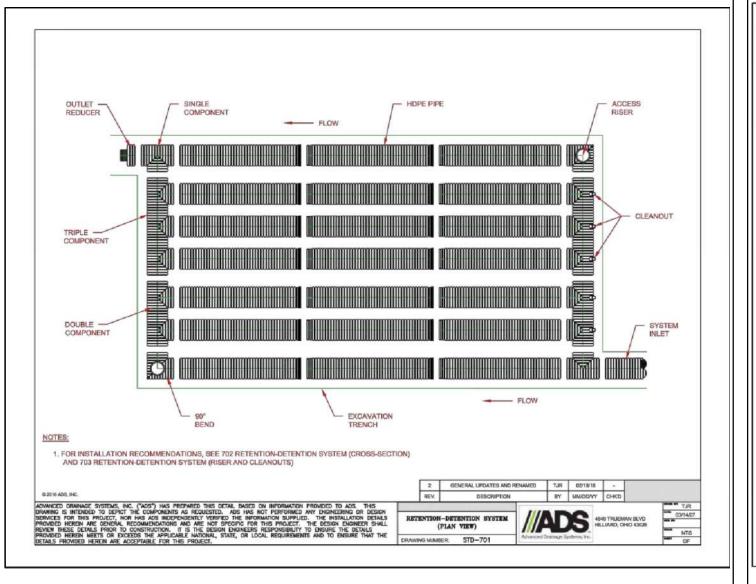

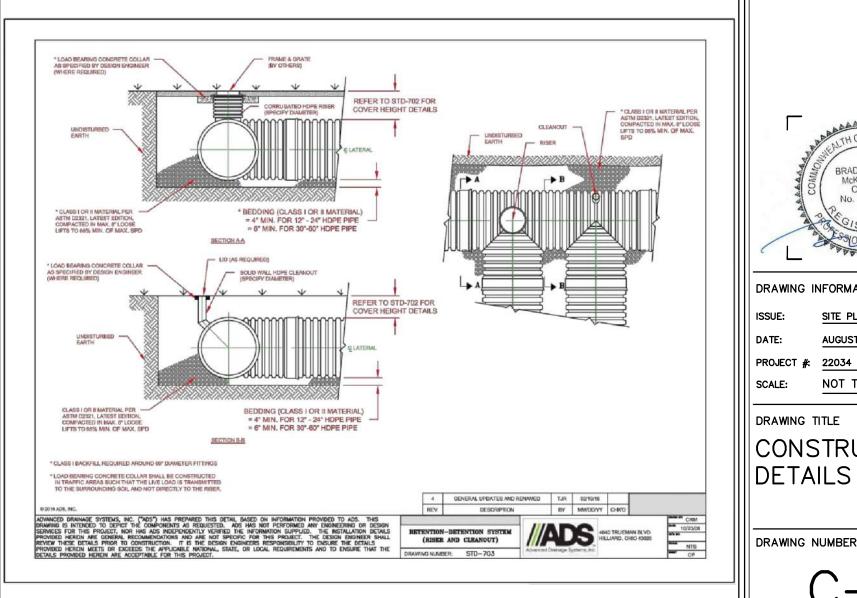




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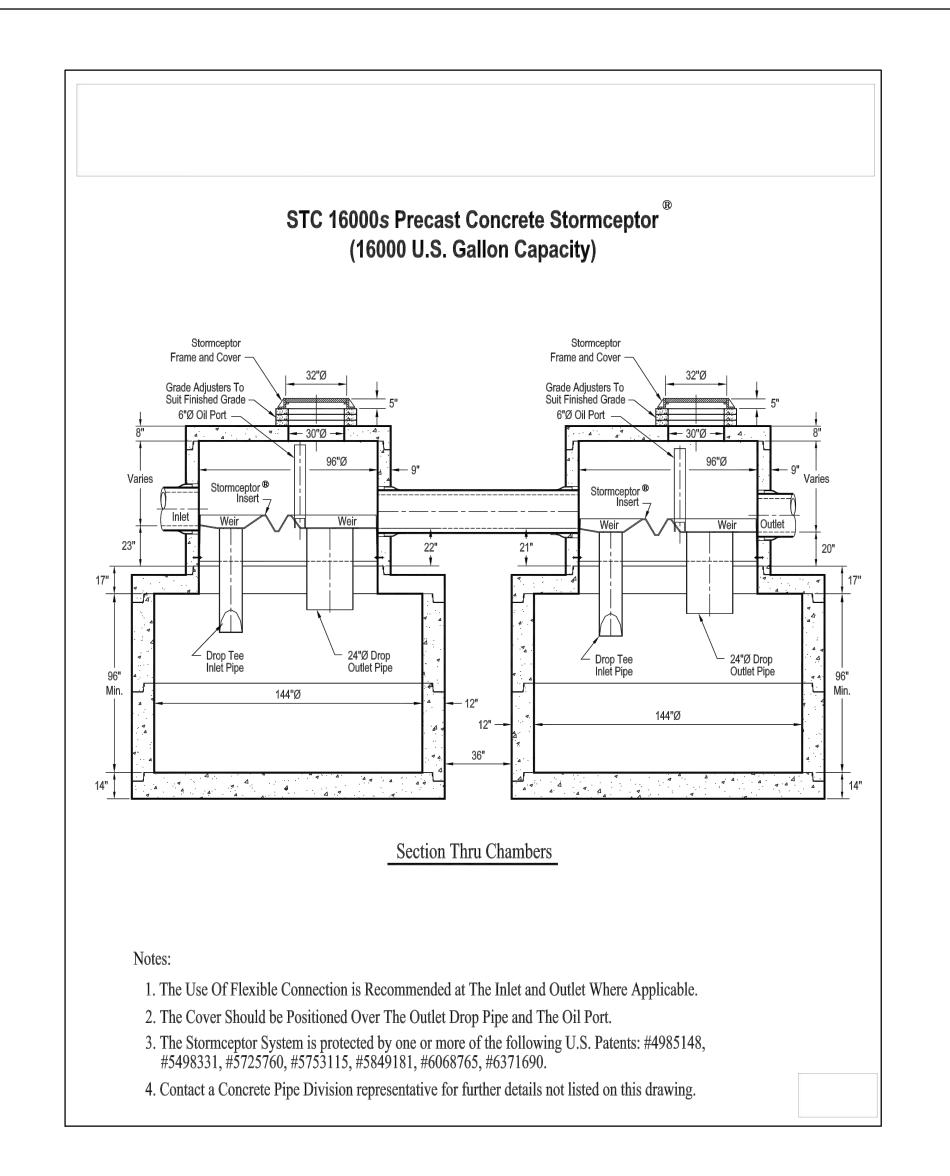
DRAWING TITLE CONSTRUCTION



CONTRACTOR TO GROUT — TO FINISHED GRADE GRADE RINGS/RISERS -(NOT PROVIDED BY CONTECH) PERMANENT POOL ELEVATION STRUCTURE 6" Ø OIL INSPECTION PIPE (TOP 1" MIN. VARIES FROM INSIDE OF STORMCEPTOR — TOP SLAB) INSERT GRATE FLOW INLET 6" Ø ORIFICE PLATE - SAFETY GRATE OVER L____J **OUTLET RISER** 1'-6" (4'-6" MIN.) TOP SLAB ACCESS TO BE ORIENTED OVER OIL 12" Ø DROP INSPECTION PIPE AND PLAN VIEW
TOP SLAB NOT SHOWN OUTLET RISER OUTLET RISER (SEE FRAME AND COVER DETAIL) SOLIDS STORAGE SECTION A-A CONTECH GENERAL NOTES

1. CONTECH TO PROVIDE ALL MATERIALS UNLESS NOTED OTHERWISE. 2. FOR SITE SPECIFIC DRAWINGS WITH DETAILED STRUCTURE DIMENSIONS AND WEIGHT, PLEASE CONTACT YOUR CONTECH ENGINEERED SOLUTIONS LLC REPRESENTATIVE. www.ContechES.com 3. STORMCEPTOR WATER QUALITY STRUCTURE SHALL BE IN ACCORDANCE WITH ALL DESIGN DATA AND FRAME AND COVER INFORMATION CONTAINED IN THIS DRAWING. CONTRACTOR TO CONFIRM STRUCTURE MEETS REQUIREMENTS OF PROJECT. NOT TO SCALE 4. STORMCEPTOR STRUCTURE SHALL MEET AASHTO HS20 LOAD RATING, ASSUMING EARTH COVER OF 0' - 2', AND GROUNDWATER ELEVATION AT, OR BELOW, THE OUTLET PIPE INVERT ELEVATION. ENGINEER OF RECORD TO CONFIRM ACTUAL GROUNDWATER ELEVATION. CASTINGS SHALL MEET AASHTO M306 AND BE CAST WITH THE 5. STORMCEPTOR STRUCTURE SHALL BE PRECAST CONCRETE CONFORMING TO ASTM C478 AND AASHTO LOAD FACTOR DESIGN METHOD. INSTALLATION NOTES

A. ANY SUB-BASE, BACKFILL DEPTH, AND/OR ANTI-FLOTATION PROVISIONS ARE SITE-SPECIFIC DESIGN

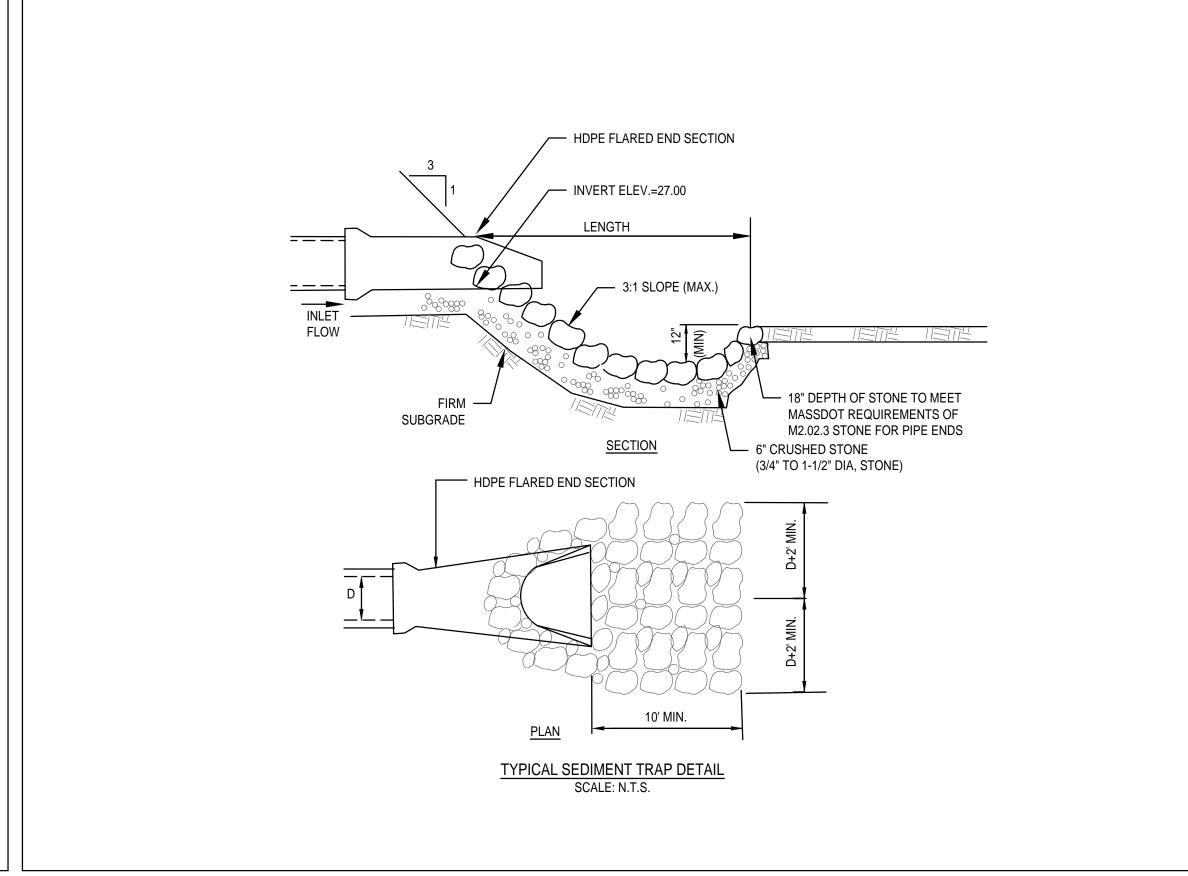



BOSTON, MA 02118 0: 617.765.8000 www.embarcdesign.com

CMK DEVELOPMENT PARTNERS 97 LIBBEY PARKWAY SUITE 304 WEYMOUTH, MA 02189

CONSULTANTS

MCKENZIE ENGINEERING GROUP 150 LONGWATER DRIVE, SUITE 101 NORWELL, MA 02061 781.792.3900

LANDSCAPE MDLA 840 SUMMER STREET SUITE #201A BOSTON, MA 02127

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AUGUST 4, 2023

PROJECT #: 22034 SCALE: NOT TO SCALE

DRAWING TITLE

CONSTRUCTION DETAILS

DRAWING NUMBER

CONSIDERATIONS AND SHALL BE SPECIFIED BY ENGINEER OF RECORD.

B. CONTRACTOR TO PROVIDE EQUIPMENT WITH SUFFICIENT LIFTING AND REACH CAPACITY TO LIFT AND SET THE STORMCEPTOR MANHOLE STRUCTURE.

C. CONTRACTOR TO INSTALL JOINT SEALANT BETWEEN ALL STRUCTURE SECTIONS AND ASSEMBLE STRUCTURE. D. CONTRACTOR TO PROVIDE, INSTALL, AND GROUT INLET AND OUTLET PIPE(S). MATCH PIPE INVERTS WITH

ELEVATIONS SHOWN. ALL PIPE CENTERLINES TO MATCH PIPE OPENING CENTERLINES. E. CONTRACTOR TO TAKE APPROPRIATE MEASURES TO ASSURE UNIT IS WATER TIGHT, HOLDING WATER TO

FLOWLINE INVERT MINIMUM. IT IS SUGGESTED THAT ALL JOINTS BELOW PIPE INVERTS ARE GROUTED.


STC 900 STORMCEPTOR STANDARD DETAIL SCALE: N.T.S.


GENERAL NOTES


- 1. IF SHEETING IS USED, IT SHALL BE CUT OFF NO MORE THAN 12" ABOVE TOP OF PIPE.
- 2. ALL PIPES SHALL BE PRESSURE TESTED AT 200 PSI WORKING PRESSURE FOR A MINIMUM DURATION OF TWO
- 3. WATER SYSTEM IS TO BE DISINFECTED TO 50 P.P.M. AVAILABLE CHLORINE AND AFTER 24 HOURS TO 25 P.P.M. OR AS REQUIRED BY PEMBROKE WATER SUPERINTENDENT/ENGINEER.
- 4. WATER PIPE IS TO BE CEMENT LINED DUCTILE IRON "TYTON" OR EQUAL TYPE JOINT, CONFORMING TO A.N.S.I./A.W.W.A. C150/A21.50. CLASS 52. AS APPROVED BY THE TOWN'S WATER SUPERINTENDENT/ENGINEER.
- ALL PIPING SHALL BE INSTALLED AND TESTED IN ACCORDANCE WITH A.W.W.A. STANDARDS PRIOR TO PAVING IF
- PAVING ABOVE TRENCH IS REQUIRED.
- 6. BACKFILL IS TO BE COMPACTED TO 90% MAXIMUM DRY DENSITY BY AASHTO T-180 D.


7. ALL WATER PIPE SHALL BE LAID WITH A MINIMUM OF 5 FEET OF COVER OF APPROVED MATERIALS.

- 8. RESULTS FROM PRESSURE TESTING AND DISINFECTION SHALL BE FURNISHED TO THE DIRECTOR OF PUBLIC WORKS FOR APPROVAL PRIOR TO WATER BEING TURNED ON.
- 9. ALL WORK SHALL BE IN CONFORMANCE WITH PEMBROKE WATER DEPARTMENT STANDARDS.
- 10. ALL PERMITS REQUIRED FOR STREET OPENINGS AND WATER MAIN TAPPING MUST BE OBTAINED.
- 11. NO WATER WILL BE TURNED ON IN THE PROJECT WITHOUT WATER DEPARTMENT APPROVAL.

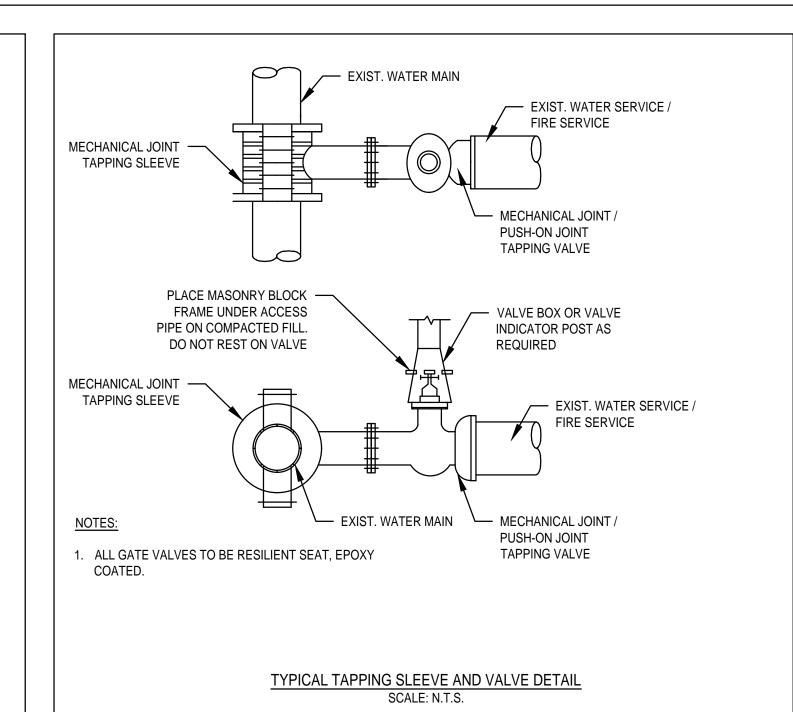

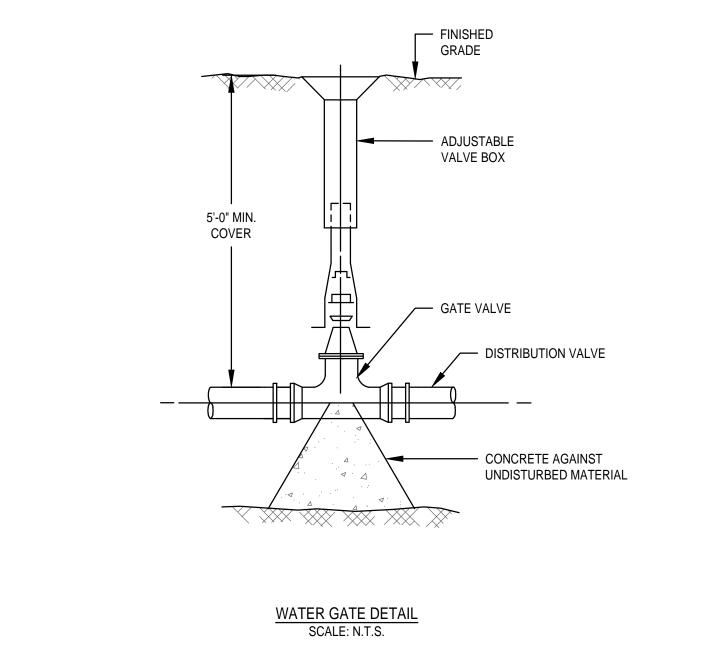

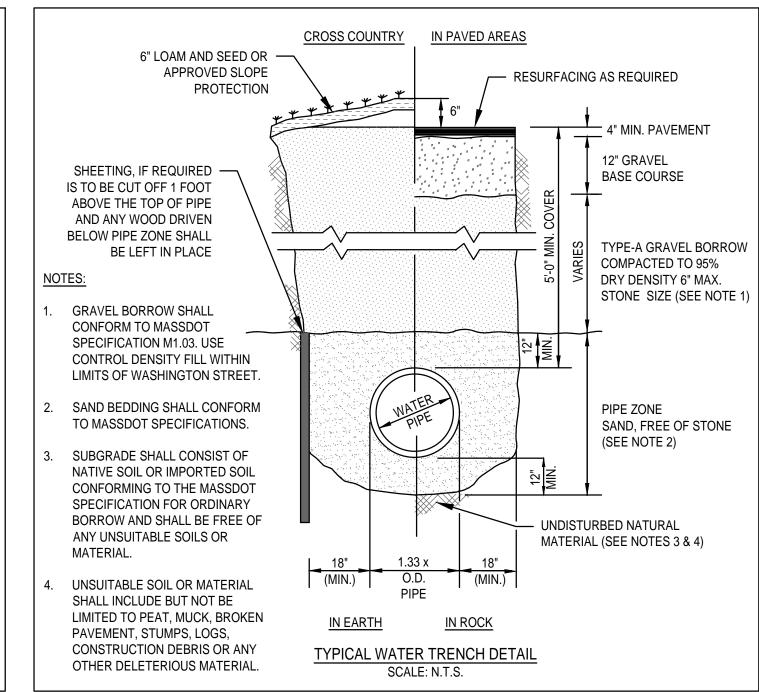

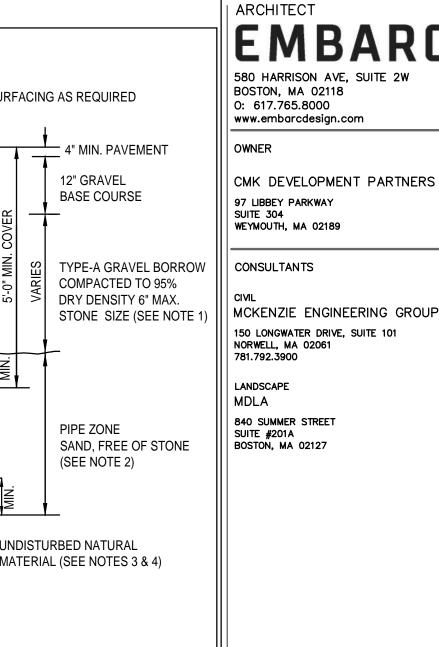


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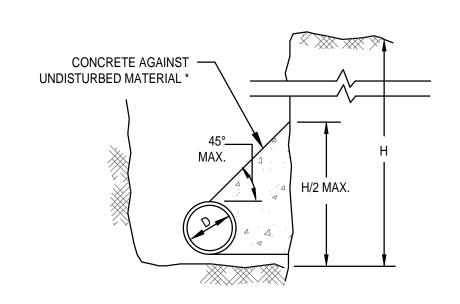
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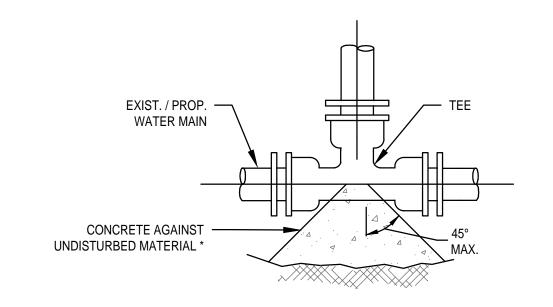
THRUST WATER MAIN PLUG SCALE: N.T.S.



THRUST WATER MAIN THRUST BLOCK SECTION DETAIL SCALE: N.T.S.


THRUST BLOCK BEARING AREAS FOR WATER PIPE

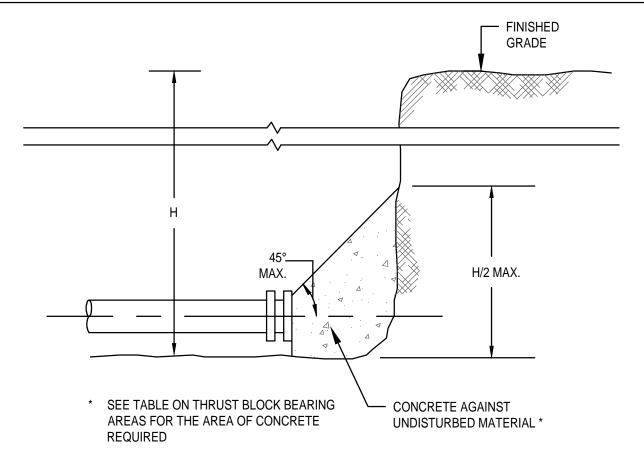TABLE OF BEARING AREAS IN SQ. FT. AGAINST UNDISTURBED MATERIAL FOR WATER MAIN FITTINGS*							
SIZE OF MAIN (IN.)	90° BEND	TEES AND PLUGS	45° BEND				
6	4	2.5	2				
8	6	4	3				
12	12	9	7				
16	21	16	12				



* SEE TABLE ON THRUST BLOCK BEARING AREAS FOR THE AREA OF CONCRETE REQUIRED

TYPICAL WATER MAIN TEE THRUST BLOCK DETAIL SCALE: N.T.S.

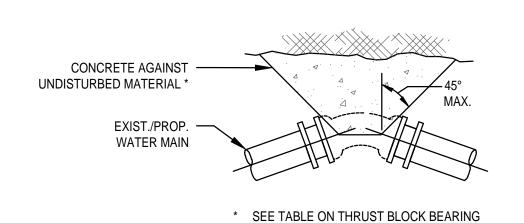

REQUIRED

THRUST WATER MAIN BEND THRUST BLOCK DETAIL SCALE: N.T.S.

AREAS FOR THE AREA OF CONCRETE


NOTES:

- 1. FOR FITTINGS WITH LESS THAN 45° DEFLECTION, USE BEARING AREAS FOR 45° BEND.
- 2. BEARING AREAS BASED ON HORIZONTAL PASSIVE SOIL PRESSURE OF 2000 P.S.F. AND INTERNAL WATER PRESSURE OF 150 P.S.I.G. JOINTS SHALL NOT BE ENCASED IN CONCRETE. BEARING AREAS MAY BE DIREGARDED FOR TRENCHES IN ROCK WHERE THE TOP OF THE ROCK FACE IS AT OR ABOVE THE CROWN OF THE PIPE. HOWEVER, CONCRETE BACKING SHALL BE PLACED BETWEEN THE PIPE AND THE ROCK FACE
- 3. THE CONTRACTOR SHALL SUBMIT 2 WEEKS IN ADVANCE OF PLACEMENT, WORKING DRAWINGS FOR EACH THRUST BLOCK TO THE ENGINEER FOR APPROVAL PRIOR TO INSTALLATION.
- 4. ALL VALVES AND FITTINGS SHALL BE RODDED TOGETHER.

ASSUMPTIONS:

THRUST BLOCK DETAILS

* TYPE OF SOIL IS MEDIUM CLAYEY, 6 OR MORE BLOWS PER FOOT, OR LOOSE GRANULAR, 9 OR MORE BLOWS PER FOOT. SOIL CONDITIONS OTHER THAN THOSE GIVEN WILL REQUIRE LARGER BEARING AREAS.

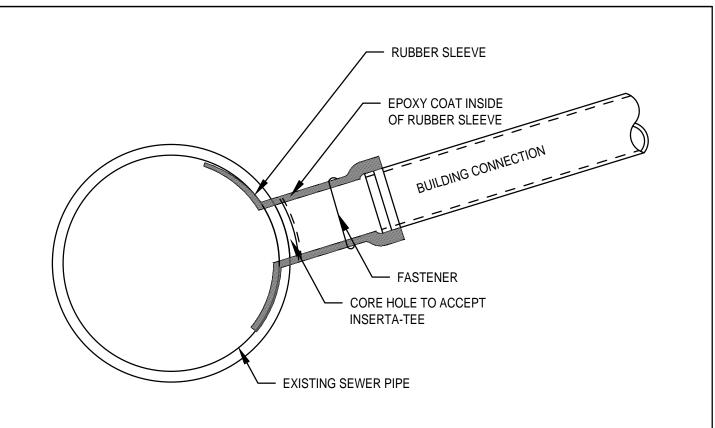

A. BELL END ACCEPTS PIPE WITH SDR 26, SDR 35 AND ASTM D3034 OR EQUIVALENT O.D. SPECIFICATION IN 4" AND 6" SIZES.

B. CURVATURE VARIES WITH MAINLINE DIAMETERS.

C. SPIGOT END SDR 26, PVC SDR 35, ASTM D3034 DIAMETERS: 4" AND 6"

PART NAME **HUB ADAPTOR** RUBBER GASKET SECURING CLAMP*

RUBBER SLEEVE **UPPER SEGMENT**** LOWER SEGMENT***

* OPTIONAL: #316 STAINLESS STEEL BAND, SCREW AND HOUSING ** DISTANCE BETWEEN 4A AND 4B WILL VARY BY PRODUCT TYPE *** WILL NOT APPEAR ON RUBBER SLEEVES FOR CONCRETE OR

INSERTA TEE SIZE HOLE DIAMETER 4" (100 mm) 4½" (114 mm) 6" (150 mm) $6\frac{1}{2}$ " (165 mm) MATERIALS


PVC SDR 26 ASTM D3034 ASTM F477 BAND SS #301 SCREW SS #305 HOUSING SS #301 ASTM F477


CLAY PIPE

BUILT IN STOP FOLLOWS CONTOUR OF MAINLINE PIPE (PATENT PENDING) **CUSTOM MADE TO MATCH THE** INTERIOR RADIUS OF THE MAINLINE PIPE OR STRUCTURE

- 1. DETAILS SHOWN ARE FOR INFORMATIONAL PURPOSES ONLY. PRODUCT SPECIFICATIONS AND INSTALLATION SHALL COME FROM MANUFACTURER.
- 2. RECOMMENDED METHOD OF CUTTING HOLE IS WITH HOLE SAW FOR PVC AND OTHER PLASTICS, AND DIAMOND BIT FOR CONCRETES, CLAY, FRP, AND D.I. (SEE INSTALLATION INSTRUCTIONS.)

INSERTA-TEE SEWER CONNECTION TO EXISTING SEWER SCALE: N.T.S.

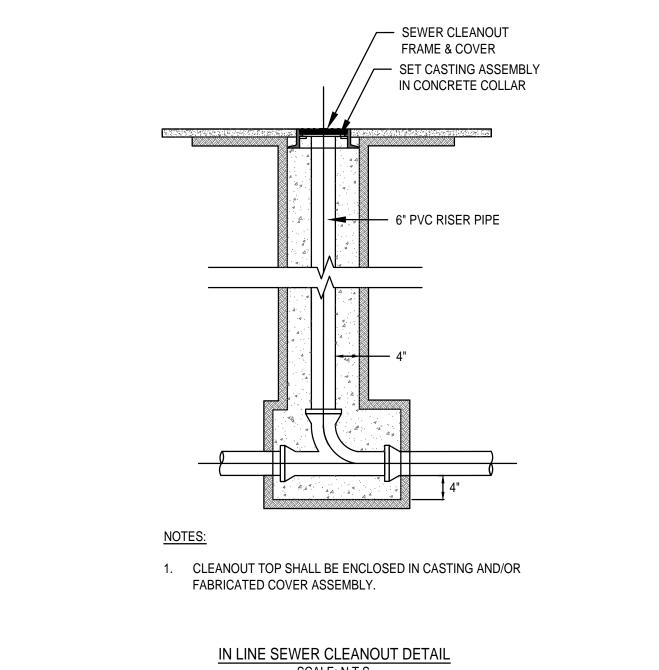

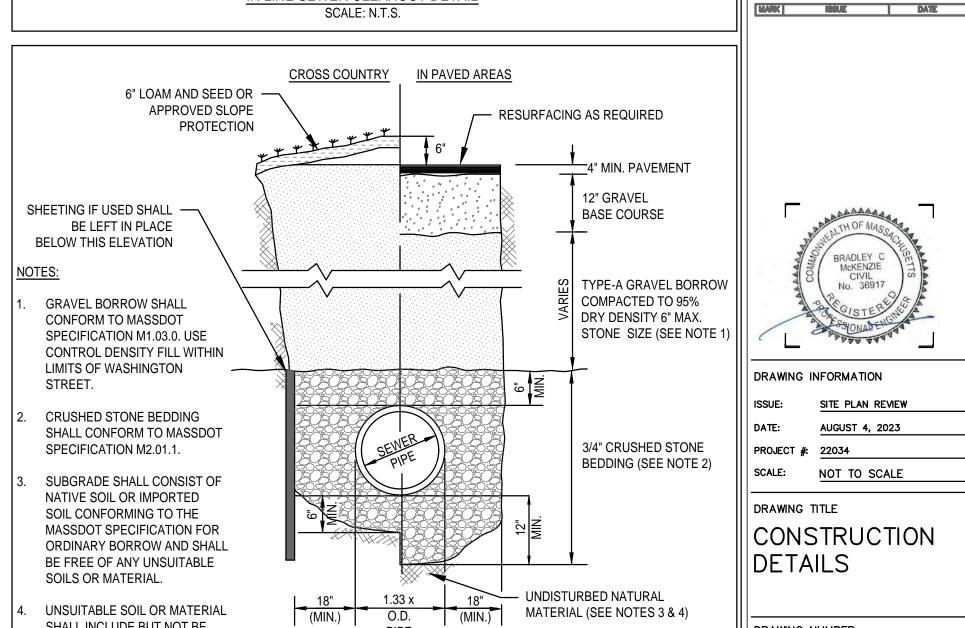

<u>IN EARTH</u>

GRAVITY SEWER TRENCH DETAIL

SCALE: N.T.S.

SHALL INCLUDE BUT NOT BE

LOGS, CONSTRUCTION DEBRIS

OR ANY OTHER DELETERIOUS

LIMITED TO PEAT, MUCK, BROKEN PAVEMENT, STUMPS,


MATERIAL.




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DRAWING INFORMATION SITE PLAN REVIEW AUGUST 4, 2023 PROJECT #: 22034 SCALE: NOT TO SCALE

DRAWING TITLE CONSTRUCTION DETAILS



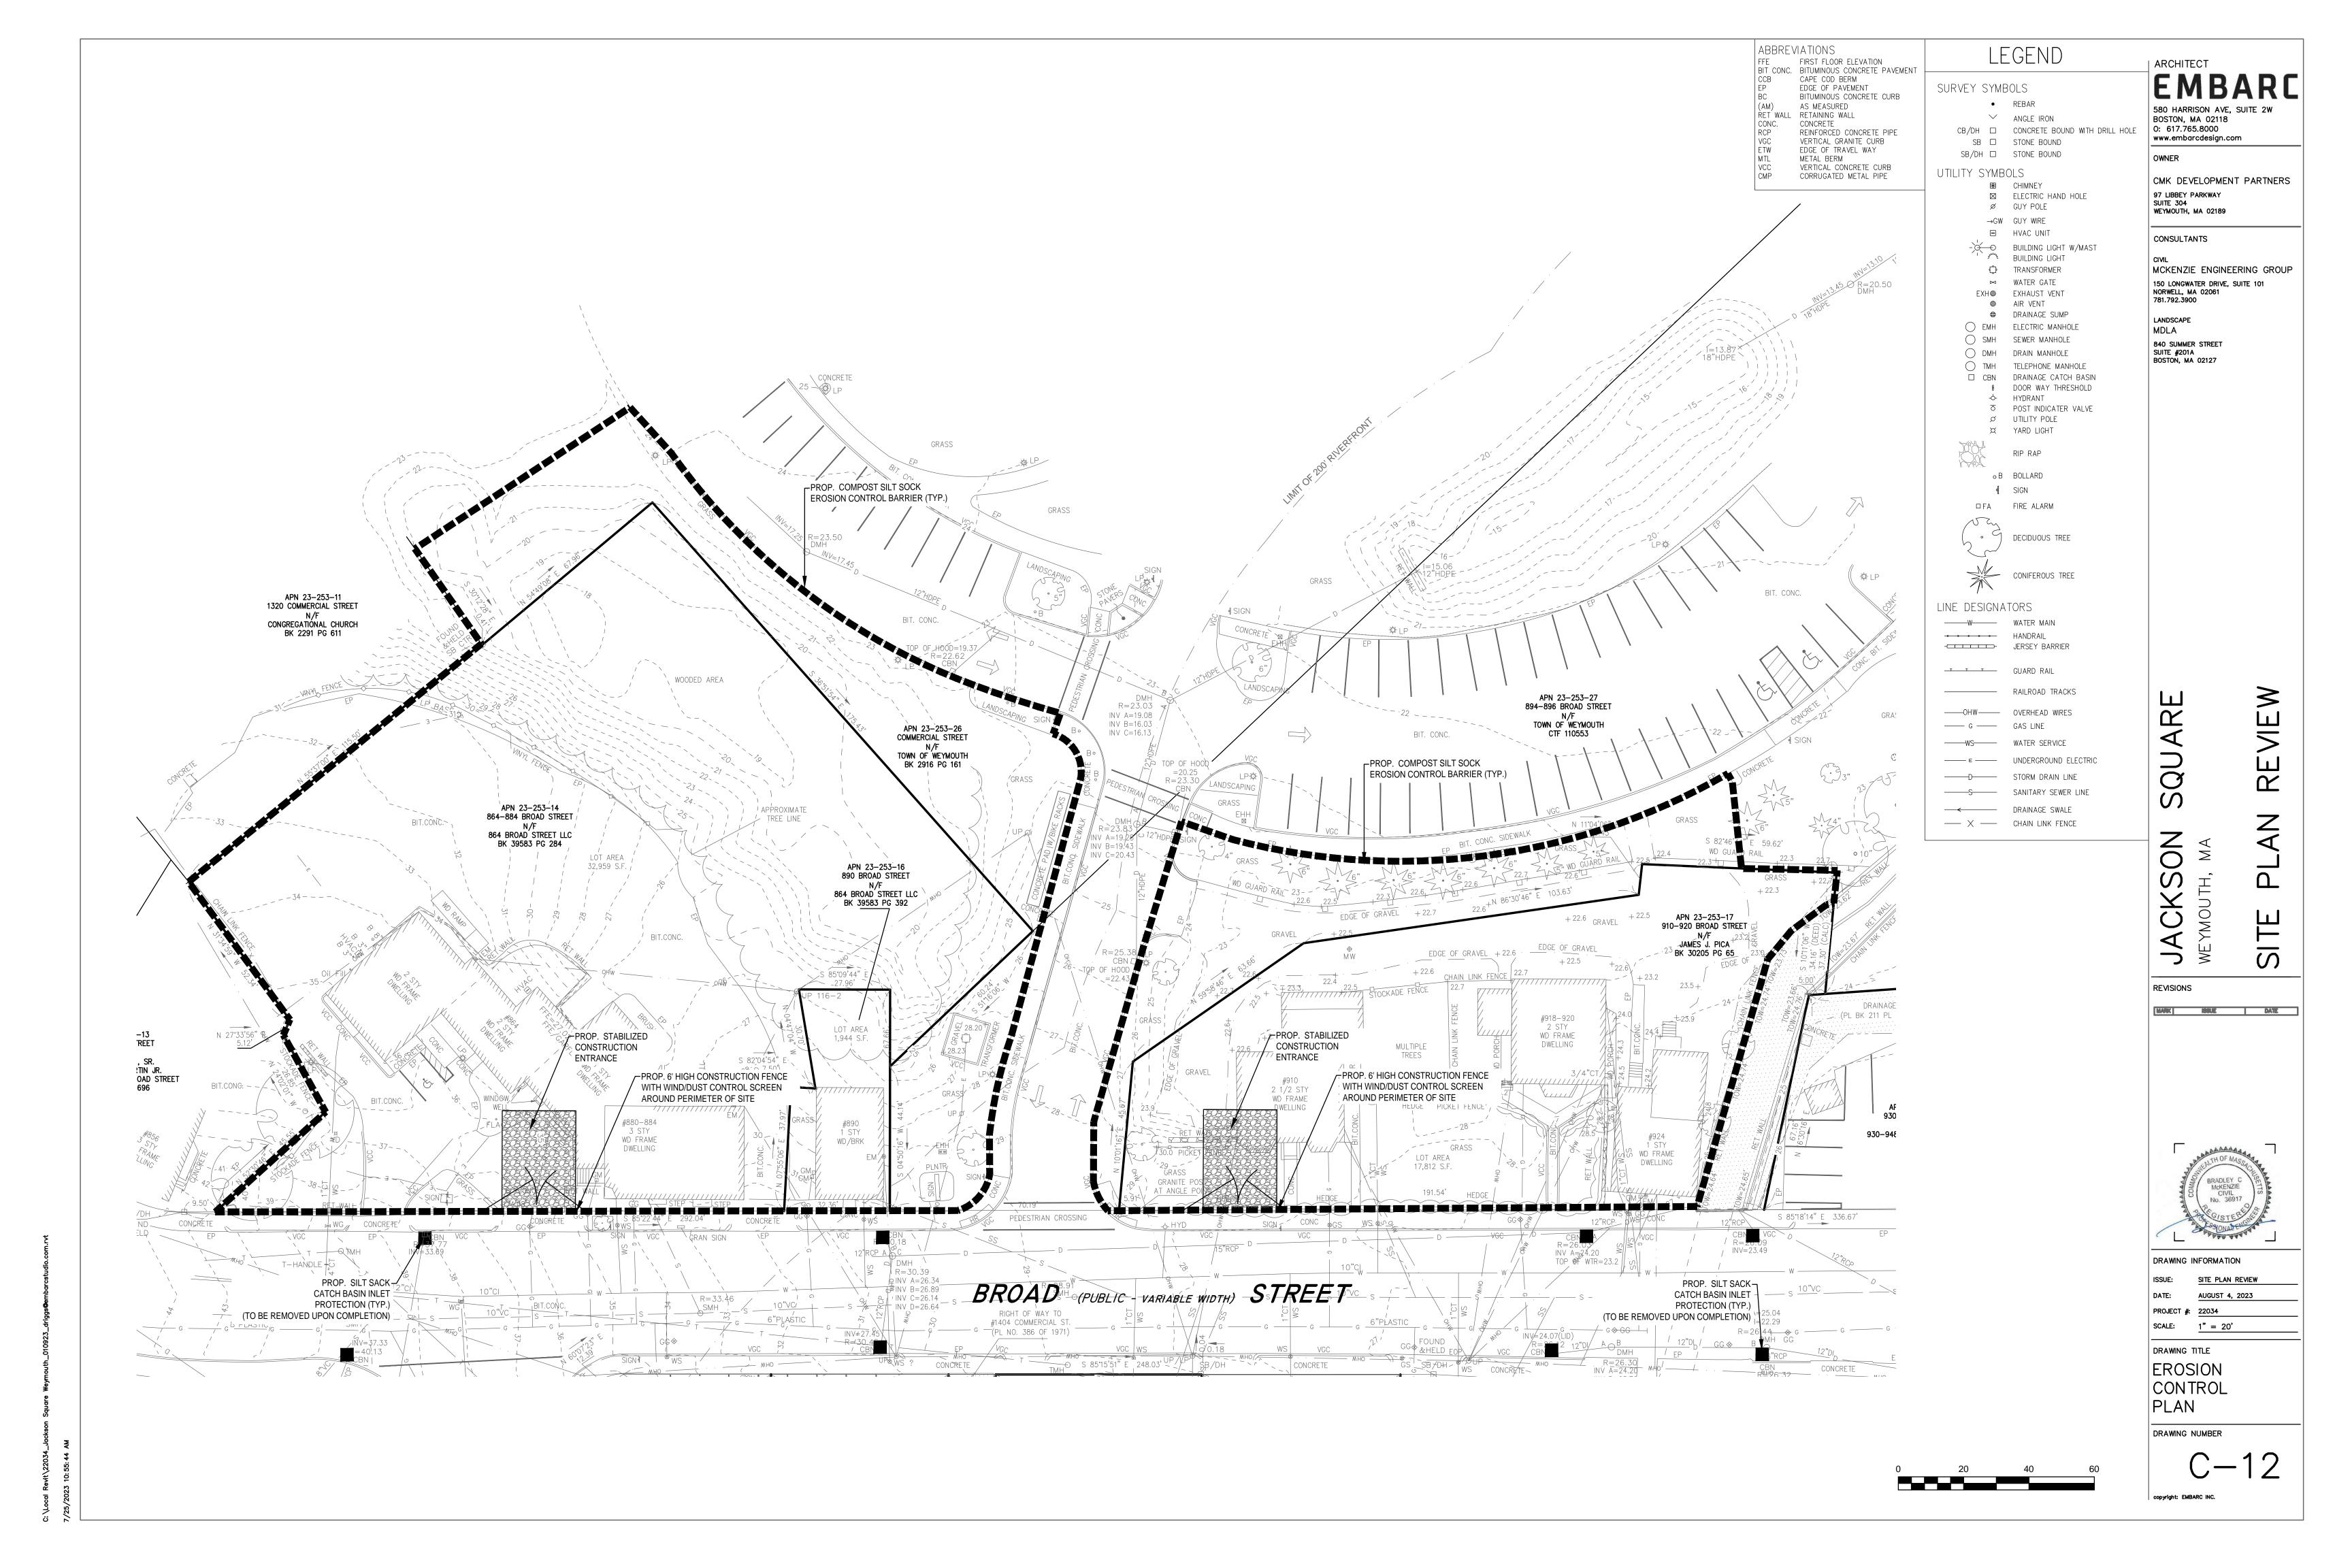

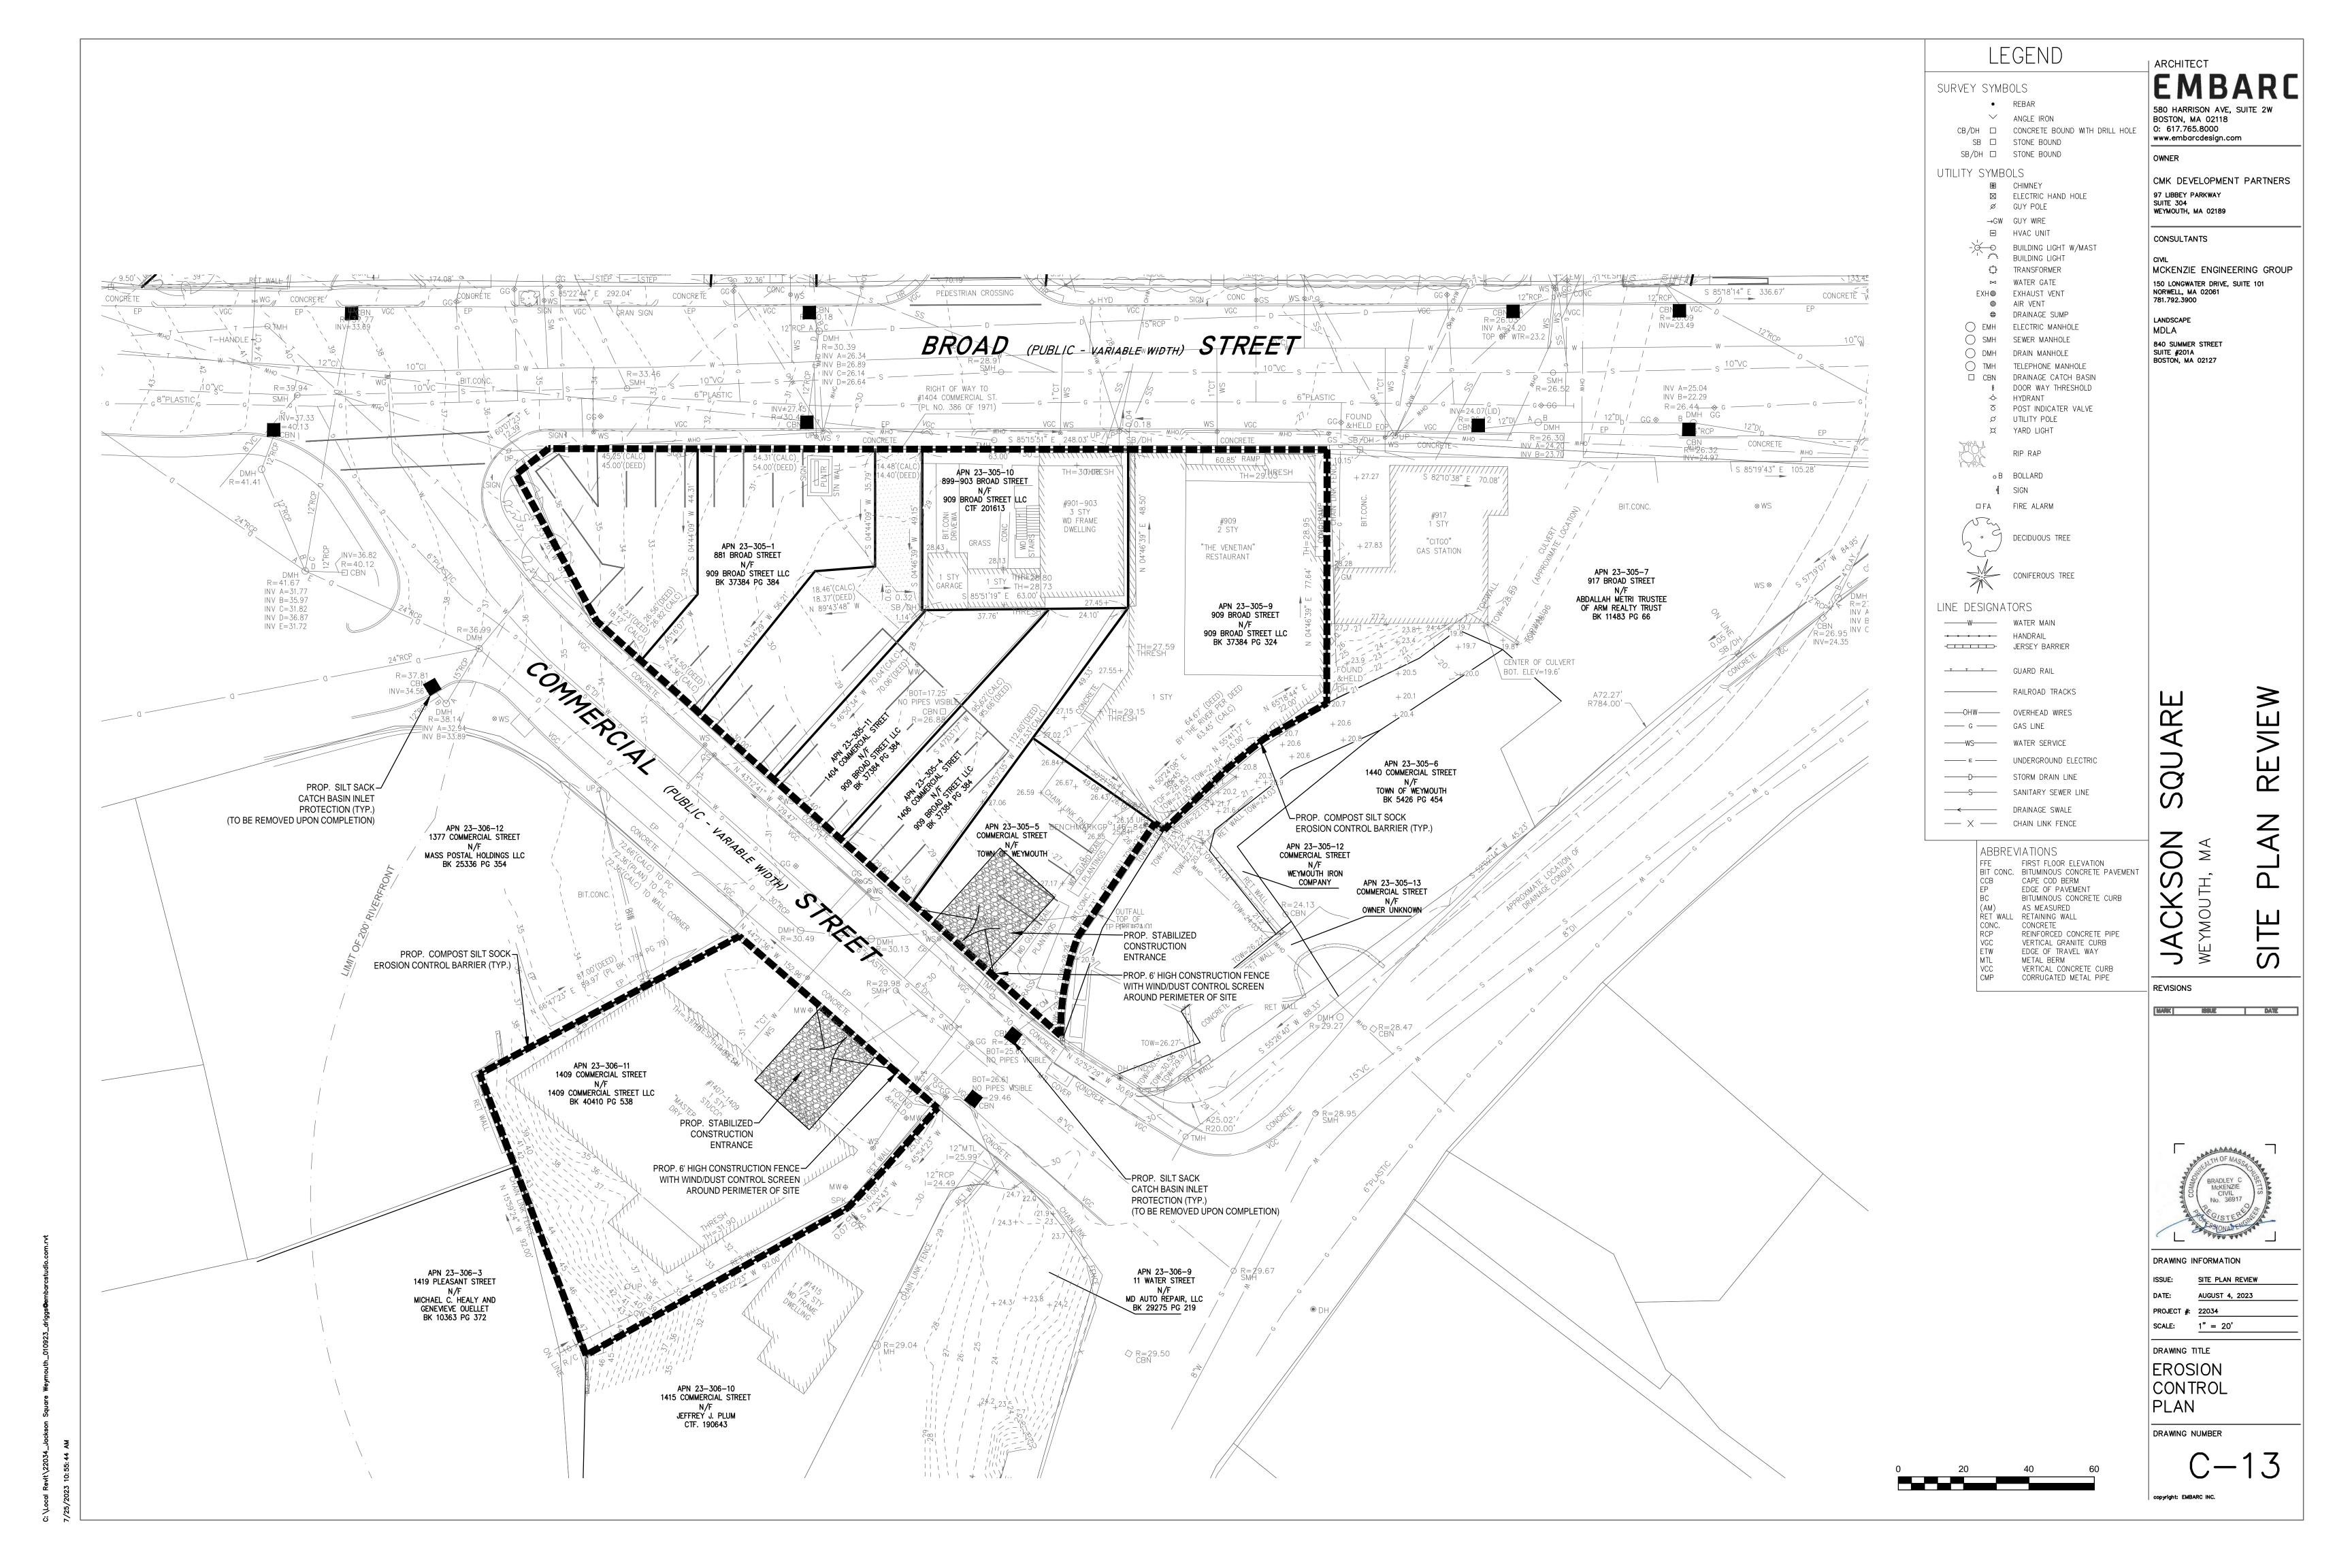
TO PREVENT EXCESSIVE EROSION AND SILTING, THE FOLLOWING CONSTRUCTION SEQUENCE COUPLED WITH OTHER WIDELY ACCEPTED PRINCIPALS FOR REDUCING EROSION AND SEDIMENTATION SHALL BE IMPLEMENTED IN THE DEVELOPMENT OF THE SITE.

- 1. THE CONTRACTOR SHALL COORDINATE A PRE-CONSTRUCTION MEETING PRIOR TO ANY CONSTRUCTION ACTIVITY.
- 2. STABILIZATION PRACTICES FOR EROSION AND SEDIMENT CONTROL SHALL BE INSTALLED PRIOR TO COMMENCING CONSTRUCTION ACTIVITIES. REFER TO "EROSION AND SEDIMENTATION CONTROL" SECTION OF THIS PLAN. CONSTRUCT STABILIZED CONSTRUCTION ENTRANCE AT BROAD STREET AND COMMERCIAL STREET.
- 3. CLEAR AND GRUB UP AS REQUIRED FOR THE CONSTRUCTION OF THE BUILDING AND RELATED INFRASTRUCTURE.
- 4. EXCAVATE TOPSOIL AND SUBSOIL FROM CUT AND FILL AREAS AND STOCKPILE OFF SITE.
- 5. CONSTRUCT CUT AND FILL AREAS. ALL FILL WILL BE INSTALLED USING 12" MAXIMUM COMPACTION LIFTS. PLACE ALL SLOPE PROTECTION WHERE INDICATED ON THE PLAN.
- INSTALL CLOSED DRAINAGE SYSTEM AND OTHER UTILITIES. ALL CATCH BASINS SHALL BE COVERED WITH SILT SACK OR EQUIVALENT INLET PROTECTION.
- GRADE SITE TO SUBGRADE ELEVATIONS AND CONSTRUCT SIDE SLOPES. APPLY TEMPORARY STABILIZATION MEASURES WHERE WARRANTED. REFER TO "EROSION AND SEDIMENTATION CONTROL" SECTION OF THIS PLAN.
- GRADE SLOPES AND STABILIZE CUT AREAS AT TOE OF SLOPES. BLEND ALL INTO EXITING TOPOGRAPHY AND LOAM AND SEED ALL DISTURBED AREAS. SLOPES GREATER THAN 3:1 SHALL BE STABILIZED WITH JUTE MESH.
- 9. COMPLETE FINE GRADING OF SITE AND SIDEWALK CONSTRUCTION.
- 10. REMOVE TEMPORARY EROSION CONTROL DEVICES ONCE ADEQUATE GROWTH IS ESTABLISHED. ADEQUATE GROWTH IS DEFINED AS VEGETATION COVERING 75% OR MORE OF THE GROUND

EROSION AND SEDIMENTATION CONTROL

REFER TO MASS DEP STORMWATER MANAGEMENT HANDBOOK FOR SPECIFICATIONS AND STRUCTURAL AND DUST CONTROL EROSION BEST MANAGEMENT PRACTICES.

- STRUCTURAL PRACTICES UTILIZED FOR THE PROJECT WILL INCLUDE SILT SOCK BARRIER CONTROLS, STABILIZED CONSTRUCTION ENTRANCE, TEMPORARY DIVERSION SWALES WITH STONE CHECK DAMS, SEDIMENT BASINS, AND INLET PROTECTION SUBJECT TO CITY OF WEYMOUTH ENGINEERING APPROVAL.
- STABILIZATION PRACTICES UTILIZED FOR THE PROJECT WILL INCLUDE TEMPORARY SEEDING, GEOTEXTILES (JUTE MESH), MULCHING, AND PERMANENT SEEDING.
- IN GENERAL, THE SMALLEST POSSIBLE AREA OF LAND SHOULD BE EXPOSED AT ONE TIME. WHEN LAND IS EXPOSED DURING DEVELOPMENT, THE EXPOSURE SHALL BE CONFINED TO A MAXIMUM PERIOD OF 3 MONTHS. LAND SHALL NOT BE EXPOSED DURING THE WINTER MONTHS. ANY DISTURBED AREAS WHICH ARE TO BE LEFT TEMPORARILY AND THAT WILL BE REGRADED AT A LATER DATE SHALL BE MACHINE HAY MULCHED AND SEEDED WITH WINTER RYE TO PREVENT EROSION.

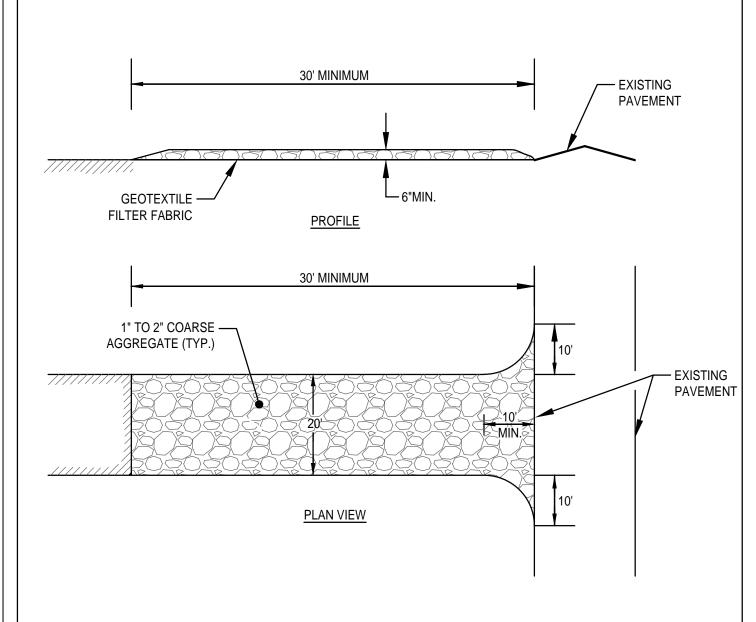

- 1. STONE FOR A STABILIZATION CONSTRUCTION ENTRANCE SHALL BE 1 TO 2 INCH
- STONE, RECLAIMED STONE.

SUBSTITUTED FOR THE PIPE.

- 2. THE LENGTH OF THE STABILIZED ENTRANCE SHALL NOT BE LESS THAN 50 FEET, EXCEPT FOR A SINGLE RESIDENTIAL LOT A 30 FOOT MINIMUM LENGTH WOULD APPLY. 3. THE THICKNESS OF THE STONE FOR THE STABILIZED ENTRANCE SHALL NOT BE LESS THAN 6 INCHES.
- 4. THE WIDTH OF THE ENTRANCE SHALL NOT BE LESS THAN A FULL WIDTH OF THE ENTRANCE WHERE INGRESS OR EGRESS OCCURS OR 10 FEET, WHICH EVER IS
- 5. GEOTEXTILE FILTER CLOTH SHALL BE PLACED OVER THE ENTIRE AREA PRIOR TO PLACING THE STONE.
- 6. ALL SURFACE WATER THAT IS FLOWING TO OR DEVERTED TOWARDS THE CONSTRUCTION ENTRANCE SHALL BE PIPED BENEATH THE ENTRANCE. IF PIPING IS IMPRACTICAL, A BERM WITH 5:1 SLOPES THAT CAN BE CROSSED BY VEHICLES MAY BE
- 7. THE ENTRANCE SHALL BE MAINTAINED IN A CONDITION THAT WILL PREVENT TRACKING OR FLOWING OF SEDIMENT ONTO PUBLIC RIGHTS-OF-WAY. THIS MAY REQUIRE PERIODIC TOPDRESSING WITH ADDITIONAL STONE AS CONDITIONS DEMAND AND REPAIR AND/OR CLEANOUT OF ANY MEASURES USED TO TRAP SEDIMENT. SEDIMENT SPILLED, WASHED, OR TRACKED ONTO PUBLIC RIGHTS-OF-WAY MUST BE REMOVED PROMPTLY.

STABILIZED CONSTRUCTION ENTRANCE (SCE) DETAIL SCALE: N.T.S.


CONSTRUCTION PHASE BMP OPERATION AND MAINTENANCE NOTES:


- 1. REFER TO THE STORMWATER POLLUTION PREVENTION PLAN (SWPPP) PREPARED UNDER THE E.P.A. GENERAL CONSTRUCTION PERMIT PROVISIONS FOR FURTHER DETAIL OF STRUCTURAL, STABILIZATION, DUST CONTROL AND EROSION AND SEDIMENTATION CONTROL MEASURES.
- 2. STRUCTURAL PRACTICES UTILIZED FOR THE PROJECT WILL INCLUDE EROSION CONTROL BARRIERS, STABILIZED CONSTRUCTION ENTRANCES, TEMPORARY DIVERSION SWALES WITH CHECK DAMS, SEDIMENT BASINS, AND INLET PROTECTION.
- 3. STABILIZATION PRACTICES UTILIZED FOR THE PROJECT WILL INCLUDE TEMPORARY SEEDING, GEOTEXTILES (JUTE MESH), MULCHING, AND PERMANENT SEEDING.
- 4. OPERATOR PERSONNEL MUST INSPECT THE CONSTRUCTION SITE AT LEAST ONCE EVERY 14 CALENDAR DAYS AND WITHIN 24 HOURS OF A STORM EVENT OF 1/2 INCH OR GREATER. THE INSPECTOR SHOULD REVIEW THE EROSION AND SEDIMENT CONTROLS WITH RESPECT TO THE FOLLOWING:
- A. WHETHER OR NOT THE MEASURE WAS INSTALLED/PERFORMED CORRECTLY. B. WHETHER OR NOT THERE HAS BEEN DAMAGE TO THE MEASURE SINCE IT INSTALLED OR PERFORMED.


C. WHAT SHOULD BE DONE TO CORRECT ANY PROBLEMS WITH THE MEASURE.

- 5. THE INSPECTOR SHALL COMPLETE THE INSPECTION SCHEDULE AND EVALUATION CHECKLIST FOR FINDINGS AND SHOULD REQUEST THE REQUIRED MAINTENANCE OR REPAIR. THE CHECKLIST IS PROVIDED WITHIN THE OPERATION AND
- 6. THE TEMPORARY BASINS SHALL BE INSPECTED AND CLEANED IF REQUIRED PRIOR TO ANY PREDICTED LARGE STORM EVENT.

MAINTENANCE PLAN.

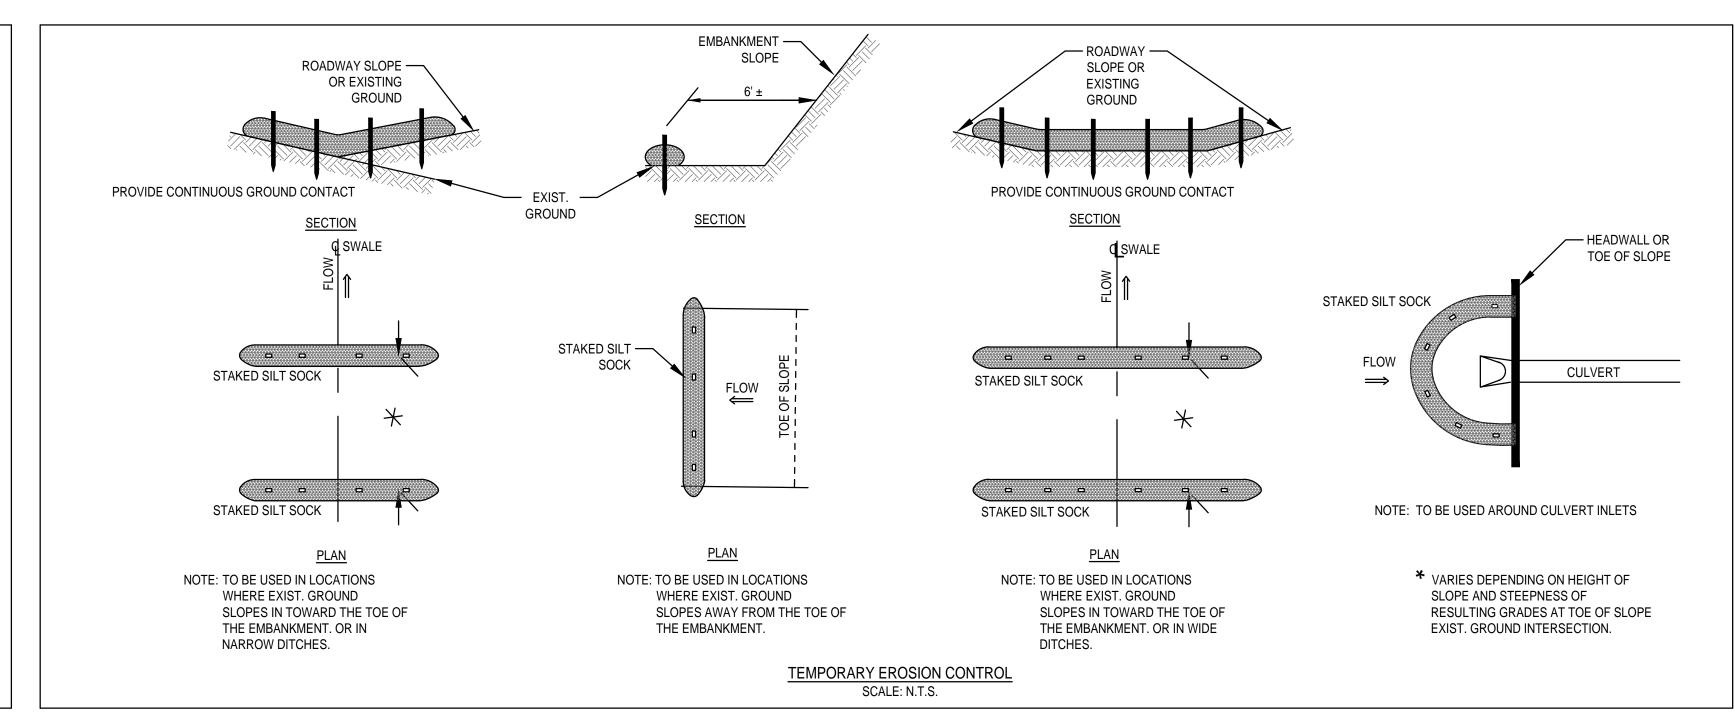

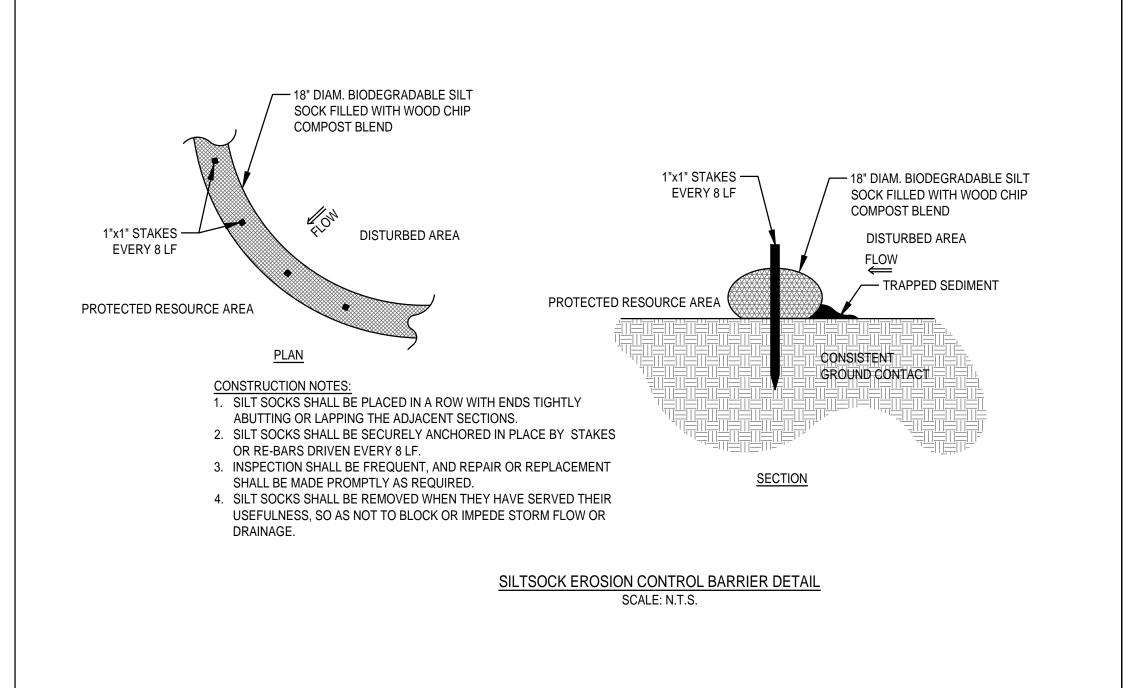

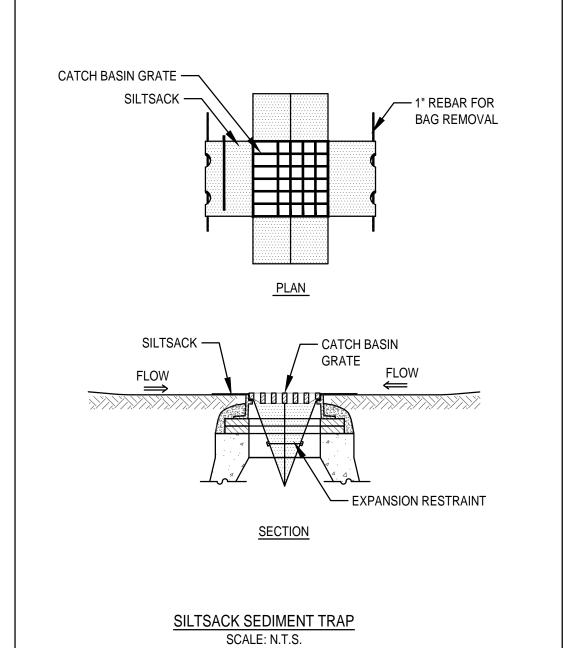

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CONSULTANTS

781.792.3900

MCKENZIE ENGINEERING GROUP 150 LONGWATER DRIVE, SUITE 101 NORWELL, MA 02061

LANDSCAPE MDLA 840 SUMMER STREET

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PROJECT #: 22034 SCALE: AS NOTED DRAWING TITLE EROSION

CONTROL PLAN




CMK DEVELOPMENT PARTNERS

MCKENZIE ENGINEERING GROUP

DRAWING TITLE
ARCHITECTURAL

A010

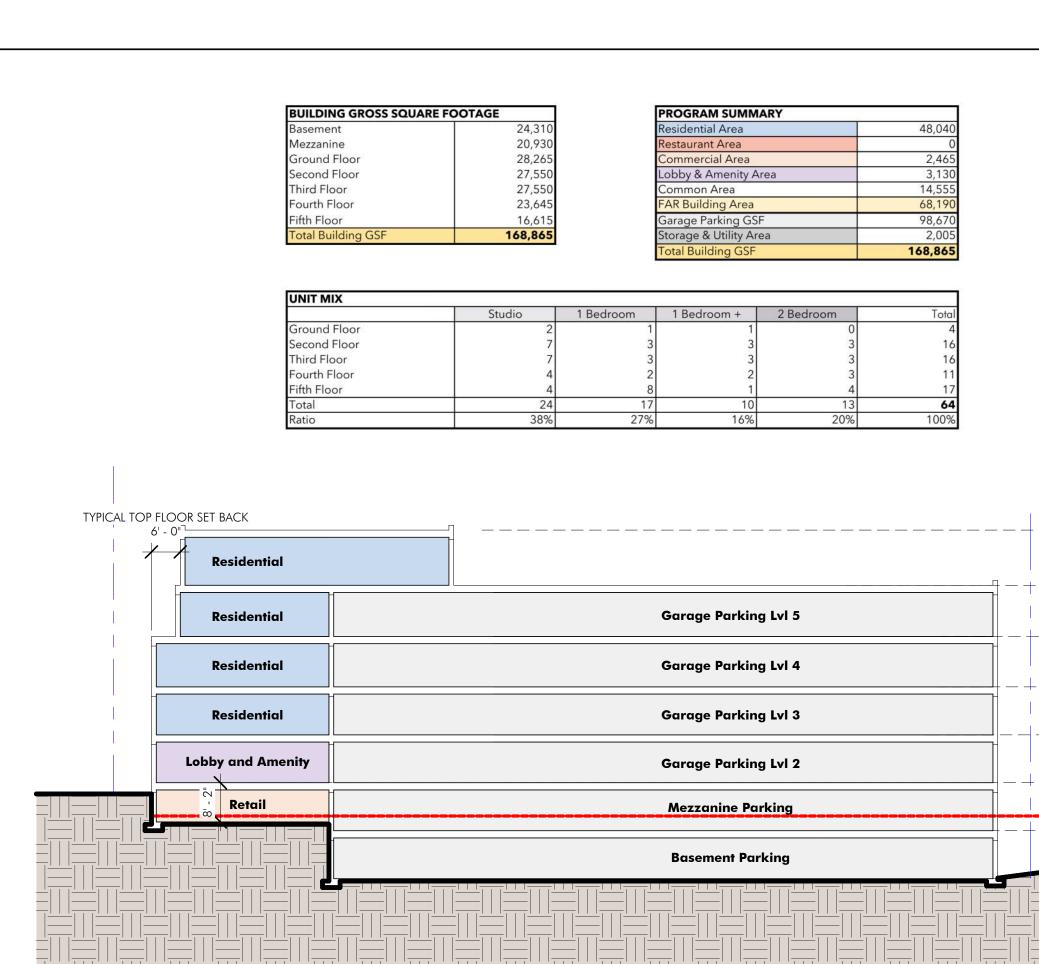



GARAGE ROOF 79'-10"

GARAGE PARKING LEVEL 5
69'-2"

GARAGE PARKING LEVEL 4
58'-8"


GARAGE PARKING LEVEL 3
48'-8"


GARAGE PARKING LEVEL 2
38'-8"

MEZZANINE LEVEL PARKING
28'-8"

BASEMENT PARKING
18'-8"

AVG GRADE 31'-9.12"

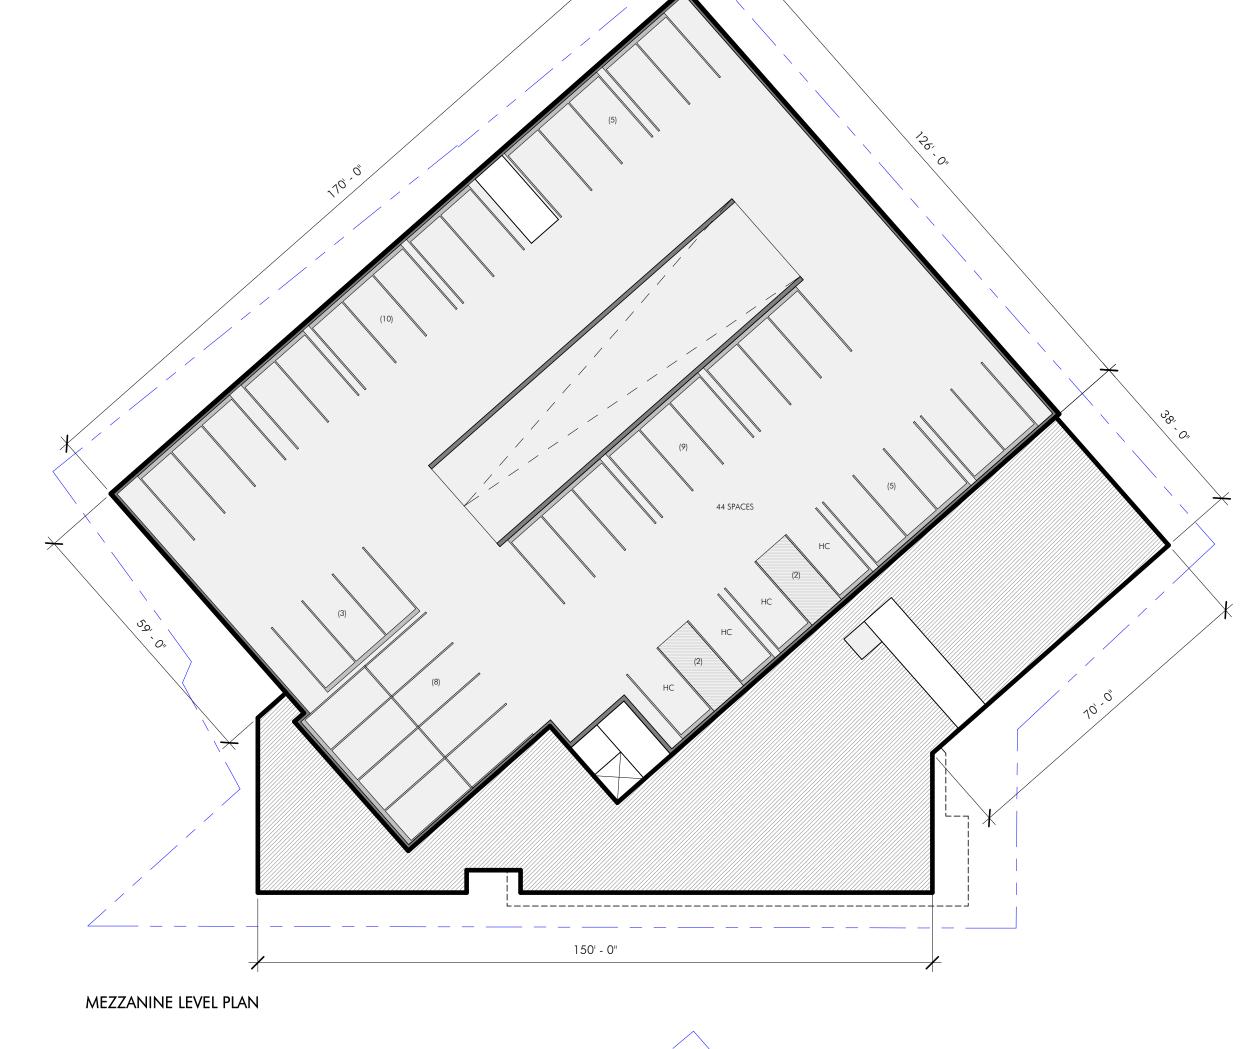

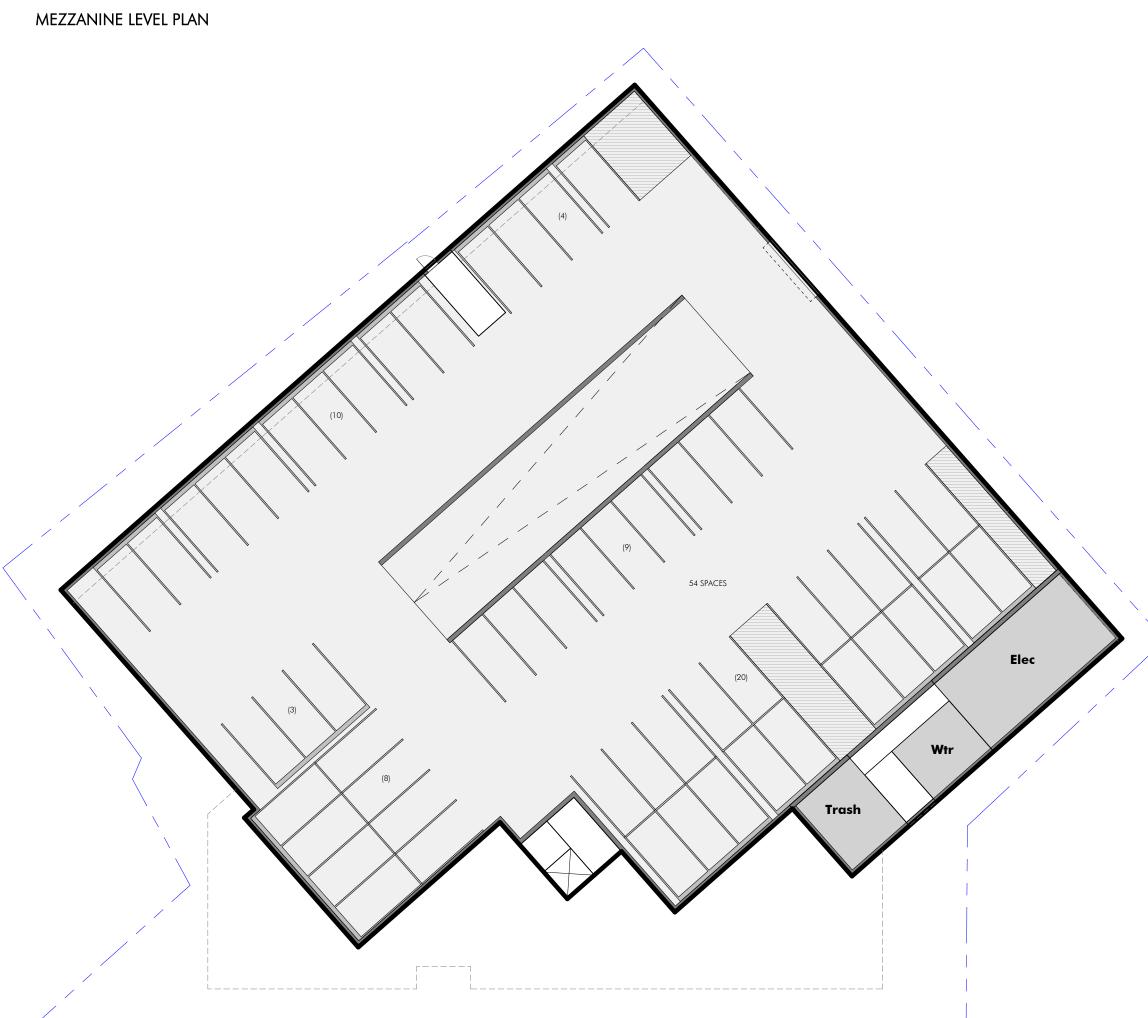

BASEMENT LEVEL PLAN

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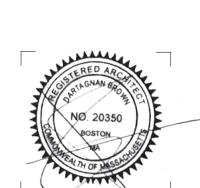
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DRAWING TITLE BUILDING A FLOOR PLANS



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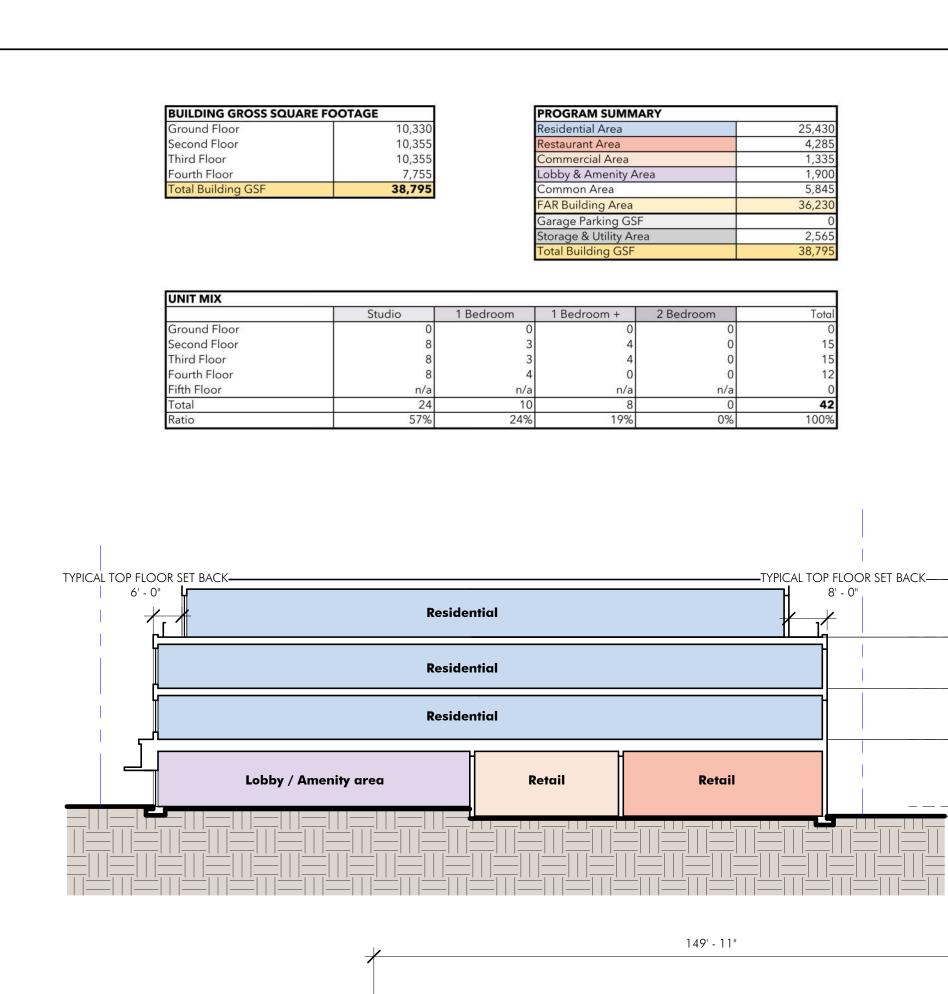
DRAWING INFORMATION

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AUGUST 4, 2023


3/64" = 1'-0"

DRAWING TITLE BUILDING A FLOOR PLANS



ROOF PLAN

FOURTH FLOOR PLAN

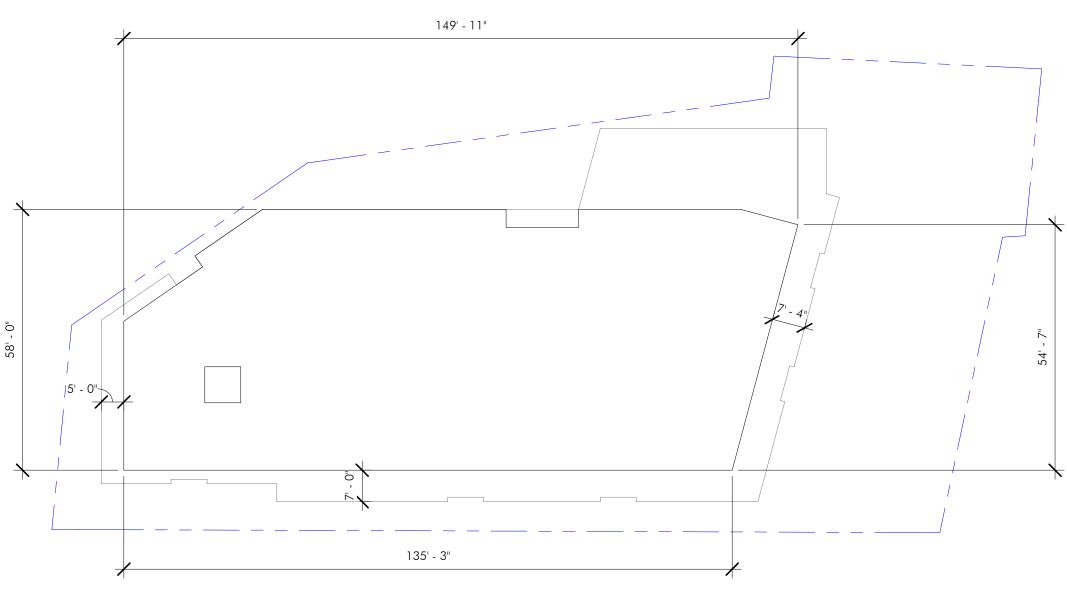



FOURTH FLOOR 35'-6"

THIRD FLOOR


SECOND FLOOR

AVERAGE GRADE 25.45

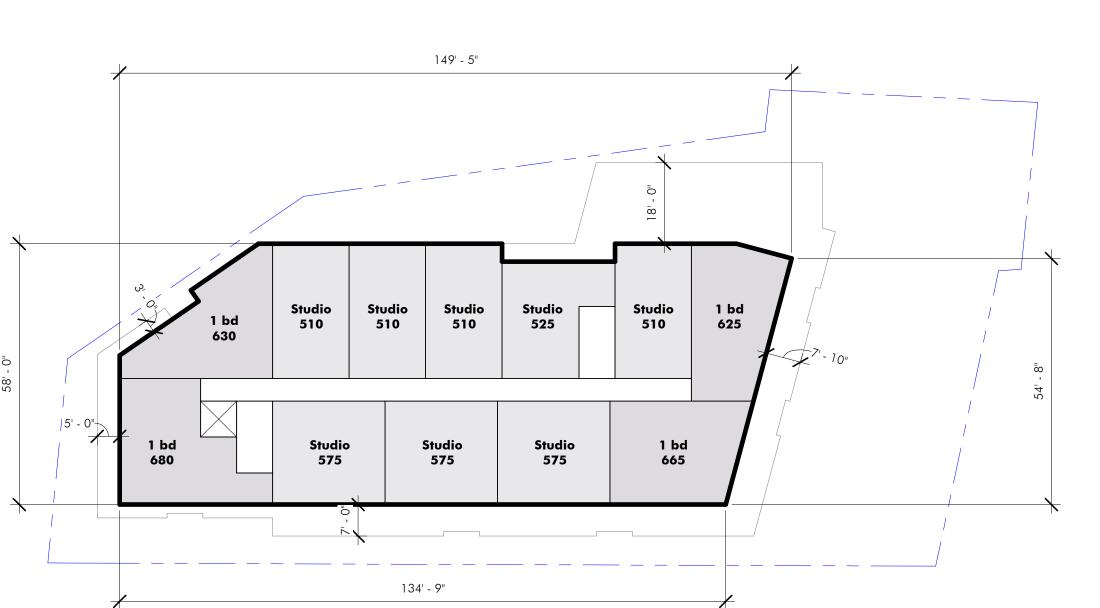

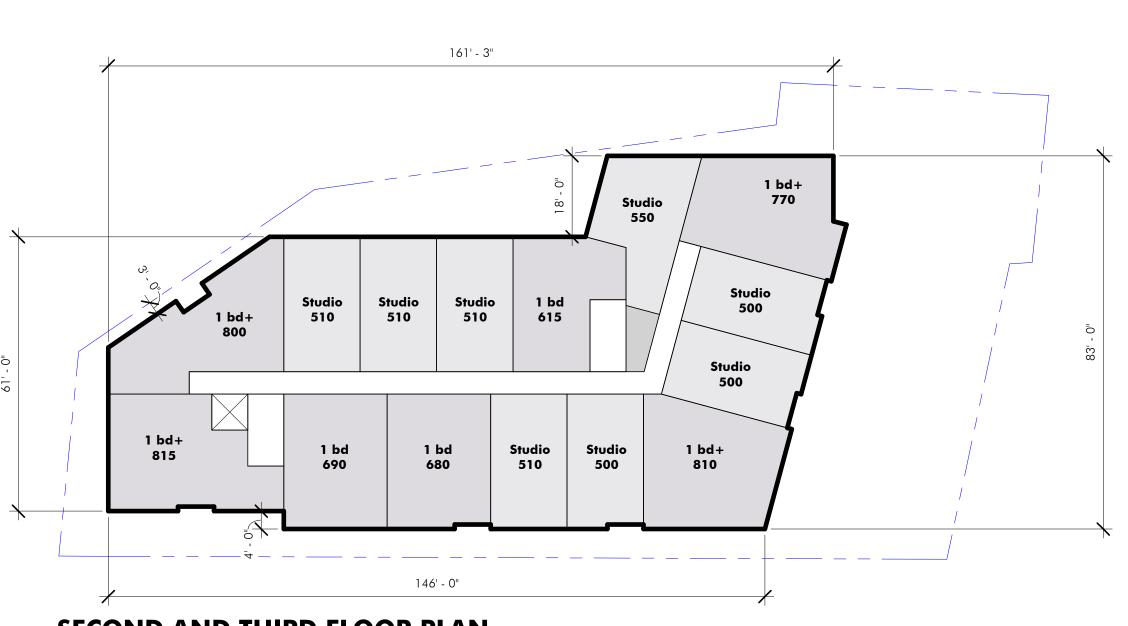



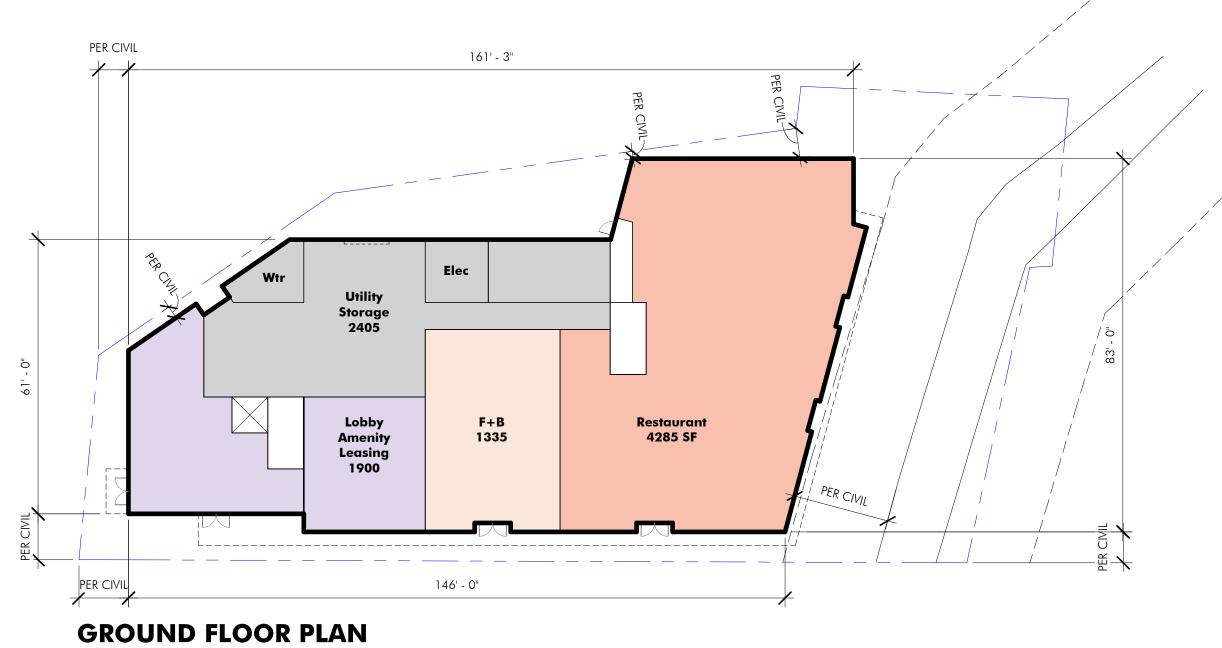

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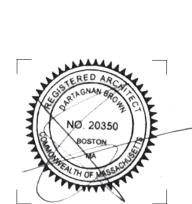
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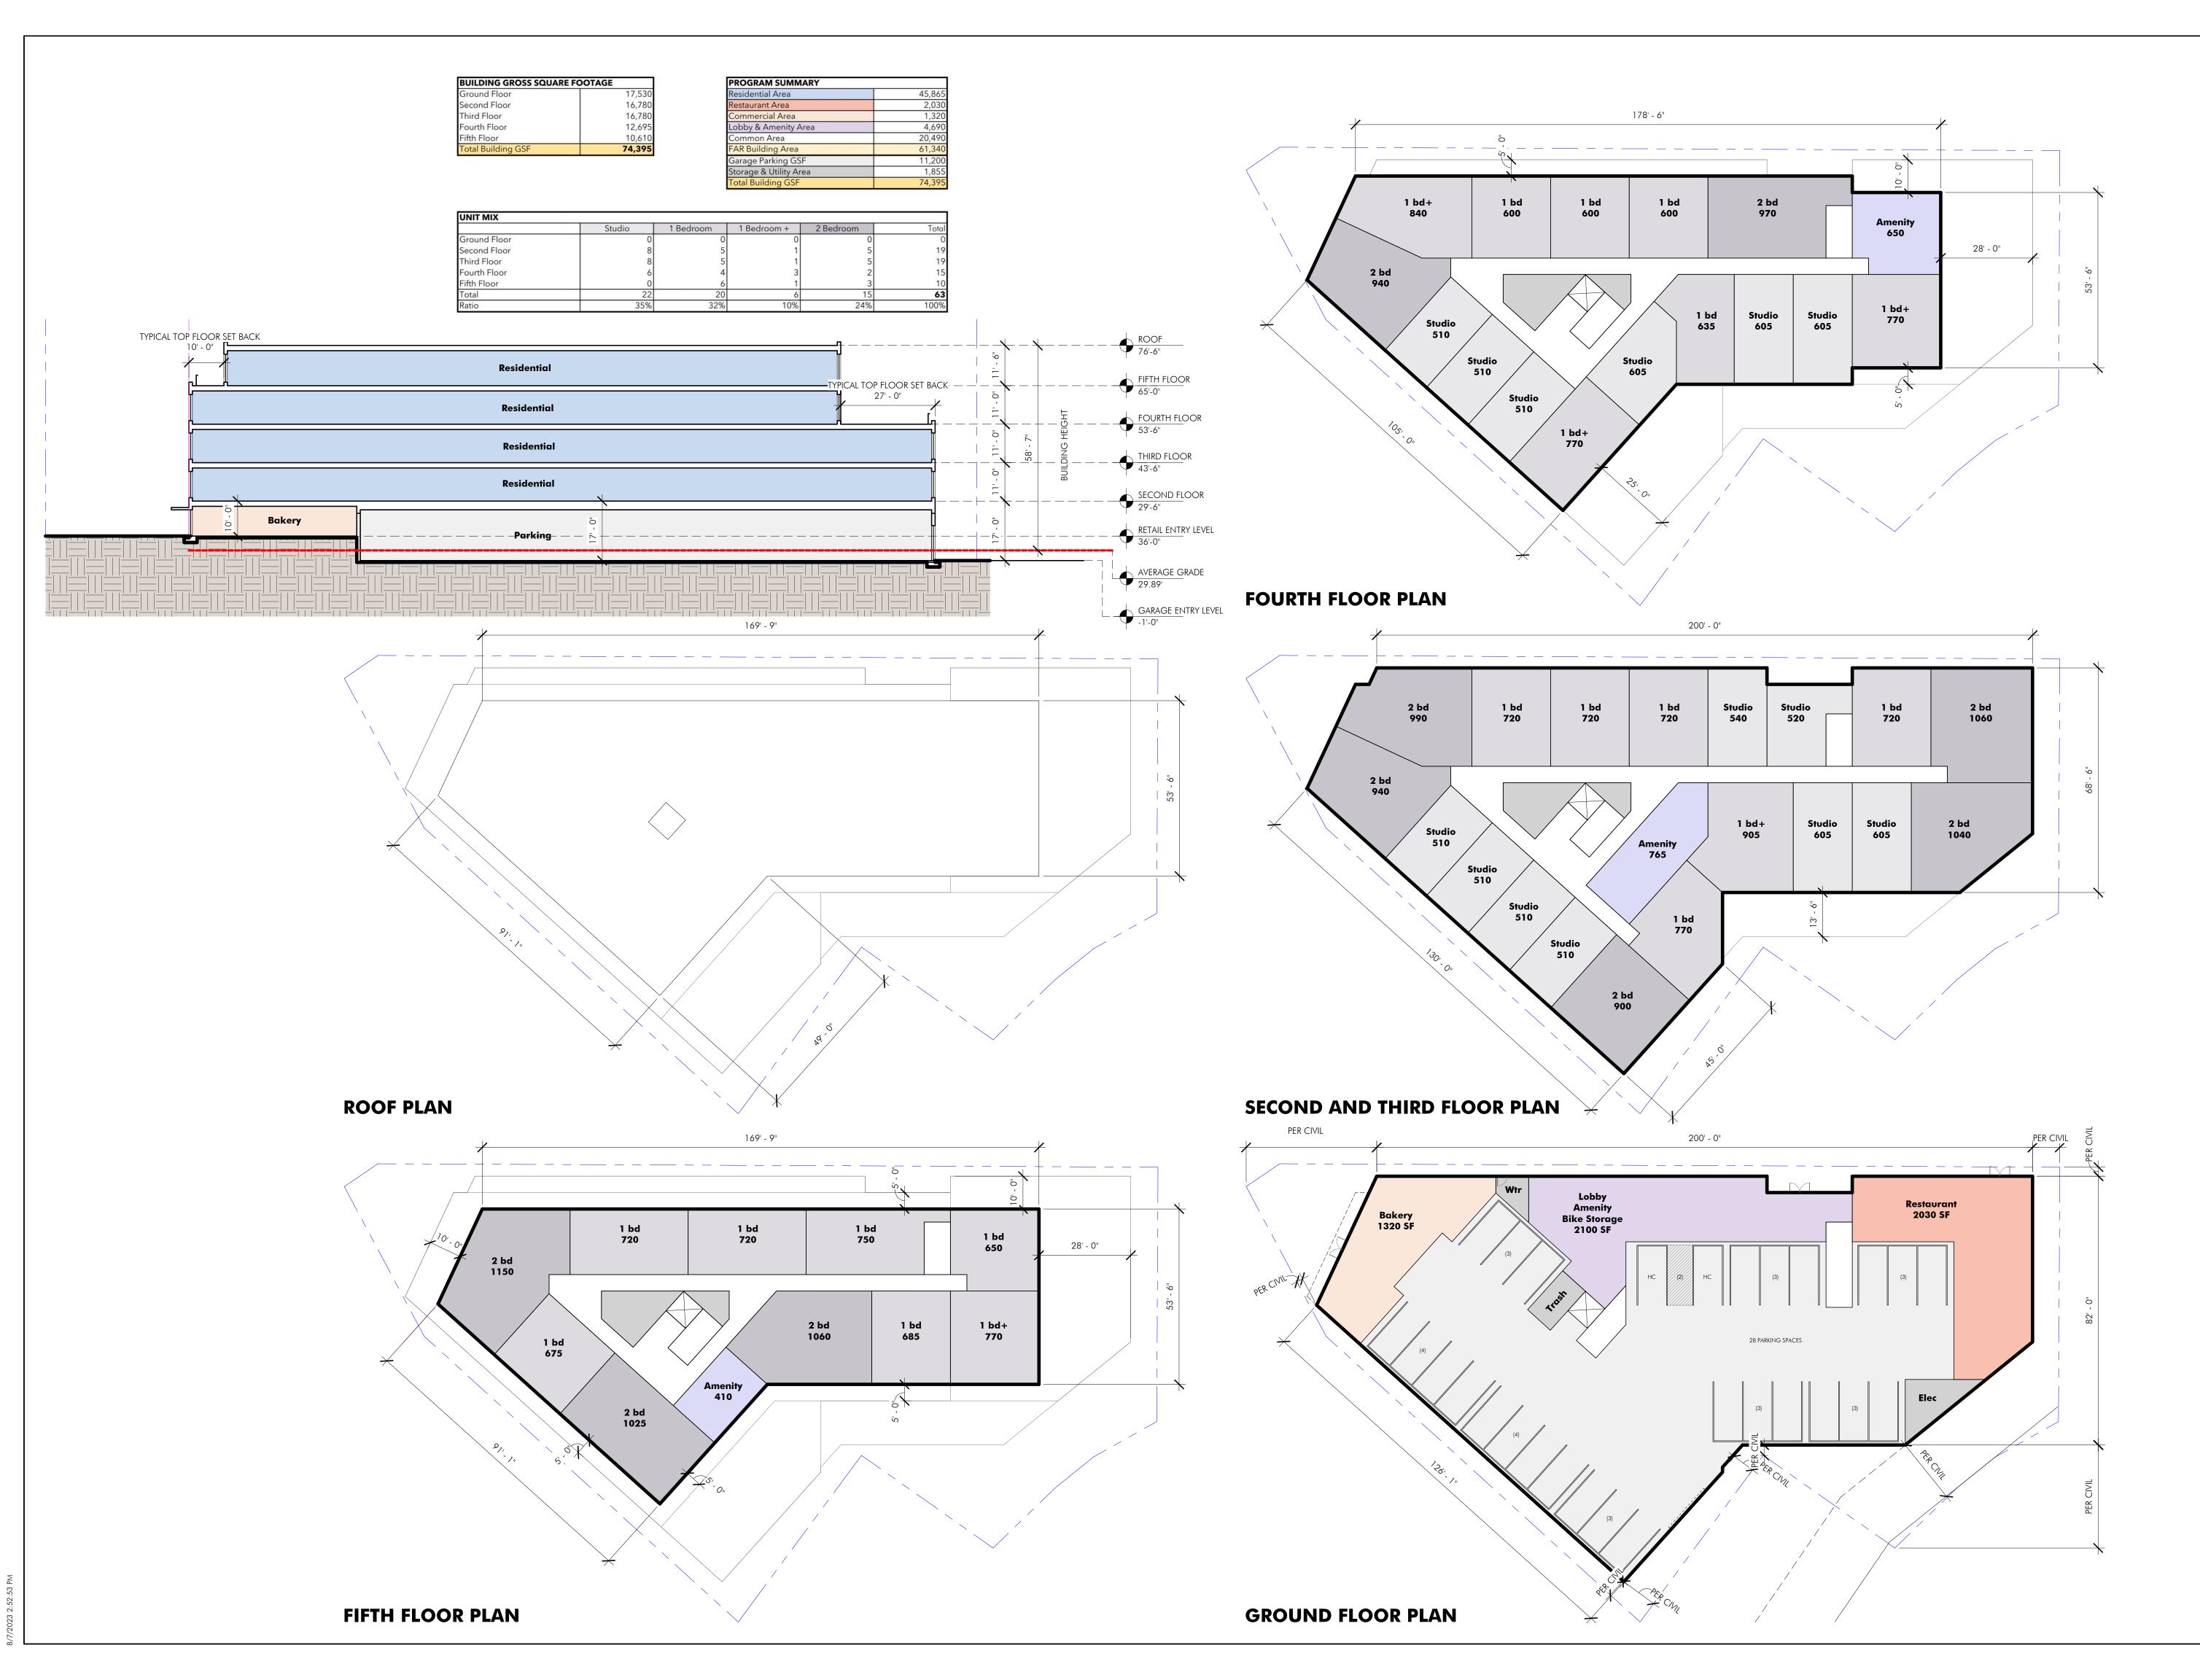
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DRAWING TITLE BUILDING B FLOOR PLANS



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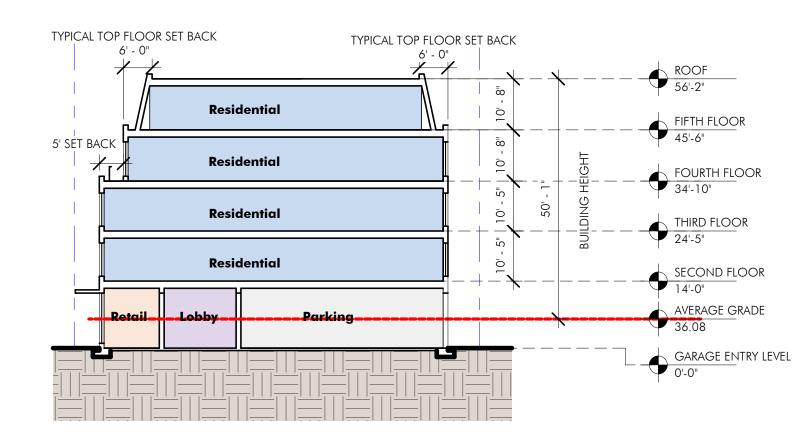
DRAWING INFORMATION


DRAWING TITLE BUILDING C FLOOR PLANS

BUILDING GROSS SQUARE FOOTAGE					
Ground Floor	6,915				
Second Floor	7,045				
Third Floor	7,045				
Fourth Floor	5,330				
Fifth Floor	4,695				
Total Building GSF	31,030				


PROGRAM SUMMARY Residential Area	21,015
	21,013
Restaurant Area	0
Commercial Area	490
Lobby & Amenity Area	260
Common Area	9,265
FAR Building Area	25,270
Garage Parking GSF	5,170
Storage & Utility Area	590
Total Building GSF	31,030

	Studio	1 Bedroom	1 Bedroom +	2 Bedroom	Tota
Ground Floor	0	0	0	0	C
Second Floor	4	2	2	1	9
Third Floor	4	2	2	1	9
Fourth Floor	4	2	0	1	7
Fifth Floor	1	5	0	0	6
Total	13	11	4	3	31
Ratio	42%	35%	13%	10%	100%




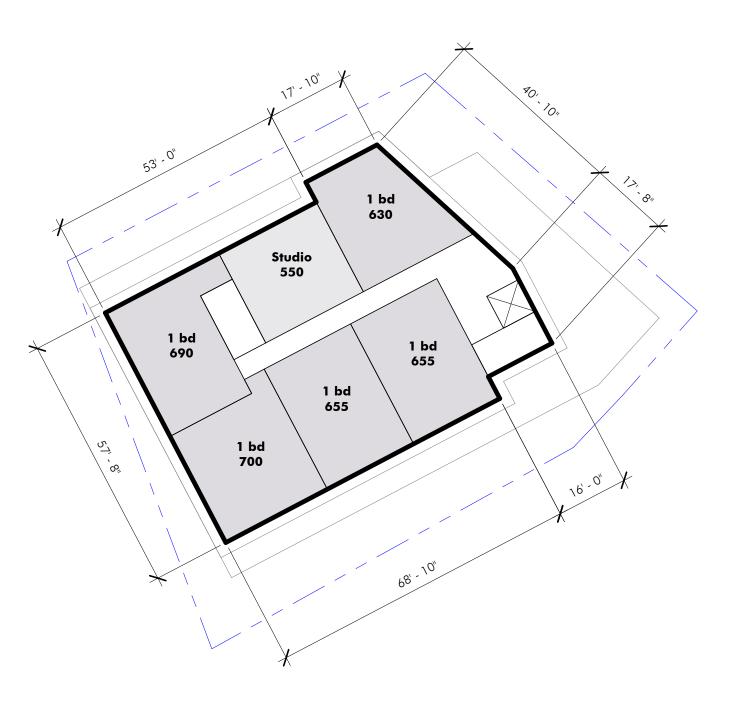


FIFTH FLOOR PLAN

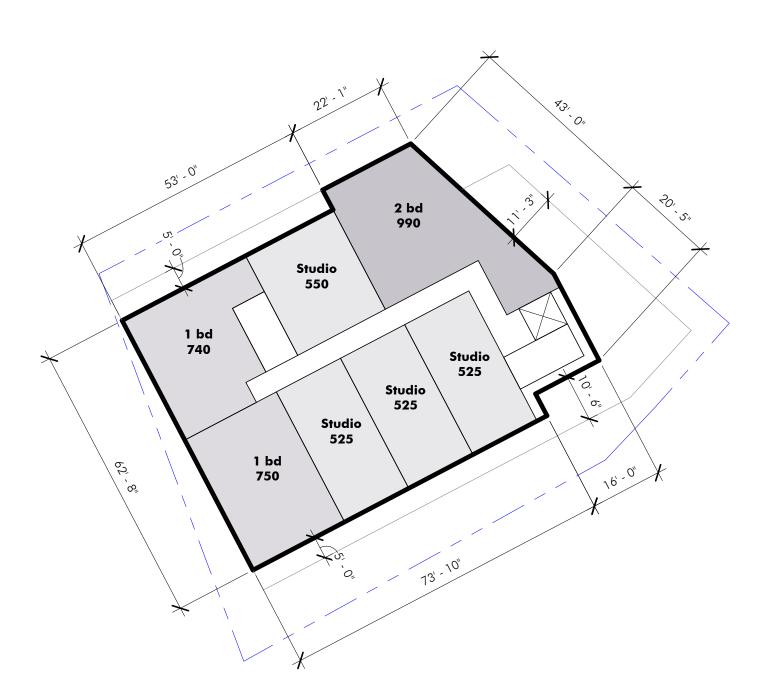

FOURTH FLOOR PLAN

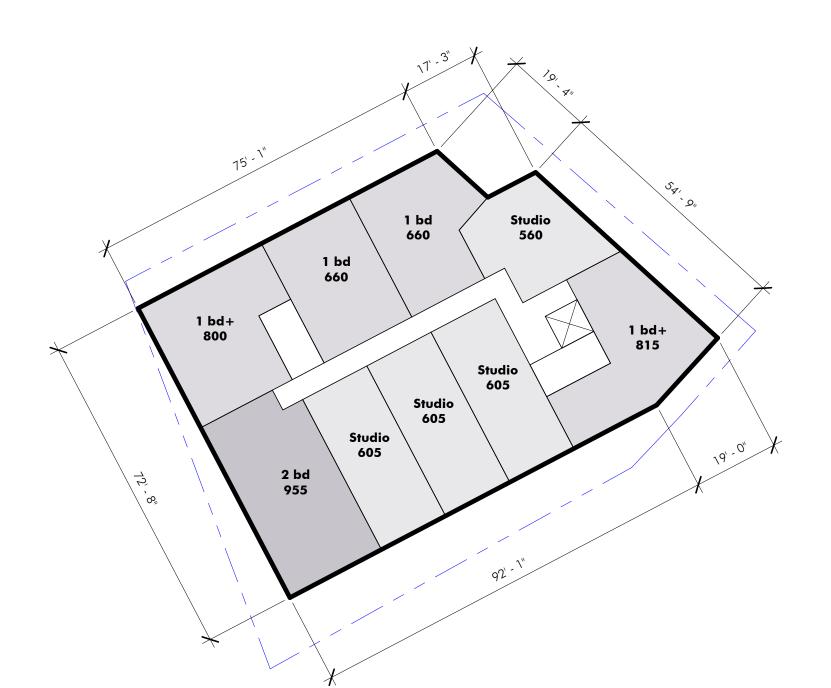

SECOND AND THIRD FLOOR PLAN

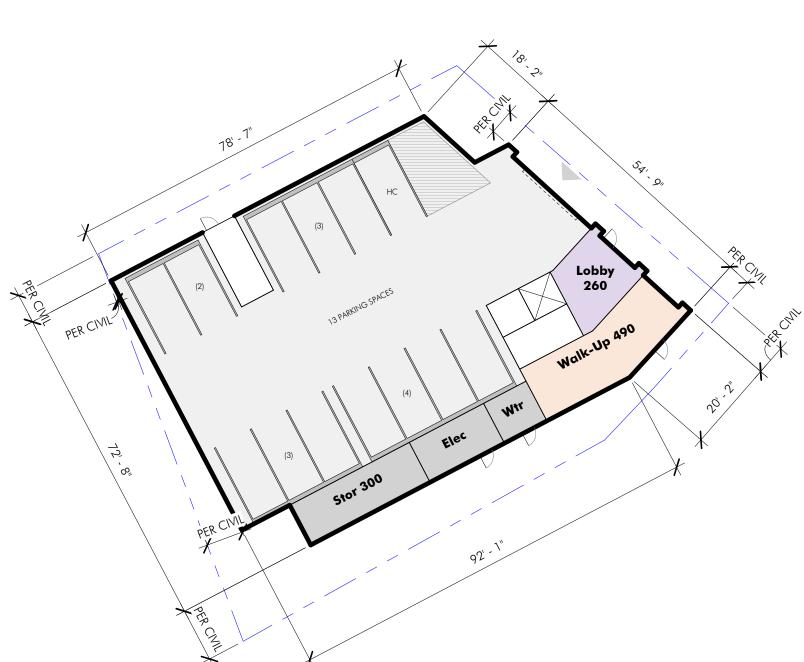

GROUND FLOOR PLAN

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AUGUST 4, 2023

1/16" = 1'-0"

DRAWING TITLE BUILDING A ELEVATIONS









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DRAWING INFORMATION AUGUST 4, 2023

1/16" = 1'-0"

DRAWING TITLE BUILDING B ELEVATIONS









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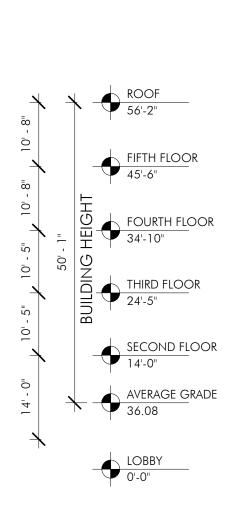
1/16" = 1'-0"

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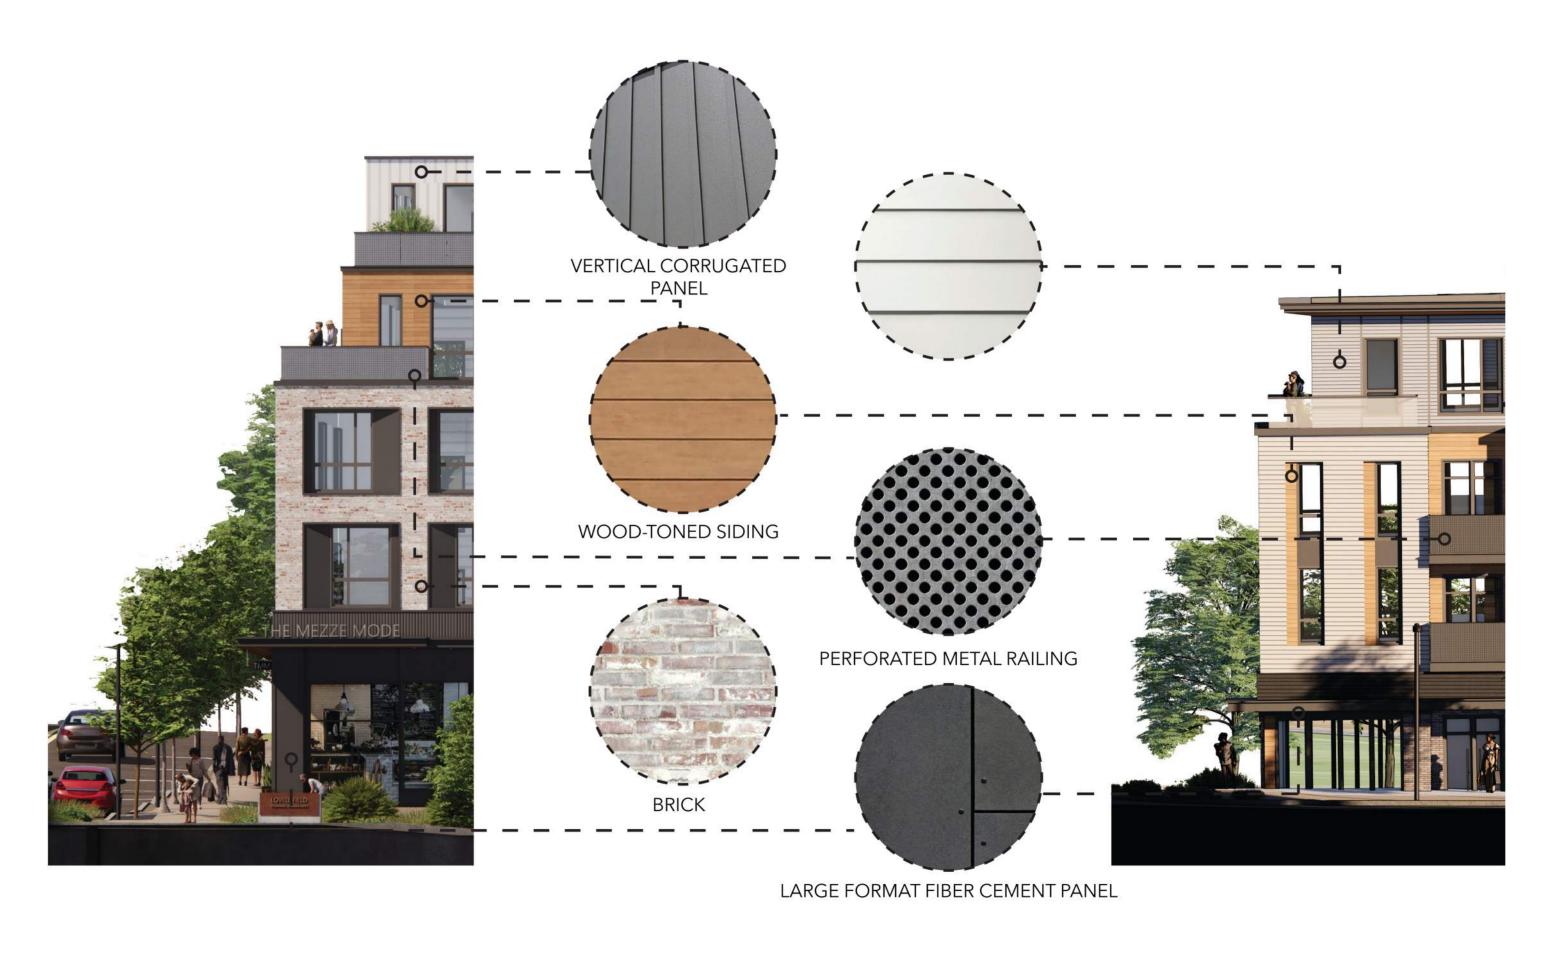


DRAWING INFORMATION

AUGUST 4, 2023

1/16" = 1'-0"

DRAWING TITLE BUILDING D ELEVATIONS



BUILDING A AND BUILDING B EXTERIOR MATERIALS



BUILDING CAND BUILDING DEXTERIOR MATERIALS

| ARCHITECT 580 HARRISON AVE, SUITE 2W BOSTON, MA 02118 O: 617.765.8000 www.embarcdesign.com

OWNER

CMK DEVELOPMENT PARTNERS 97 LIBBEY PARKWAY SUITE 304 WEYMOUTH, MA 02189

CONSULTANTS

MCKENZIE ENGINEERING GROUP 150 LONGWATER DRIVE, SUITE 101 NORWELL, MA 02061 781.792.3900

LANDSCAPEMDLA

840 SUMMER STREET SUITE #201A BOSTON, MA 02127

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SUITE 304
WEYMOUTH, MA 02189

CONSULTANTS

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MCKENZIE ENGINEERING GROUP
150 LONGWATER DRIVE, SUITE 101
NORWELL, MA 02061
781.792.3900

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840 SUMMER STREET
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BOSTON, MA 02127

CKSON SQUARE

REVIEW

L

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DRAWING INFORMATION

ISSUE: SITE PLAN REVIEW

ISSUE: SITE PLAN REVIEW

DATE: AUGUST 4, 2023

PROJECT #: 22034

SCALE: 1/8" = 1'-0"

BROAD STREET
SECTION

DRAWING NUMBER


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CONSULTANTS

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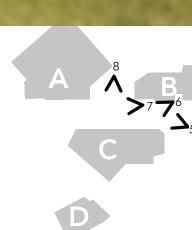
DRAWING TITLE
PERSPECTIVE







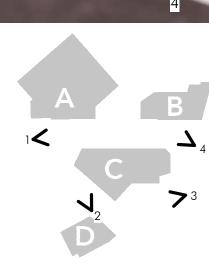



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REVISIONS



DRAWING TITLE LANDSCAPE KEY PLAN

DRAWING NUMBER

TOWN STANDARDS

FLUSH GRANITE CURB BORDER

SYM.	QTY.	LATIN NAME	COMMON NAME	SIZE	NOTES
TREE:	S			•	•
				<u> </u>	
4F	17	ACER X FREEMANII 'ARMSTRONG'	ARMSTRONG RED MAPLE	2.5"-3" CAL.	B&B, 6' CLEAR BRANCHING
4R	5	ACER RUBRUM 'RED SUNSET'	RED SUNSET MAPLE	2.5"-3" CAL.	B&B, 6' CLEAR BRANCHING
٩S	16	AMELANCHIER 'AUTUMN BRILLIANCE'	SERVICEBERRY	6-7' TALL	B&B, MULTI-STEM
3N	2	BETULA NIGRA 'HERITAGE'	HERITAGE RIVER BIRCH	8-10' TALL	B&B, MULTI-STEM
СВ	7	CARPINUS BETULUS 'FRANS FONTAINE'	FRANS FONTAINE HORNBEAM	6-7' TALL	B&B, MATCHED
CC	7	CERCIS CANADENSIS	EASTERN REDBUD	6-7' TALL	B&B, SINGLE AND MULTI-STE
ЭT	6	GLEDITSEA TRICANTHOS 'SKYLINE'	SKYLINE HONEYLOCUST	2.5"-3" CAL.	B&B, 6' CLEAR BRANCHING
V	2	JUNIPERUS VIRGINIANA	EASTERN RED CEDAR	8'-10' TALL	B&B, MATCHED
T	2	LIRIODENDRON TULIPIFERA	TULIP TREE	2.5"-3" CAL.	B&B, 6' CLEAR BRANCHING
NS	2	NYSSA SYLVATICA	BLACK GUM	2.5"-3" CAL.	B&B, 6' CLEAR BRANCHING
PS	7	PINUS STROBUS	EASTERN WHITE PINE	8'-10' TALL	B&B, MATCHED
QΒ	3	QUERCUS BICOLOR	SWAMP WHITE OAK	2.5"-3" CAL.	B&B, 6' CLEAR BRANCHING
<u> </u>	1	QUERCUS PALUSTRIS 'PRINGREEN'	GREEN PILLAR OAK	2.5"-3" CAL.	B&B, 6' CLEAR BRANCHING
QR	3	QUERCUS RUBRA	RED OAK	2.5"-3" CAL.	B&B, MATCHED
Ā	4	SWIDA ALTERNIFOLIA	PAGODA DOGWOOD	8'-10' TALL	B&B, MATCHED
0	42	THUJA OCCIDENTALIS 'EMERALD GREEN'	EMERALD GREEN ARBORVITA		B&B, MATCHED
ГР	3	THUJA OCCIDENTALIS 'GREEN GIANT'	GREEN GIANT ARBORVITAE	8'-10' TALL	B&B, MATCHED
	J	ITTOJA OCCIDENTALIS GREEN GIANT	GREEN GIANT ARBORVITAE	O TO TALL	B&B, WATCHEB
HRI	IBS PAL	FTTF			
AM	11	ARONIA MELANOCARPA	BLACK CHOKEBERRY	3 GALLON	36" O.C. B&B
CA	32	CLETHERA ALNIFOLIA	SUMMERSWEET	3 GALLON	36" O.C. B&B
20	22	COMPTONIA PEREGRINA	SWEET FERN	3 GALLON	36" O.C. B&B
CS	19	CORNUS SERICEA 'ARCTIC FIRE'	ARCTIC FIRE DOGWOOD	3 GALLON	36" O.C. B&B
 G	100	ILEX GLABRA	INKBERRY	3 GALLON	36" O.C. B&B
	-				36" O.C. B&B
V	56	ILEX VERTICILLATA	WINTERBERRY	3 GALLON	
MP	49	MYRICA PENSYLVANICA	NORTHERN BAYBERRY	3 GALLON	36" O.C. B&B
RA	61	RHUS AROMATICA 'GRO LOW'	GRO LOW SUMAC	3 GALLON	36" O.C. B&B
D	45	TAXUS X MEDIA 'DENSIFORMIS'	DENSIFORMIS YEW	3 GALLON	36" O.C. B&B
ГМ	33	TAXUS X MEDIA 'HICKSII'	HICKS YEW	3 GALLON	36" O.C. B&B
/A	20	VIBURNUM ACERIFOLIUM	MAPLE LEAF VIBURNUM	3 GALLON	36" O.C. B&B
/C	12	VACCINIUM CORYMBOSUM	HIGH BUSH BLUEBERRY	3 GALLON	36" O.C. B&B
/D	6	VIBURNUM DENTATUM	NORTHERN ARROWWOOD	3 GALLON	36" O.C. B&B
		•			
PERE	NNIALS	AND GRASSES PALETTE			
AC	92	ASTILBE CHINESIS 'VISION IN WHITE'	VISION IN WHITE ASTILBE	1 GAL	18" O.C. CONTAINER
CP.	354	CAREX PENSYLVANICA	PENNSYLVANIA SEDGE	1 GAL	18" O.C. CONTAINER
)P	178	DENNSTAEDTIA PUNCTILOBULA	HAYCENTED FERN	1 GAL	18" O.C. CONTAINER
P	117	ECHINACEA PURPUREA	PURPLE CONEFLOWER	1 GAL	18" O.C. CONTAINER
١W	9	NEPETA X FAASSENII 'WALKERS LOW'	CATMINT	1 GAL	18" O.C. CONTAINER
Ή	237	PENNISETUM ALOPECUROIDES 'HAMELN'	DWARF FOUNTAIN GRASS	2 GAL	24" O.C. CONTAINER
PL	25	PEROVSKIA A. 'LITTLE SPIRE'	LITTLE SPIRE RUSSIAN SAGE	1 GAL	18" O.C. CONTAINER
V	146	PANICUM VIRGATUM 'SHENANDOAH'	SWITCH GRASS	2 GAL	30" O.C. CONTAINER
RF	138	RUDBECKIA FULGIDA 'GOLDSTURM'	BLACK EYE SUSAN	1 GAL	18" O.C. CONTAINER
SN	190	SYMPHYOTRICHUM NOVAE-ANGLIAE	NEW ENGLAND ASTER	1 GAL	18" O.C. CONTAINER
/1 N	1130	STIVIT HTO INICHOIVI NOVAE-ANGLIAE	INL W ENGLAND ASTER	I I GAL	110 U.C. CONTAINER

800-873-3321 (ERNMX-132-1)

FINAL SELECTION OF PLANTINGS WILL BE MADE FROM THE SPECIES LISTED IN EACH CATEGORY OF PLANT TYPE ABOVE 2. PLANT TYPES NOTED WITH "*" ARE INCLUDED IN THE 20' WIDE LANDSCAPE BUFFER ALONG HERRING RUN BROOK, SEE PLANS FOR QUANTITIES.

SPRING: OAT

LIGHT SCI	HEDULE					
SYMBOL	LABEL	MODEL	MOUNT	DESCRIPTION	OPTIONS	REP
	EX	COOPER LIGHTING - FIXTURE: ANE-10S-X-4-33-2 POLE/BASE: DEA714PU	CONCRETE FOOTING; KEEP 3" ABOVE GRADE	SINGLE	COLOR: BLK	ILLUMINATE 617-947-8996 STEVE PRUDHOMME
	SW1	MP LIGHTING - RECESSED WALL LIGHT L368-8W30HNC-S6	WALL LIGHT	SINGLE	COLOR: S.S.	
	W1	BEGA LED WALL LUMINAIRES 24219-K3-BLK	BUILDING MOUNT	SINGLE	COLOR: BLK	
-	W2	BEGA LED WALL LUMINAIRES 24243-K3-BLK	BUILDING MOUNT	SINGLE	COLOR: BLK	

1. SUBMIT CUT SHEETS FOR APPROVAL; SEE PHOTOMETRIC PLAN PROVIDED WITH THIS DRAWING SET FOR MORE INFORMATION. 2. STREETSCAPE LIGHTING (FIXTURE "EX") TO BE COORDINATED WITH TOWN ENGINEER

ARCHITECT 580 HARRISON AVE, SUITE 2W BOSTON, MA 02118

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OWNER

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CONSULTANTS

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LANDSCAPE

MDLA 840 SUMMER STREET

SUITE #201A BOSTON, MA 02127

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DRAWING TITLE LANDSCAPE PLANTING AND LIGHTING PLAN



LANDSCAPE PLANTING AND LIGHTING ENLARGEMENT

GRANITE CURBING, SEE CIVIL —

S C A L E I N F E

NOT FOR CONSTRUCTION

I/BROAD STREET

SYM.	QTY.	LATIN NAME	COMMON NAME	SIZE	NOTES
TREES	S	•	•	•	•
AF	17	ACER X FREEMANII 'ARMSTRONG'	ARMSTRONG RED MAPLE	2.5"-3" CAL.	B&B, 6' CLEAR BRANCH
AR	5	ACER RUBRUM 'RED SUNSET'	RED SUNSET MAPLE	2.5"-3" CAL.	B&B, 6' CLEAR BRANCH
AS	16	AMELANCHIER 'AUTUMN BRILLIANCE'	SERVICEBERRY	6-7' TALL	B&B, MULTI-STEM
BN	2	BETULA NIGRA 'HERITAGE'	HERITAGE RIVER BIRCH	8-10' TALL	B&B, MULTI-STEM
СВ	7	CARPINUS BETULUS 'FRANS FONTAINE'	FRANS FONTAINE HORNBEAL		B&B, MATCHED
CC	7	CERCIS CANADENSIS	EASTERN REDBUD	6-7' TALL	B&B, SINGLE AND MUL
GT	6	GLEDITSEA TRICANTHOS 'SKYLINE'	SKYLINE HONEYLOCUST	2.5"-3" CAL.	B&B, 6' CLEAR BRANCH
JV	2	JUNIPERUS VIRGINIANA	EASTERN RED CEDAR	8'-10' TALL	B&B, MATCHED
LT	2	LIRIODENDRON TULIPIFERA	TULIP TREE	2.5"-3" CAL.	B&B, 6' CLEAR BRANCH
NS	2	NYSSA SYLVATICA	BLACK GUM	2.5"-3" CAL.	B&B, 6' CLEAR BRANCH
PS	7	PINUS STROBUS	EASTERN WHITE PINE	8'-10' TALL	B&B, MATCHED
QB	3	QUERCUS BICOLOR	SWAMP WHITE OAK	2.5"-3" CAL.	B&B, 6' CLEAR BRANCH
QP	1	QUERCUS PALUSTRIS 'PRINGREEN'	GREEN PILLAR OAK	2.5"-3" CAL.	B&B, 6' CLEAR BRANCH
QR	3	QUERCUS RUBRA	RED OAK	2.5"-3" CAL.	B&B, MATCHED
SA	4	SWIDA ALTERNIFOLIA	PAGODA DOGWOOD	8'-10' TALL	B&B, MATCHED
TO	42	THUJA OCCIDENTALIS 'EMERALD GREEN'	EMERALD GREEN ARBORVITA	AE 8'-10' TALL	B&B, MATCHED
TP	3	THUJA OCCIDENTALIS 'GREEN GIANT'	GREEN GIANT ARBORVITAE	8'-10' TALL	B&B, MATCHED
	•		•	•	•
SHRU	BS PAL	ETTE			
AM	11	ARONIA MELANOCARPA	BLACK CHOKEBERRY	3 GALLON	36" O.C. B&B
CA	32	CLETHERA ALNIFOLIA	SUMMERSWEET	3 GALLON	36" O.C. B&B
CO	22	COMPTONIA PEREGRINA	SWEET FERN	3 GALLON	36" O.C. B&B
CS	19	CORNUS SERICEA 'ARCTIC FIRE'	ARCTIC FIRE DOGWOOD	3 GALLON	36" O.C. B&B
IG	100	ILEX GLABRA	INKBERRY	3 GALLON	36" O.C. B&B
IV	56	ILEX VERTICILLATA	WINTERBERRY	3 GALLON	36" O.C. B&B
MP	49	MYRICA PENSYLVANICA	NORTHERN BAYBERRY	3 GALLON	36" O.C. B&B
RA	61	RHUS AROMATICA 'GRO LOW'	GRO LOW SUMAC	3 GALLON	36" O.C. B&B
TD	45	TAXUS X MEDIA 'DENSIFORMIS'	DENSIFORMIS YEW	3 GALLON	36" O.C. B&B
TM	33	TAXUS X MEDIA 'HICKSII'	HICKS YEW	3 GALLON	36" O.C. B&B
VA	20	VIBURNUM ACERIFOLIUM	MAPLE LEAF VIBURNUM	3 GALLON	36" O.C. B&B
VC	12	VACCINIUM CORYMBOSUM	HIGH BUSH BLUEBERRY	3 GALLON	36" O.C. B&B
VD	6	VIBURNUM DENTATUM	NORTHERN ARROWWOOD	3 GALLON	36" O.C. B&B
,,,	Ŭ	1120111011110111		13 6/122611	100 0.0.000
PEREI	VNIALS	AND GRASSES PALETTE			
AC	92	ASTILBE CHINESIS 'VISION IN WHITE'	VISION IN WHITE ASTILBE	1 GAL	18" O.C. CONTAINER
CP	354	CAREX PENSYLVANICA	PENNSYLVANIA SEDGE	1 GAL	18" O.C. CONTAINER
DP	178	DENNSTAEDTIA PUNCTILOBULA	HAYCENTED FERN	1 GAL	18" O.C. CONTAINER
EP.	117	ECHINACEA PURPUREA	PURPLE CONEFLOWER	1 GAL	18" O.C. CONTAINER
NW	9	NEPETA X FAASSENII 'WALKERS LOW'	CATMINT	1 GAL	18" O.C. CONTAINER
PH	237	PENNISETUM ALOPECUROIDES 'HAMELN'	DWARF FOUNTAIN GRASS	2 GAL	24" O.C. CONTAINER
PL	25	PEROVSKIA A. 'LITTLE SPIRE'	LITTLE SPIRE RUSSIAN SAGE	1 GAL	18" O.C. CONTAINER
PV	146	PANICUM VIRGATUM 'SHENANDOAH'	SWITCH GRASS	2 GAL	30" O.C. CONTAINER
RF	138	RUDBECKIA FULGIDA 'GOLDSTURM'	BLACK EYE SUSAN	1 GAL	18" O.C. CONTAINER
SN	190	SYMPHYOTRICHUM NOVAE-ANGLIAE	NEW ENGLAND ASTER	1 GAL	18" O.C. CONTAINER
J11	100	STIVIL LITO INICITOIVI NOVAE-ANGLIAE	LINEAN FINOTAIND ASIEU	I T OAL	TO O.C. CONTAINER
SEED	MIX				
		EDALCT HALATINE MICCOSCA 407/1		APPLY COVER CROP;	
	T SEED	ns ERNST "NATIVE WOODS MIX"	30 LB/ACRE	VADDLA LUMER CRUD.	FVII. (28VIVI BAF

FINAL SELECTION OF PLANTINGS WILL BE MADE FROM THE SPECIES LISTED IN EACH CATEGORY OF PLANT TYPE ABOVE
 PLANT TYPES NOTED WITH "*" ARE INCLUDED IN THE 20' WIDE LANDSCAPE BUFFER ALONG HERRING RUN BROOK, SEE PLANS FOR

SYMBOL	LABEL	MODEL	MOUNT	DESCRIPTION	OPTIONS	REP
	EX	COOPER LIGHTING - FIXTURE: ANE-10S-X-4-33-2 POLE/BASE: DEA714PU	CONCRETE FOOTING; KEEP 3" ABOVE GRADE	SINGLE	COLOR: BLK	ILLUMINATE 617-947-8996 STEVE PRUDHOMME
	SW1	MP LIGHTING - RECESSED WALL LIGHT L368-8W30HNC-S6	WALL LIGHT	SINGLE	COLOR: S.S.	
\	W1	BEGA LED WALL LUMINAIRES 24219-K3-BLK	BUILDING MOUNT	SINGLE	COLOR: BLK	
-	W2	BEGA LED WALL LUMINAIRES 24243-K3-BLK	BUILDING MOUNT	SINGLE	COLOR: BLK	

-_S_,HEET L3

SUBMIT CUT SHEETS FOR APPROVAL; SEE PHOTOMETRIC PLAN PROVIDED WITH THIS DRAWING SET FOR MORE INFORMATION.
 STREETSCAPE LIGHTING (FIXTURE "EX") TO BE COORDINATED WITH TOWN ENGINEER

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DRAWING TITLE LANDSCAPE

PLANTING AND LIGHTING PLAN

DRAWING NUMBER

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LANDSCAPE PLANTING AND LIGHTING ENLARGEMENT

BRICK PAVER BAND TO MATCH -

2 EP —

3 RA ----

6 RF ----


TREE GRATE TO MATCH —— TOWN STANDARDS, TYP. 6' BENCH, TYP. ——

STREETSCAPE PARALLEL

TOWN STANDARDS GRANITE CURBING, SEE CIVIL PARKING LIGHT POLE TO MATCH TOWN — STANDARDS, TYP.

S C A L E I N F E E

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LANDSCAPE PLANTING AND LIGHTING ENLARGEMENT

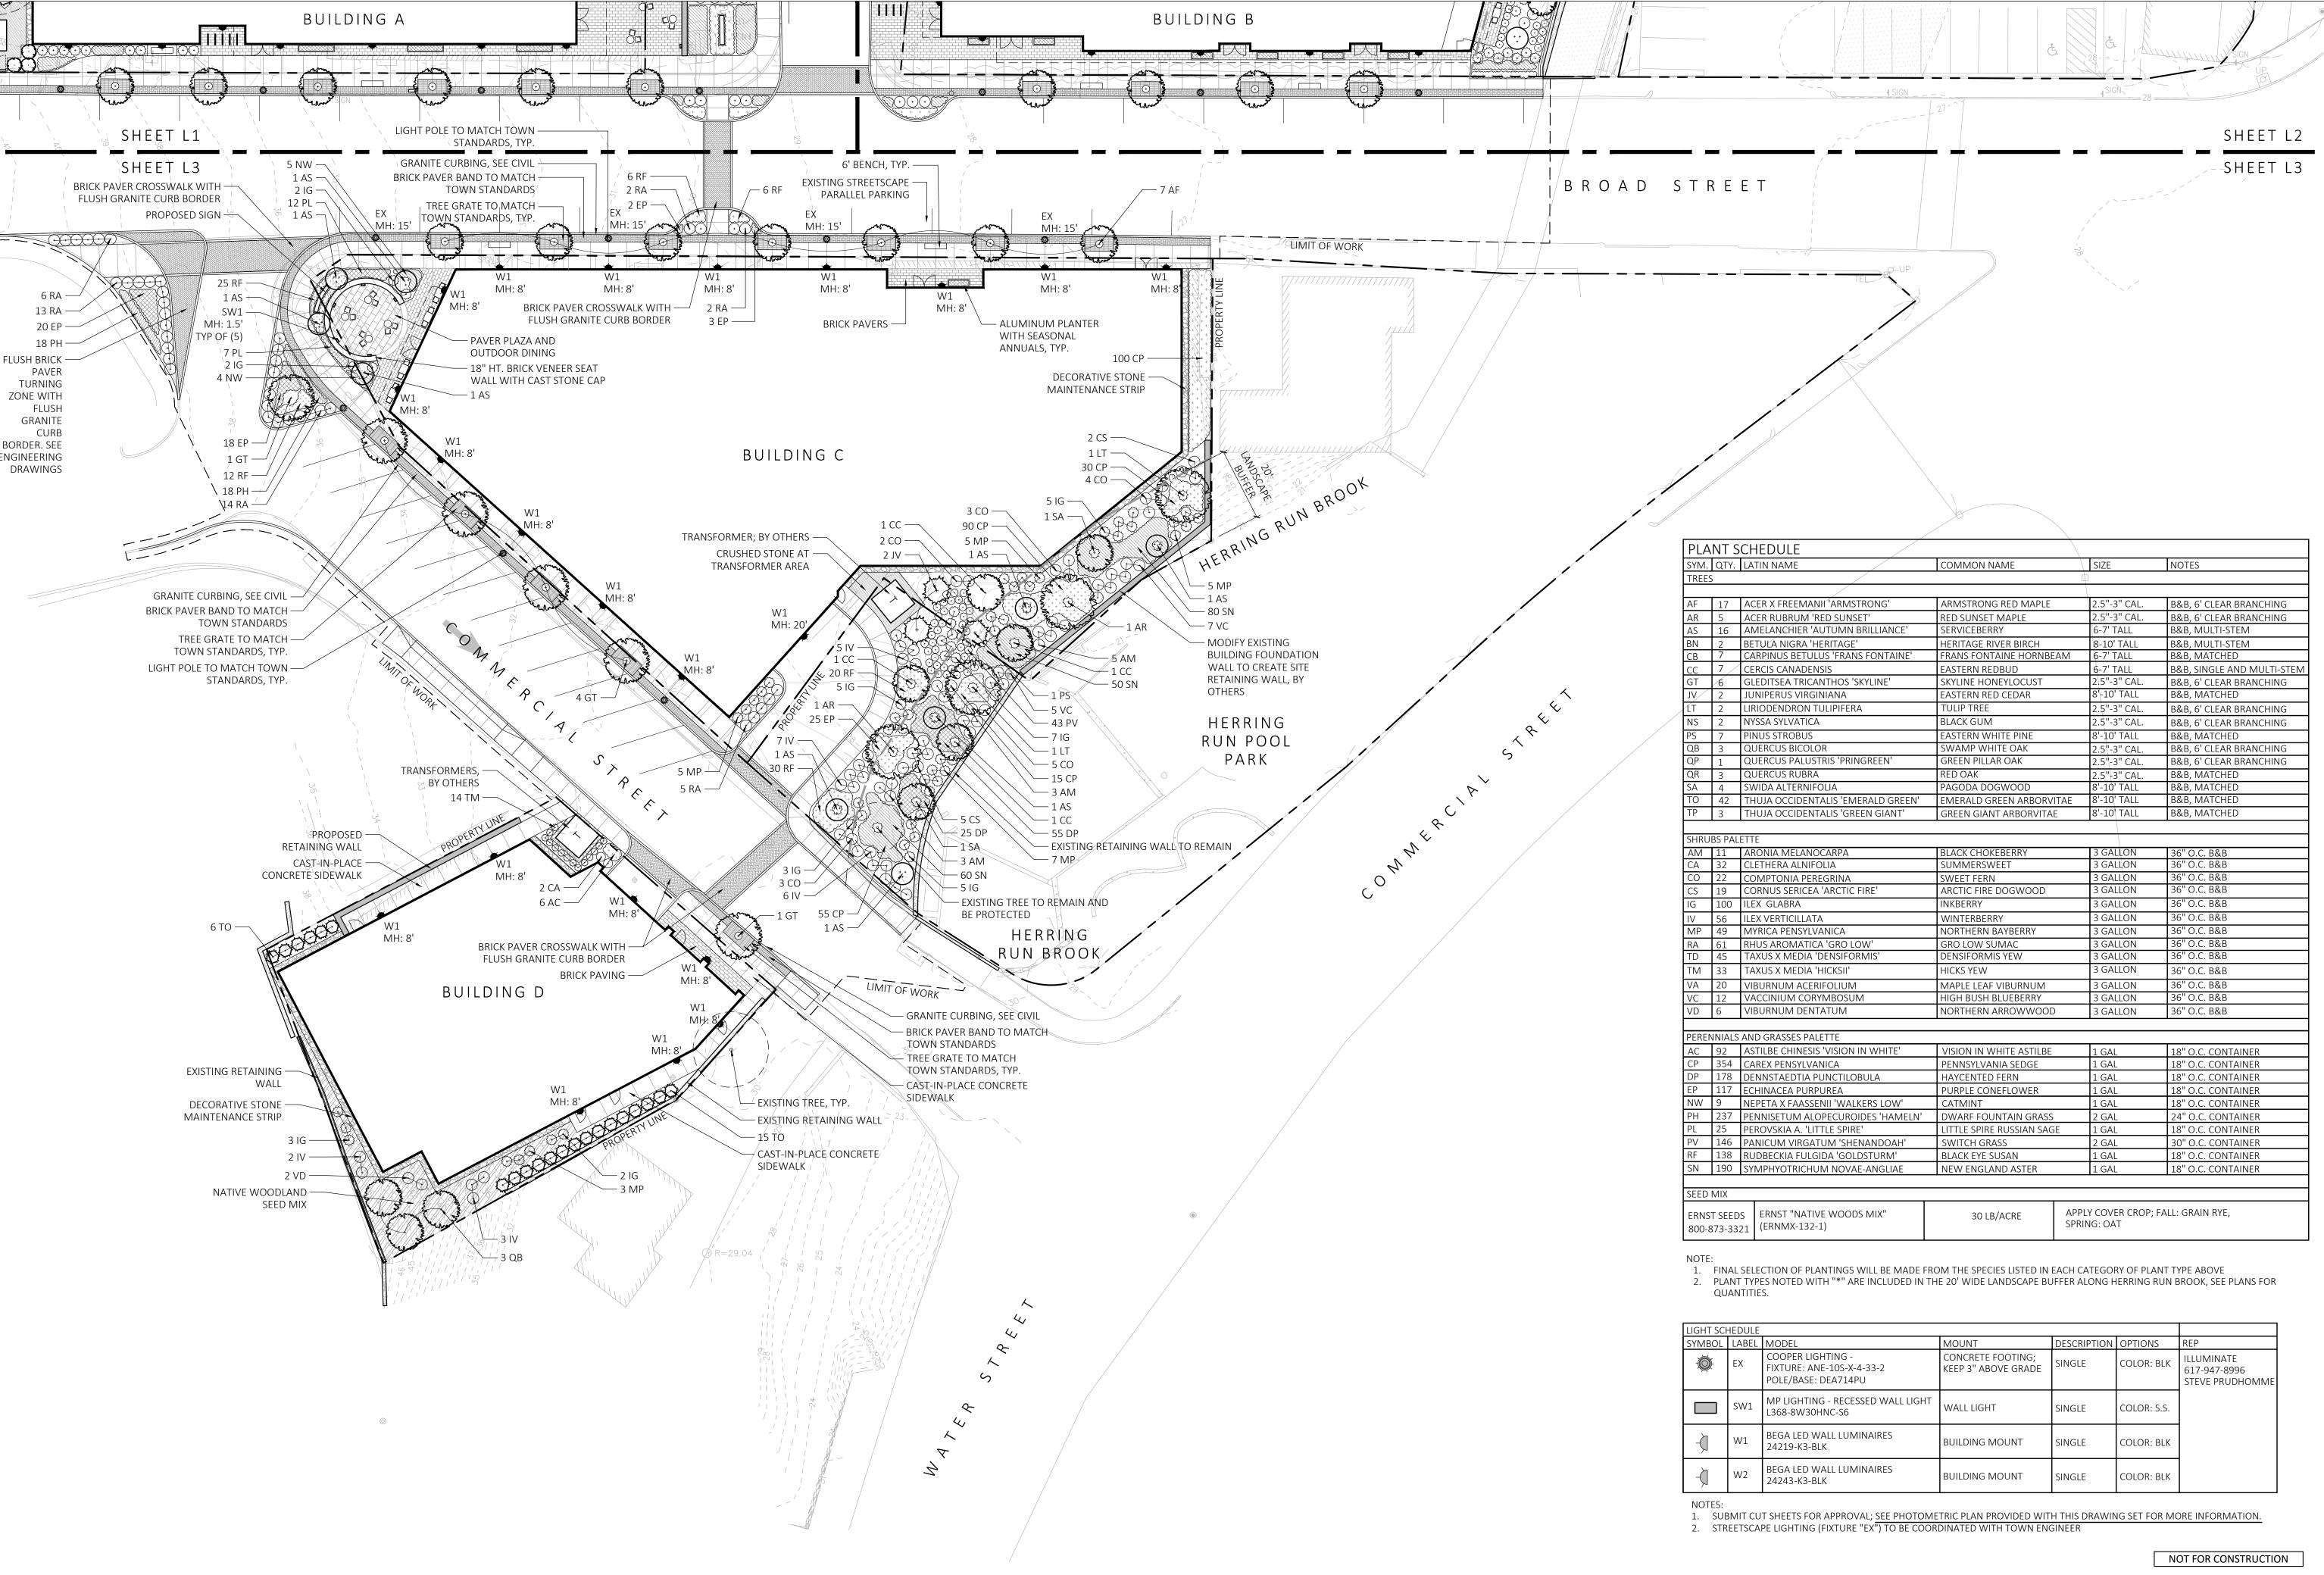DRAWING NUMBER

ARCHITECT

OWNER

SUITE 304

97 LIBBEY PARKWAY

CONSULTANTS

NORWELL, MA 02061

840 SUMMER STREET

BOSTON, MA 02127

781.792.3900

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DRAWING TITLE

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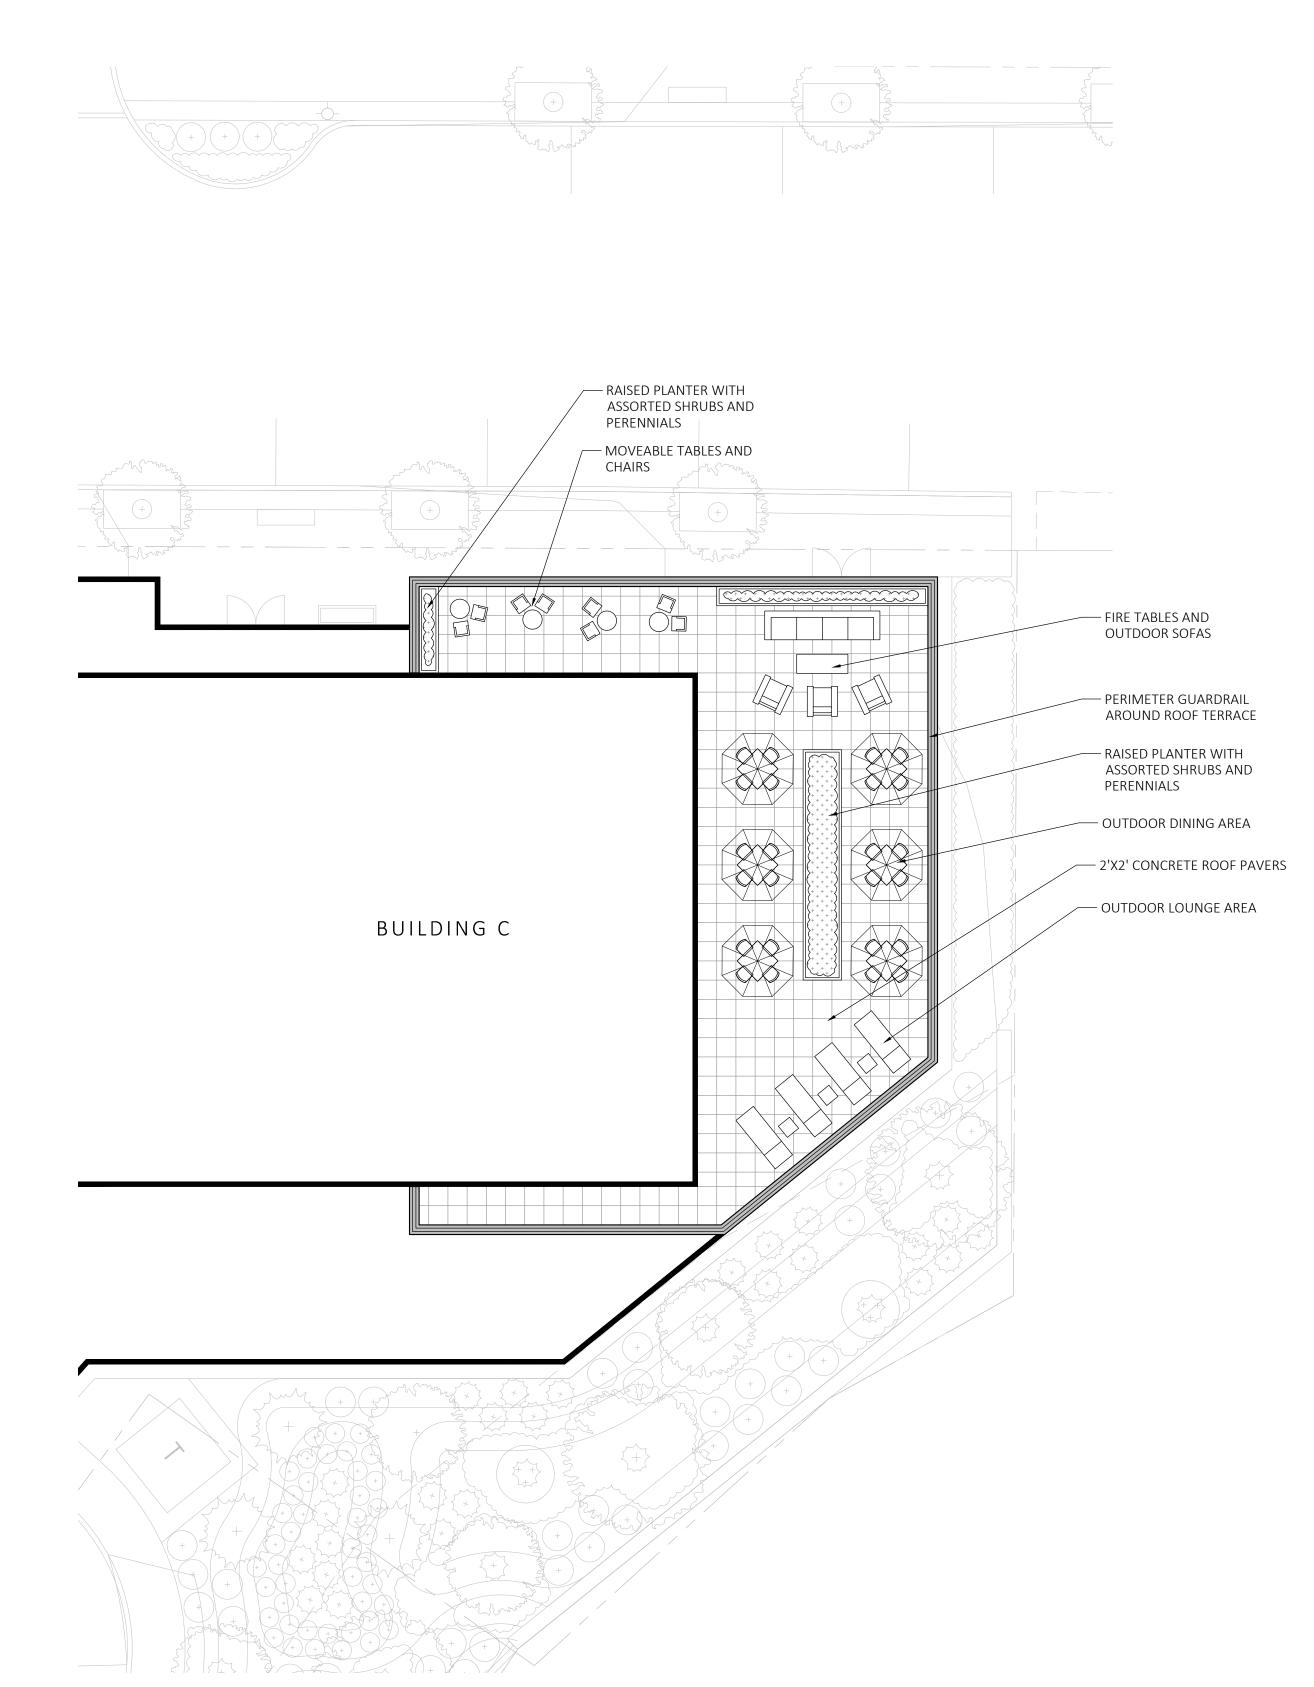
PLANTING AND

LIGHTING PLAN

REVISIONS


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ROOF DECK AMENITY SPACE ENLARGEMENT - BUILDING C

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DRAWING INFORMATION

DRAWING TITLE ROOF DECK AMENITY

ENLARGEMENTS DRAWING NUMBER

Luminaire Schedule LLF MOUNTING HEIGHT (MH) Description 14 EX SINGLE 0.900 | 15' HT. ANE-10S-X-4-33-2 9 SW1 0.900 | 1.5' HT. SINGLE L368-8W30HNC-S6 SINGLE 0.900 | 8' HT. 24219_BEGA_IES 49 W1 SINGLE 1 W2 0.900 | 20' HT. 33243_BEGA_IES

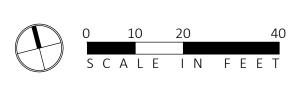Calculation Summary						
Label	Units	Avg	Max	Min	Avg/Min	Max/Min
Site	Fc	0.58	22.7	0.0	N.A.	N.A.

1. SUBMIT CUT SHEETS FOR APPROVAL; SEE PHOTOMETRIC PLAN PROVIDED WITH THIS DRAWING SET FOR MORE INFORMATION.

2. STREETSCAPE LIGHTING TO BE COORDINATED WITH TOWN ENGINEER

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O: 617.765.8000 www.embarcdesign.com

ARCHITECT

OWNER

CMK DEVELOPMENT PARTNERS 97 LIBBEY PARKWAY WEYMOUTH, MA 02189

CONSULTANTS

MCKENZIE ENGINEERING GROUP 150 LONGWATER DRIVE, SUITE 101 NORWELL, MA 02061 781.792.3900

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DRAWING TITLE


LANDSCAPE PHOTOMETRICS PLAN

DRAWING NUMBER

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LANDSCAPE PHOTOMETRICS ENLARGEMENT

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LLF MOUNTING HEIGHT (MH) Description 0.900 | 15' HT. ANE-10S-X-4-33-2 0.900 | 1.5' HT. L368-8W30HNC-S6 0.900 8' HT. 24219_BEGA_IES

33243_BEGA_IES

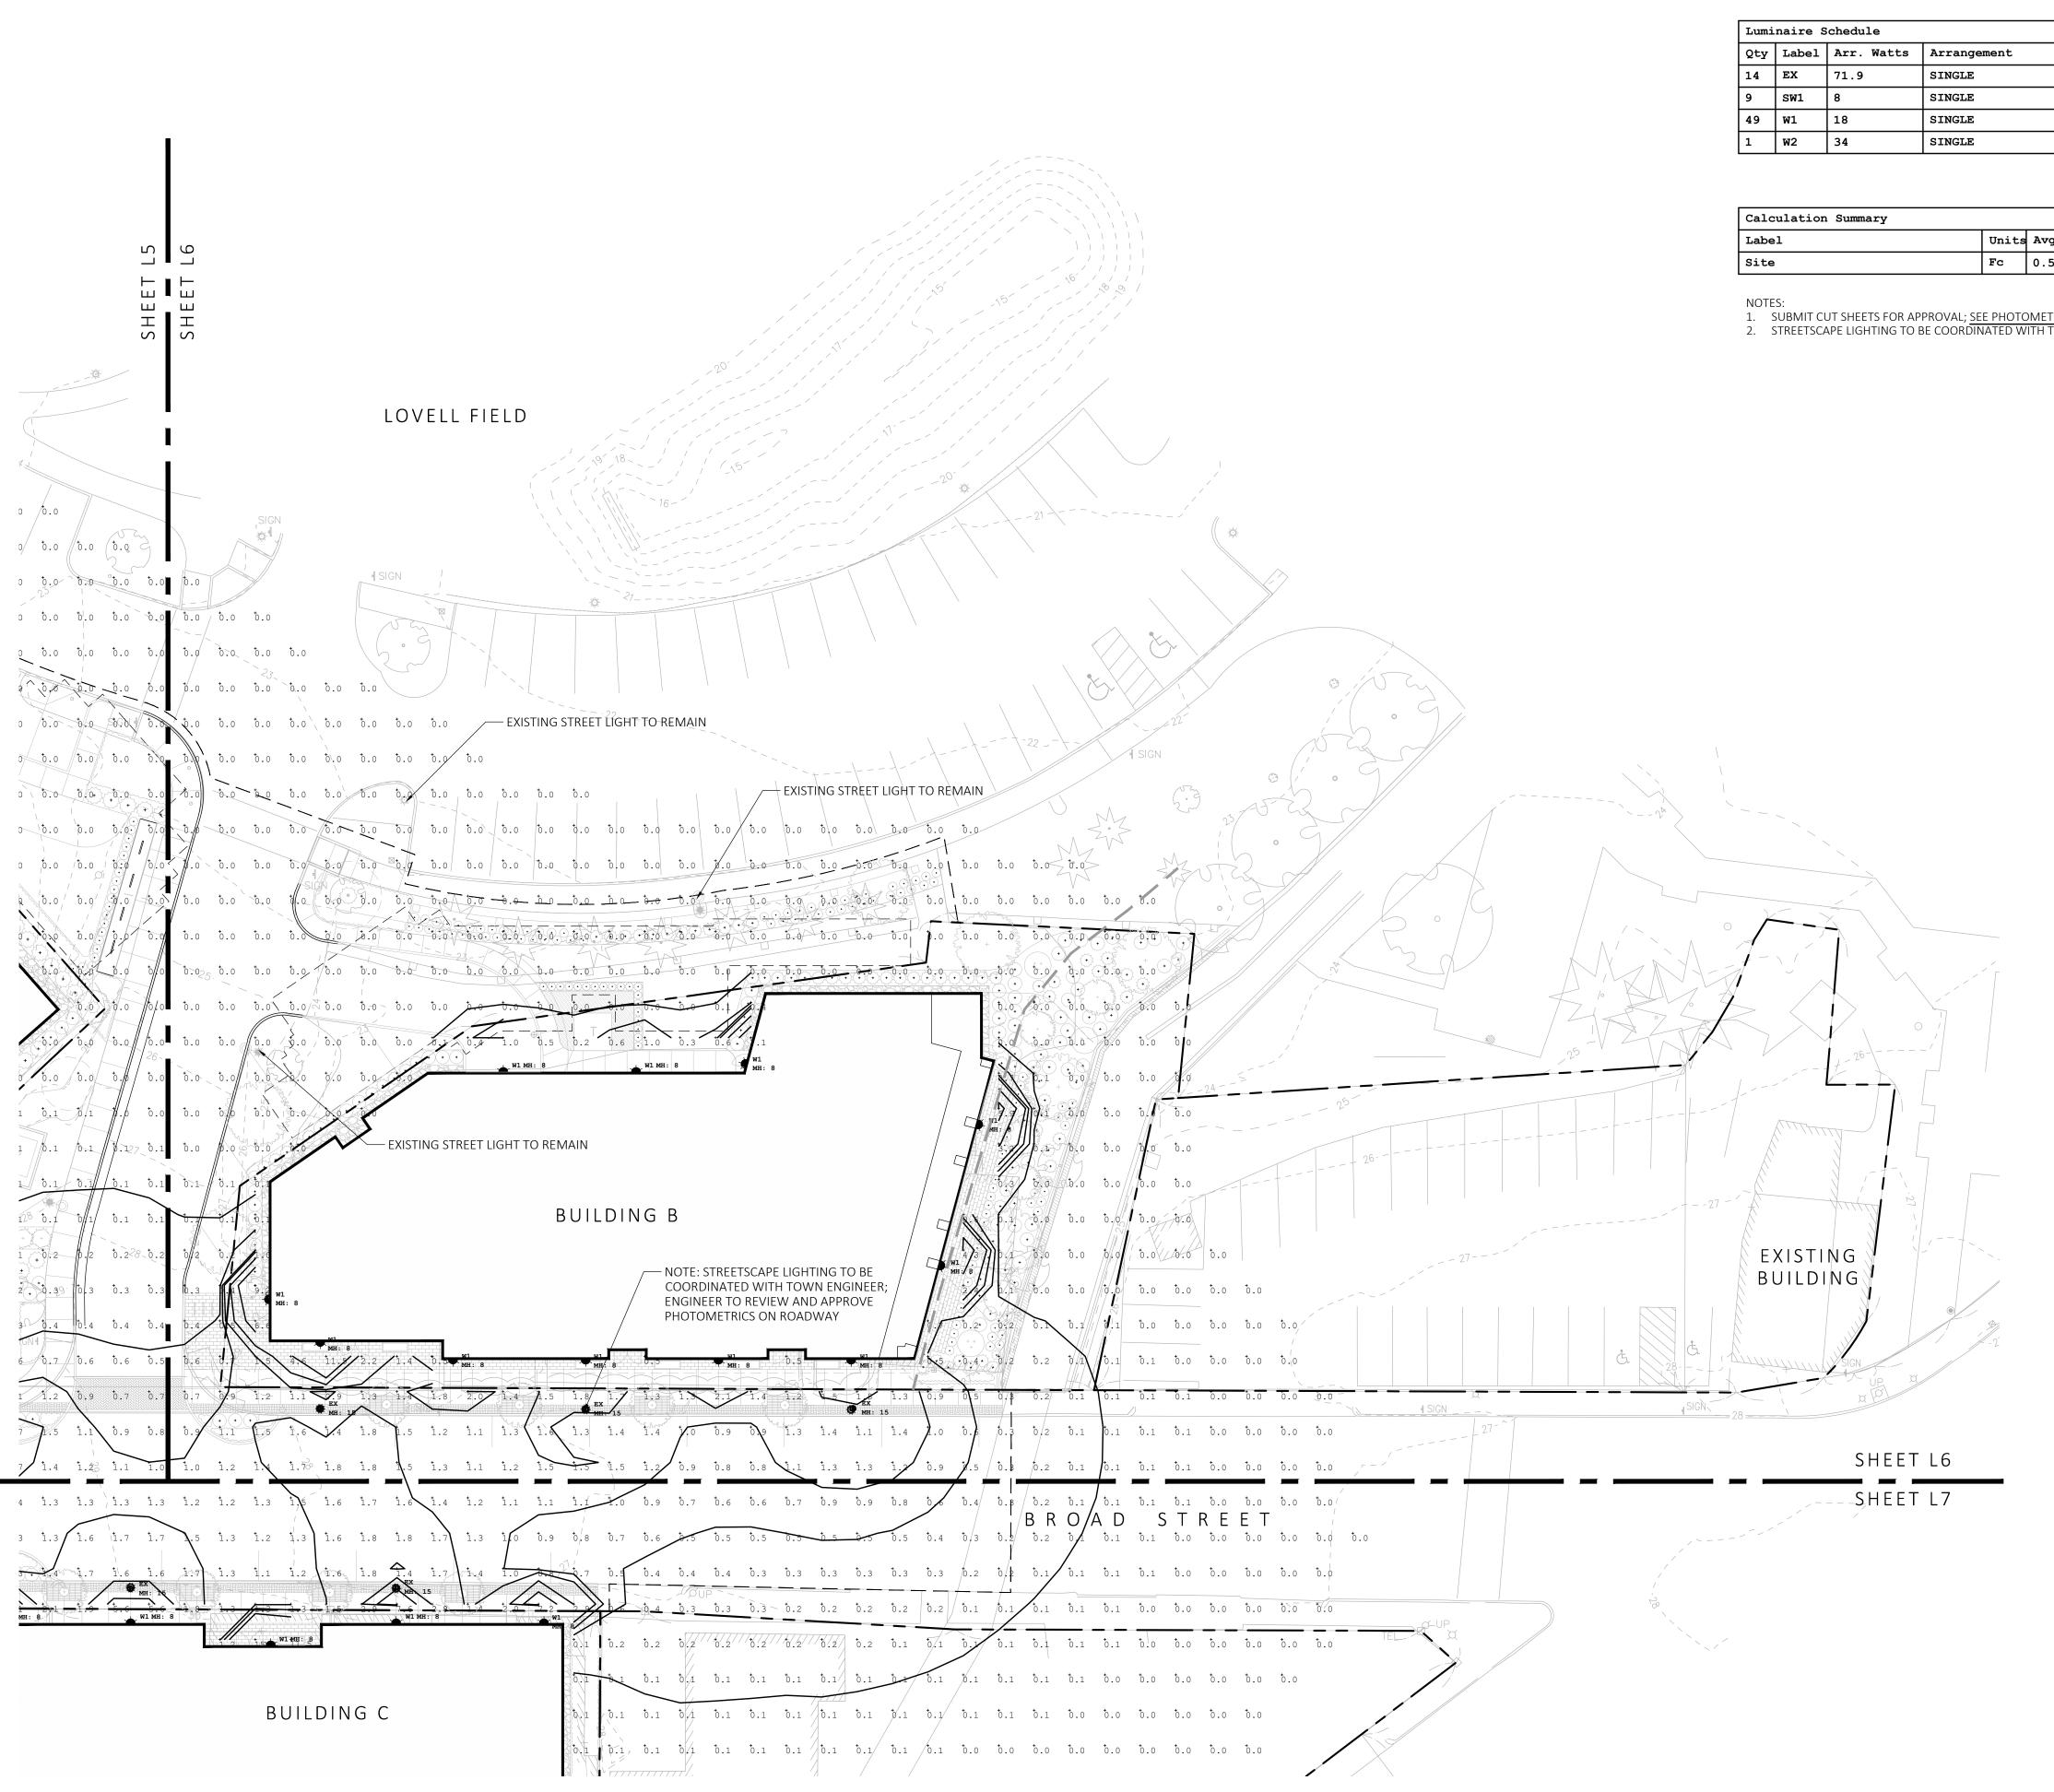Calculation Summary						
Label	Units	Avg	Max	Min	Avg/Min	Max/Min
Site	Fc	0.58	22.7	0.0	N.A.	N.A.

1. SUBMIT CUT SHEETS FOR APPROVAL; SEE PHOTOMETRIC PLAN PROVIDED WITH THIS DRAWING SET FOR MORE INFORMATION.

0.900 20' HT.

2. STREETSCAPE LIGHTING TO BE COORDINATED WITH TOWN ENGINEER

ARCHITECT

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OWNER

CMK DEVELOPMENT PARTNERS 97 LIBBEY PARKWAY SUITE 304 WEYMOUTH, MA 02189

CONSULTANTS

MCKENZIE ENGINEERING GROUP 150 LONGWATER DRIVE, SUITE 101 NORWELL, MA 02061 781.792.3900

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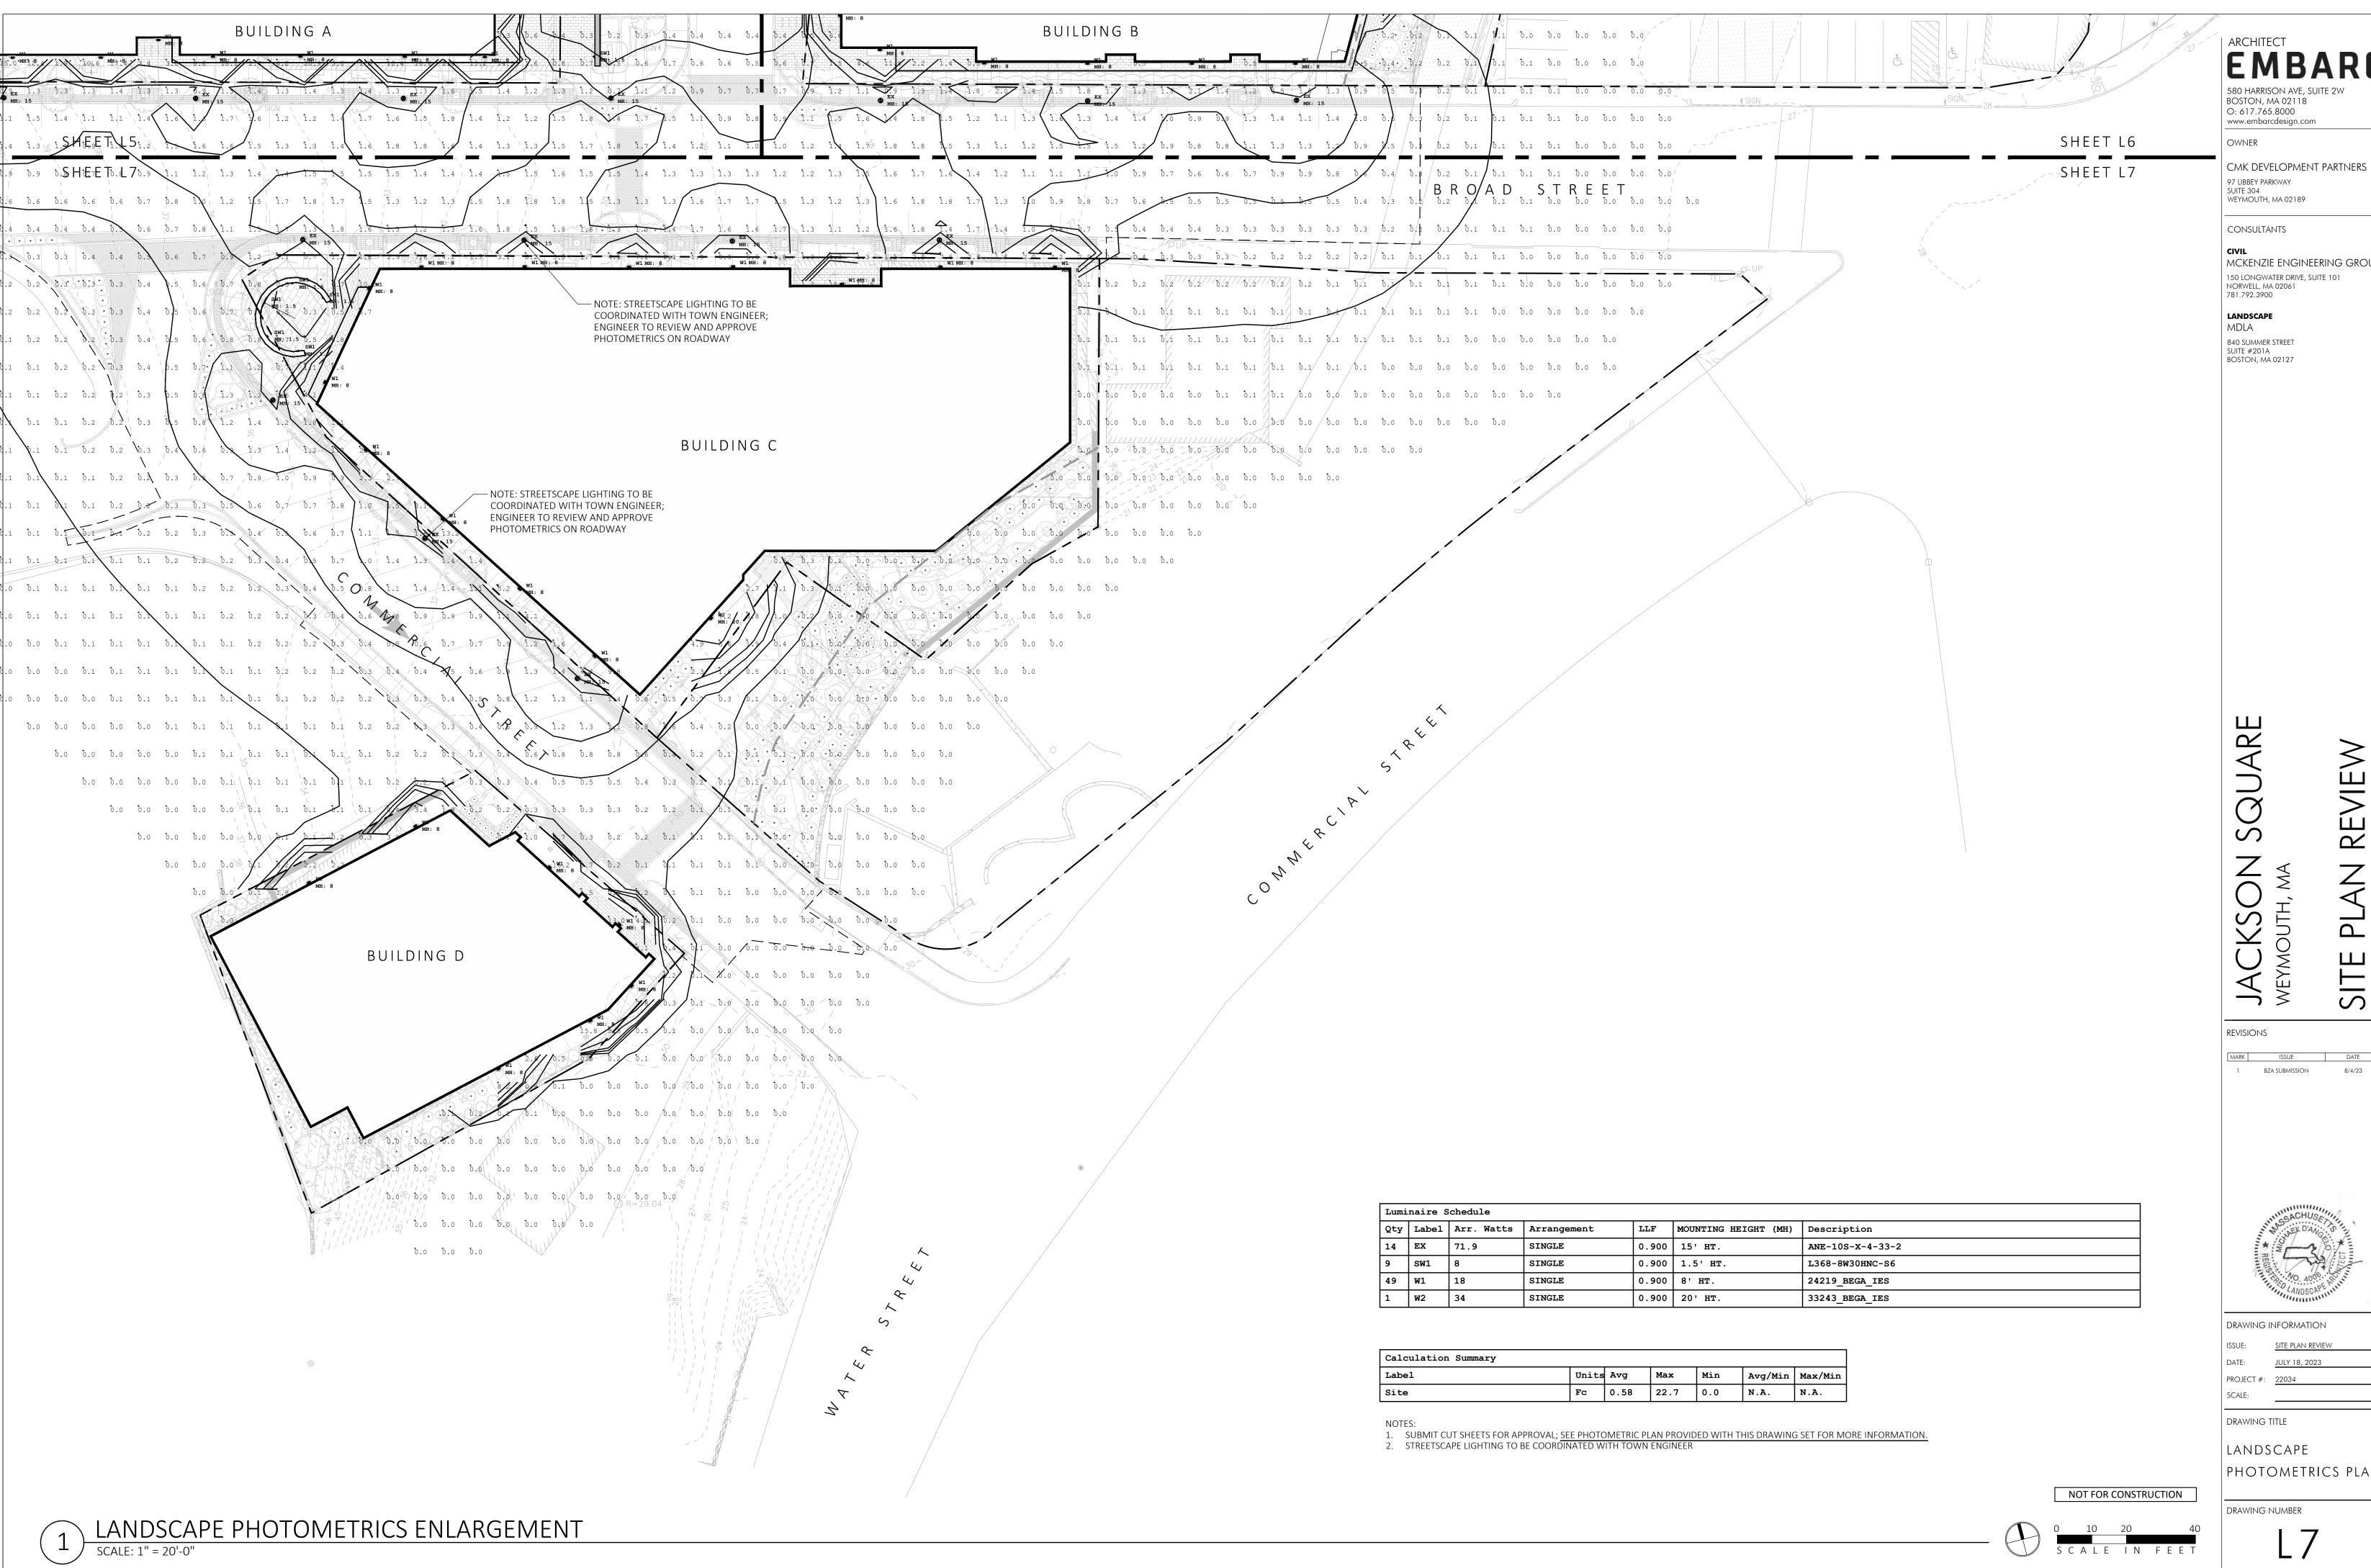
LANDSCAPE PHOTOMETRICS PLAN

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BOSTON, MA 02127

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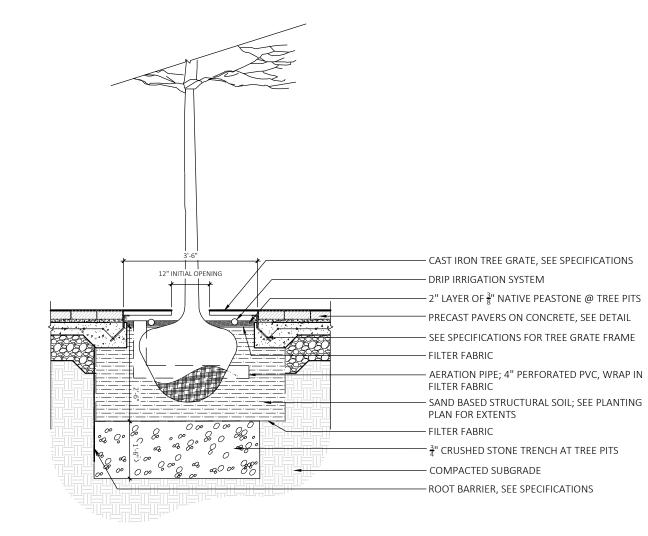


DRAWING INFORMATION

DRAWING TITLE

LANDSCAPE PHOTOMETRICS PLAN

DRAWING NUMBER



TREE GRATE - SECTION

- NEVER CUT TREE LEADER - MAINTAIN RELATIONSHIP OF ROOTFLARE TO FINISH GRADE AS EXISTED PRIOR TO INSTALL, TYP. - HOLD MULCH BACK FROM TRUNK OF TREE - BARK MULCH; SEE SPEC - TEMOPARY EARTH SAUCER – PLANTING MEDIUM; SEE SPEC BELOW-GRADE TREE ANCHORING SYSTEM; SEE SPEC. - COMPACTED OR UNDISTURBED SUBGRADE - SCARIFY SURFACE OF SUBGRADE, TYP. REMOVE ROPE / CAGE AND ROLL BACK BURLAP 1/3

ROOTBALL HT, MIN; TYP.

DECIDUOUS TREE PLANTING

DRIP LINE OF EXISTING TREE; HAND EXCAVATION ONLY WITHIN THIS ZONE. REMOVAL OF SOIL SHALL BE ONLY UPON APPROVAL OF LANDSCAPE ARCHITECT, OR OWNER PRESSURE TREATED 2X4 LUMBER STRAPPED AROUND TREE TRUNK 2" SPACE BEWTEEN BOARDS MAX. EXTEND 72" HT. ABOVE ROOT FLARE, TYP. 2" DIA. STEEL PIPE DIRECT-BURIED, 36" DEPTH IN, TYP. MESH PLASTIC SAFETY FENCE LOCATED OUTSIDE DRIPLINE OF TREE; 48" HT. MIN. - FINISH GRADE; SEE PLAN 2" DIA. STEEL PIPE DIRECT-BURIED, 36" DEPTH IN, TYP. - MESH PLASTIC SAFETY FENCE LOCATED OUTSIDE DRIPLINE OF TREE; 48" HT. MIN. TREE TRUNK PRESSURE TREATED 2X4 LUMBER SPACE BEWTEEN BOARDS, EXTEND 72" HT. ABOVE ROOT FLARE, TYP. NO MACHINERY OR MATERIALS SHALL BE THE DRIPLINE, WHICHEVER IS GREATER

PLANTING NOTES:

1. DURING CONSTRUCTION, PROTECT ALL EXISTING SITE FEATURES, STRUCTURES AND UTILITIES.

2. PLANTS SHALL BE TRUE TO SPECIES AND VARIETY SPECIFIED AND NURSERY GROWN IN ACCORDANCE WITH THE AMERICAN STANDARD FOR NURSERY STOCK UNDER CLIMATIC CONDITIONS SIMILAR TO THOSE IN THE LOCALITY OF THE PROJECT. SUBSTITUTIONS WILL BE

PERMITTED ONLY IF APPROVED BY THE LANDSCAPE ARCHITECT. 3. LANDSCAPE ARCHITECT APPROVAL IS REQUIRED BEFORE PLANT MATERIAL IS PURCHASED. LANDSCAPE ARCHITECT RESERVES THE RIGHT TO SEE ALL MATERIAL IN PERSON AT THE NURSERY. IF TRAVEL OUTSIDE OF MA IS REQUIRED, LANDSCAPE ARCHITECT'S TRAVEL COSTS

SHALL BE PAID FOR BY THE CONTRACTOR. 4. ALL EXPOSED BURLAP, WIRE BASKETS AND OTHER MATERIALS ATTACHED TO PLANTS SHALL BE REMOVED PRIOR TO PLANTING. CARE

SHALL BE TAKEN NOT TO DISTURB THE ROOT BALL OF PLANTS.

5. THOROUGHLY WATER ALL PLANTS IMMEDIATELY AFTER PLANTING. 6. WHERE DISCREPANCIES IN QUANTITIES OCCUR, DRAWINGS SUPERCEDE PLANT NOTES AND SCHEDULE.

7. TRANSPLANTING SHALL BE DONE IN ACCORDANCE WITH THE AMERICAN STANDARD FOR NURSERY STOCK.

8. LOAM USED IN PLANT BEDS SHALL BE UNIFORM IN COMPOSITION, FREE FROM SUBSOIL, STONES LARGER THAN 1", NOXIOUS SEEDS AND SUITABLE FOR THE SUPPORT OF VEGETATIVE GROWTH. THE pH VALUE SHALL BE BETWEEN 5.5 AND 6.5.

9. MULCH IN TREE AND SHRUB BEDS SHALL BE NATURAL, NATIVE HEMLOCK MULCH FREE OF GROWTH OR GERMINATION INHIBITING

INGREDIENTS. SUBMIT SAMPLES FOR APPROVAL.

10.LOCATIONS FOR PLANTS AND/OR OUTLINE OF AREAS TO BE PLANTED ARE TO BE STAKED OUT AT THE SITE FOR APPROVAL BY THE

11. SOIL DEPTHS: a.) SHRUBS AND PERENNIAL BEDS: 18" MIN.; b.) GROUNDCOVER: 6" MIN.; c.) TREES: SEE DETAIL; d.) SOD/SEED: 6"MIN. 12. PROVIDE A SUBSURFACE ROOTBALL ANCHOR BY PLATIPUS EARTH ANCHORS, SIZE FOR CALIPER

1. IRRIGATION SHALL BE A DESIGN-BUILD INSTALLATION. CONTRACTOR SHALL SUBMIT SHOP DRAWINGS FOR FINAL LAYOUT OF IRRIGATION SHOWING LOCATIONS AND SIZES OF MAIN LINES AND LATERAL LINES, ZONES, RAIN AND SOIL SENSORS, AND CUT

SHEETS FOR CONTROLLER SYSTEM AND COMPONENTS. INCLUDE ANY NECESSARY SLEEVING. 2. IRRIGATION CONTRACTOR SHALL VERIFY PSI/GPM REQUIREMENTS AT THE SITE BEFORE STARTING CONSTRUCTION.

3. TREES SHALL BE ON A SEPARATE ZONE.

4. PROVIDE A REMOTE RAIN SENSOR ON A ROOF AREA THAT IS NOT OBSTRUCTED FROM THE OPEN SKY.

5. COORDINATE WITH OWNER FOR POINT OF CONNECTION LOCATION.

6. COORDINATE WITH OWNER FOR IRRIGATION CONTROLLER LOCATION.

7. INSTALL DRIP TUBING, .6GPH, 12" CENTERS, STAKED EVERY TURN OR EVERY 4'

8. COORDINATE WITH OWNER FOR BACKFLOW PREVENTION LOCATION.

9. INSTALLER SHALL INSTALL LIGHTNING AND SURGE PROTECTION DEVICES THROUGHOUT SYSTEM AS PER MANUFACTURER'S HIGHEST SPECIFICATION LEVELS. 10.INSTALLER SHALL ADHERE TO ALL MANUFACTURER'S SPECIFICATIONS RELATED TO CONTROL SYSTEM INSTALLATION.

11.INSTALLER SHALL INSTALL MOISTURE SENSORS. CONTRACTOR SHALL INSTALL PER MANUFACTURERS'S SPECIFICATIONS AND SHALL

BE RESPONSIBLE TO PROGRAM RELATED HYDROZONES TO RESPECTIVE SOIL MOISTURE SENSORS. PROVIDE ONE FOR EACH IRRIGATION ZONE WITH AUTOMATIC SHUT-OFF ONCE MOISTURE REQUIREMENTS ARE MET.

12.PRIOR TO BID, CONTRACTOR TO VERIFY THAT ALL MATERIALS, INSTALLATION PARAMETERS, AND OPERATIONS CONFORM TO ALL APPLICABLE CODES AND ORDINANCES. NO LATER THAN FIVE DAYS BEFORE BID SUBMITTALS CONTRACTOR SHALL NOTIFY DESIGNER AND OWNER OF ANY CHANGES REQUIRED DUE TO CURRENT CODE OR ORDINANCE DISCREPANCIES.

ARCHITECT 580 HARRISON AVE, SUITE 2W

NOT FOR CONSTRUCTION

IRRIGATION NOTES: NEVER CUT TREE LEADER MAINTAIN RELATIONSHIP OF ROOTFLARE TO FINISH GRADE AS EXISTED PRIOR TO INSTALL, TYP. HOLD MULCH BACK FROM TRUNK OF TREE - BARK MULCH; SEE SPEC TEMOPARY EARTH SAUCER - PLANTING MEDIUM; SEE SPEC BELOW-GRADE TREE ANCHORING SYSTEM; STRAPPED AROUND TREE TRUNK 2" - COMPACTED OR UNDISTURBED SUBGRADE - SCARIFY SURFACE OF SUBGRADE, TYP. - REMOVE ROPE / CAGE AND ROLL BACK BURLAP 1/3 ROOTBALL HT, MIN; TYP. STORED WITHIN THE FENCED AREA, OR BELOW EVERGREEN TREE PLANTING **EXISTING TREE PROTECTION**

BOSTON, MA 02118 O: 617.765.8000

www.embarcdesign.com

CMK DEVELOPMENT PARTNERS 97 LIBBEY PARKWAY

CONSULTANTS

WEYMOUTH, MA 02189

OWNER

MCKENZIE ENGINEERING GROUP 150 LONGWATER DRIVE, SUITE 101

LANDSCAPE MDLA

NORWELL, MA 02061 781.792.3900

840 SUMMER STREET SUITE #201A BOSTON, MA 02127

REVISIONS

BZA SUBMISSION




DRAWING INFORMATION

DRAWING TITLE LANDSCAPE

DETAILS

DRAWING NUMBER

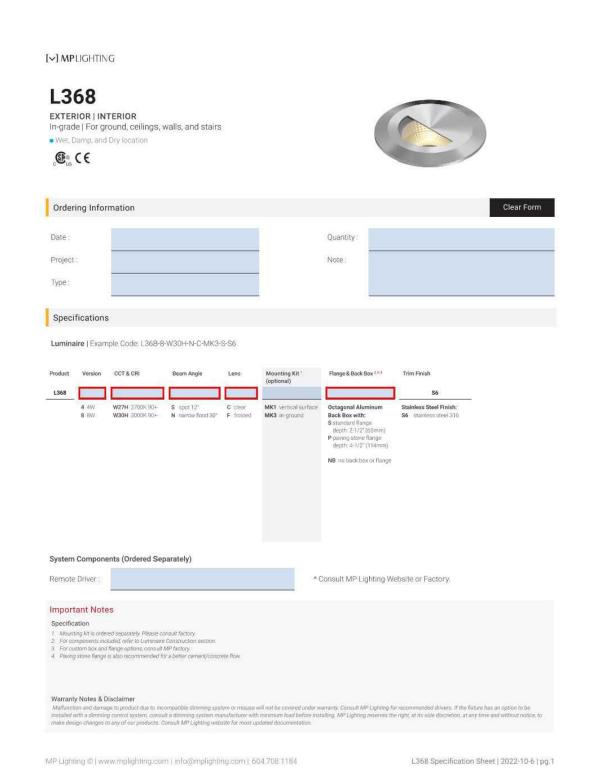

Weight: 8.2 lbs

Electrical
Operating voltage
Minimum start temperature
LED module wattage
System wattage
Controllability
Color rendering index
Luminaire lumens
Lifetime at Ta = 15° C
Lifetime at Ta = 50° C LED color temperature

4000K - Product number + K4

5000K - Product number + K35

7000K - Product number + K3 **BEGA** can supply you with suitable LED replacement modules for up to 20 years after the purchase of LED luminaires - see website for details Finish
All BEGA standard finishes are matte, textured polyester powder coat with minimum 3 mil thickness. Available colors © Black (BLK) © White (WHT) © RAL:

© Bronze (BRZ) © Silver (SLV) © CUS: LED wall luminaire - symmetrical light distribution LED A B C 24219 14.9W 11 11 5% BEGA 1000 BEGA Way, Carpinteria, CA 93013 (805) 684-0533 info@bega-us.com W1 - BUILDING MOUNTED LIGHT

LED wall luminaires - symmetrical light distribution

LED will furniaires with symmetrical light distribution designed for general illumination of pathways, plazas and building entrances.

Materials
Luminaire housing constructed of die-cast marine grade, copper free
(≤0.3% copper content) A360.0 aluminum alloy
Matte safety glass
Reflector made of pure anodized aluminum
Silicone applied robotically to casting, plasma treated for increased adhesion
High temperature silicone gasket
Mechanically captive stainless steel fasteners

NRTL listed to North American Standards, suitable for wet locations Protection class IP65 Weight: 8.2 lbs

BEGA Product:

Modified:



W2 - BUILDING MOUNTED LIGHT



Ernst Conservation Seeds 8884 Mercer Pike

Meadville, PA 16335 (800) 873-3321 Fax (814) 336-5191 www.ernstseed.com

Date: August 08, 2022

Right-of-Way Native Woods Mix w/Annual Ryegrass - ERNMX-132-1

	Botanical Name	Common Name	Price/Lb
29.00 %	Panicum clandestinum, Tioga	Deertongue, Tioga	22.14
20.00 %	Lolium multiflorum	Annual Ryegrass	1.20
15.00 %	Elymus virginicus, Madison-NY Ecotype	Virginia Wildrye, Madison-NY Ecotype	10.16
15.00 %	Panicum virgatum, 'Shelter'	Switchgrass, 'Shelter'	12.22
10.00 %	Festuca rubra	Creeping Red Fescue	8.40
5.00 %	Agrostis perennans, Albany Pine Bush-NY Ecotype	Autumn Bentgrass, Albany Pine Bush-NY Ecotype	16.80
3.00 %	Carex vulpinoidea, PA Ecotype	Fox Sedge, PA Ecotype	28.80
3.00 %	Chamaecrista fasciculata, PA Ecotype	Partridge Pea, PA Ecotype	7.20
100.00 %		Mix Price/Lb Bulk:	\$12.78

Seeding Rate: 30 lb per acre

Woodland Openings

The shade-tolerant grasses and legumes are ideal for over seeding log landings and bioengineering sites. Mix formulations are subject to change without notice depending on the availability of existing and new products. While the formula may change, the guiding philosophy and function of the mix will not.

> Price quotes guaranteed for 30 days. All prices are FOB Meadville, PA. Please check our web site at www.ernstseed.com for current pricing when placing orders.

EMBARC 580 HARRISON AVE, SUITE 2W BOSTON, MA 02118 O: 617.765.8000 www.embarcdesign.com OWNER

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CONSULTANTS

ARCHITECT

MCKENZIE ENGINEERING GROUP 150 LONGWATER DRIVE, SUITE 101 NORWELL, MA 02061 781.792.3900

LANDSCAPE MDLA

840 SUMMER STREET SUITE #201A BOSTON, MA 02127

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revisions

1 BZA SUBMISSION 8/4/23



DRAWING INFORMATION

PROJECT #: 22034

DRAWING TITLE

SCALE:

LANDSCAPE DETAILS

DRAWING NUMBER