90 Libbey Parkway, Weymouth, MA Loading Dock Site Plans FOXROCK LIBBEY REALTY, LLC

20 Cabot Blvd. Suite 305 Mansfield, MA 02048 Phone: 508-786-2200



www.tetratech.com

DEVELOPER: FOXROCK LIBBEY REALTY, LLC 350 Granite Street, Suite 2205 BRAINTREE, MA 02169



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Civil Engineer

Tetra Tech INE

TETRA TECH

Landscape Architect
Terraink Landscape Architecture
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www.terraink.com



DRAWING LIST

C-1 COVER SHEET

C-2 EXISTING CONDITIONS PLAN

C-3 SITE LAYOUT PLAN

C-4 GRADING, DRAINAGE AND UTILITY PLAN

-5 DETAIL SHEET

C-6 DETAIL SHEET

L3.01 SCREEN - PLANTING


SL.101 SITE LIGHTING PLAN

ISSUED:

MAY 5, 2023 LOADING DOCK SITE PLANS



USGS MAP:					
Homestead Sch AV Homest	Pukaping 2 Pukaping 2 Pukaping 3 Ritherton Plant Pont Pit Sch Gravel Pit 30 Gravel Pit 30 Pratt Sch Rest Area BM 313 BM A BM A BM A BM A BM BM BM	90 LIBBEY PARKWAY, WEYMOUTH, MA LOADING DOCK SITE PLANS			
	Water Jank Ju High Mit Hope out st	Project No.: 143-			
West 48	47.0	Designed By:			
STATE PARK AND THE	The second secon	Drawn By: Checked By:			
49.0	St. Francis Xavier Sch. Sch. St. Francis Xavier Hospital Talbot Sch. Sch. Sch. Sch. Sch. Sch. Sch. Sch.	(A)			
Highland	POS Fire Sign 1997	ا			

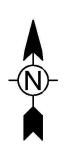



	LEGEND	
EXISTING		PROPOSED
210X23	SPOT GRADE	140X50
	TOP OF WALL ELEVATION	123.5TW
	BOTTOM OF WALL ELEVATION	120.0BW
	CONTOUR	136
□ CB	CONCRETE BOUND	
□ SB	STONE BOUND	
OH	DRILL HOLE	
*	LIGHT POLE	
-0-	UTILITY POLE	
⊗W∨	WATER VALVE	
	DRAIN LINE	SD
SS	SEWER LINE	SS
	GAS LINE	
	UNDERGROUND ELECTRIC	
W ·	WATER LINE	
OE	OVERHEAD WIRES	
■ CB	CATCH BASIN	
\triangleright	FLARED END OUTLET	
DMH	DRAIN MANHOLE	
SMH	SEWER MANHOLE	
•	HYDRANT	
⊗ GG	GAS GATE	
MW	MONITORING WELL	
- 	TEST PIT	
vGC	BOLLARD VERTICAL GRANITE CURB	
CC	CONCRETE CURB	CC
		- -


ZONING ANALYSIS TABLE: District - Planned Office Park (POP)			
ITEM	REQUIRED	EXISTING	PROVIDED
MINIMUM LOT AREA	43,560 S.F. (1.0 Ac.)	369,141 S.F. (8.47 Ac.)	NO CHANGE
MINIMUM LOT WIDTH	150'	>150'	NO CHANGE
MINIMUM FRONTAGE	NO REQ'MT.	998±'	NO CHANGE
FRONT SETBACK	40'	39.0'	NO CHANGE
SIDE SETBACK	25'	41.2'	NO CHANGE
REAR SETBACK	25'	253±'	NO CHANGE
BUILDING LOT COVERAGE (1)	NO REQ'MT.	15.9%	NO CHANGE
MAX LOT IMPERVIOUS COVERAGE (2)	60%	54.7%	56.1%
MAXIMUM STORIES	3	2	NO CHANGE
MAXIMUM HEIGHT	35'	<35'	NO CHANGE

(1) WEYMOUTH ZONING ORDINANCE DEFINES <u>LOT COVERAGE</u> AS: "THE FIXED RELATION BETWEEN THE LOT AREA AND THE AREA OF GROUND COVERAGE OF ALL BUILDINGS, INCLUDING ACCESSORY BUILDINGS, AND EXPRESSED AS A PERCENTAGE".


(2) LOT IMPERVIOUS COVERAGE: THE FIXED RELATION BETWEEN THE LOT AREA AND THE AREA OF IMPERVIOUS COVERAGE OF ALL BUILDINGS AND PAVEMENT EXPRESSED AS A PERCENTAGE.


.23 10:13 AM -P:∖42892∖143-42892-23004∖CAD\SheetFiles\C-1 Loading Dock Cover.DWG-PAPPAS, JU

PAVEMENT EXPRESSED

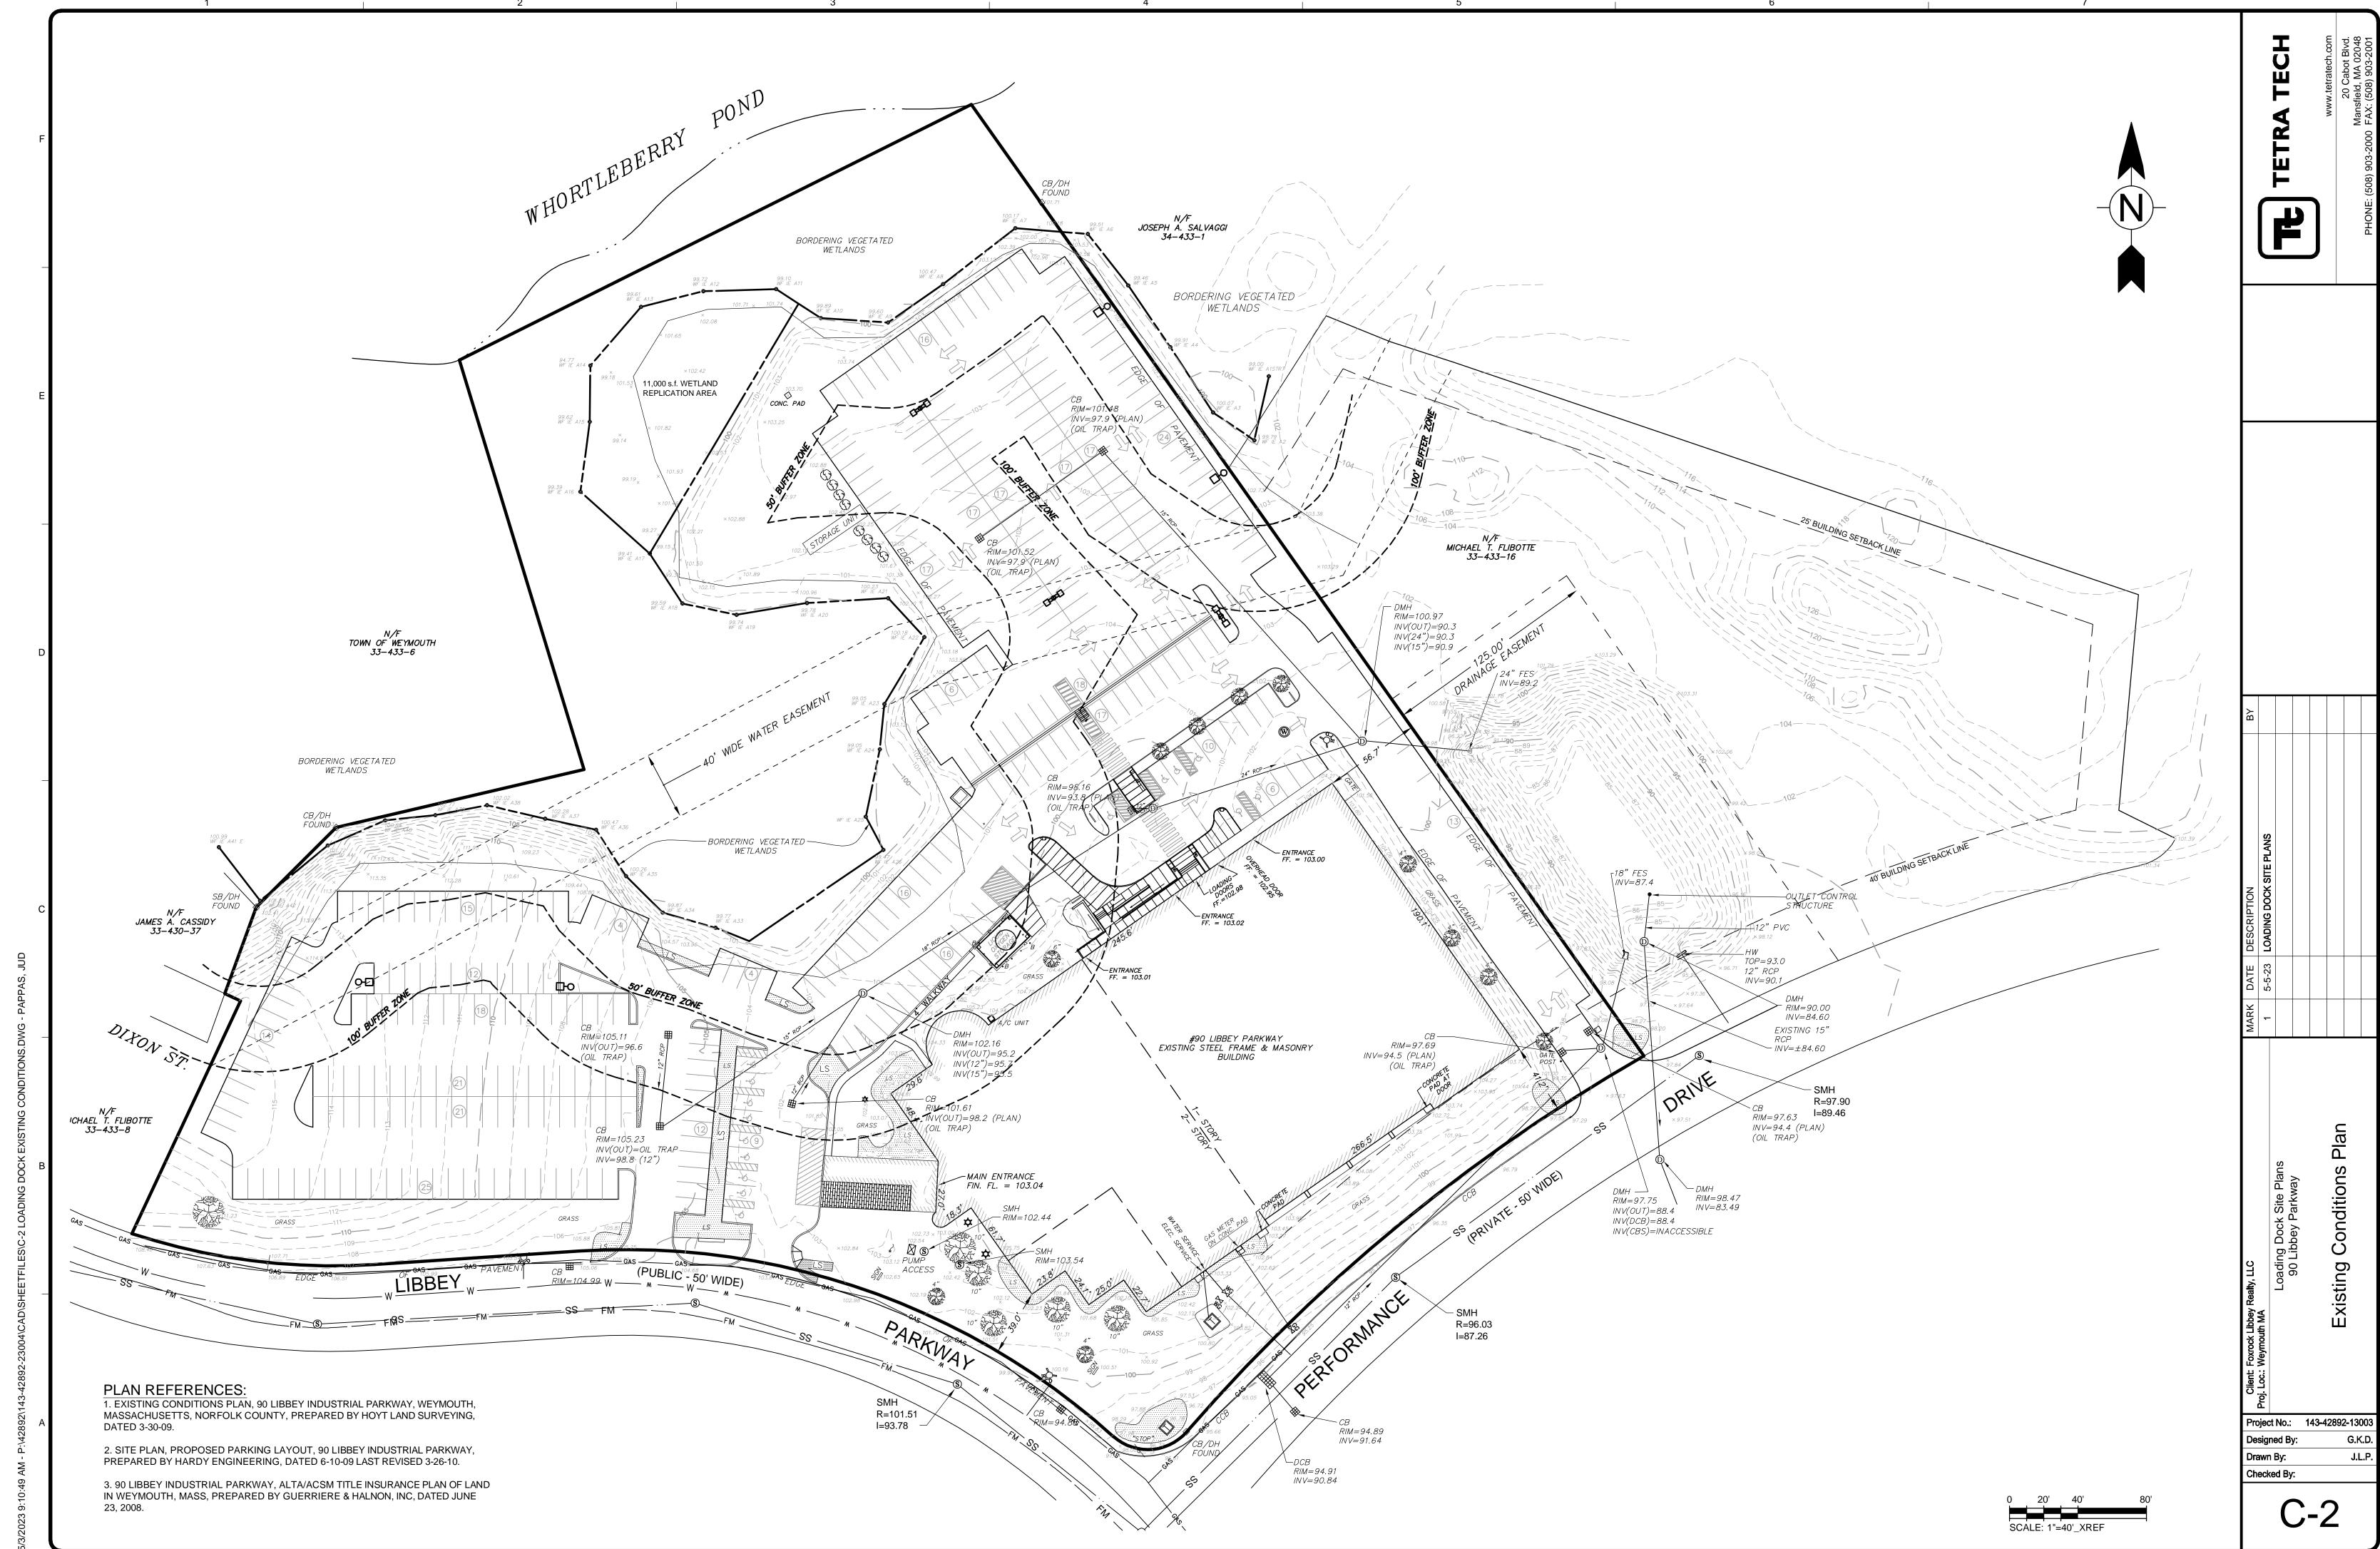

Bar Measures 1 inch

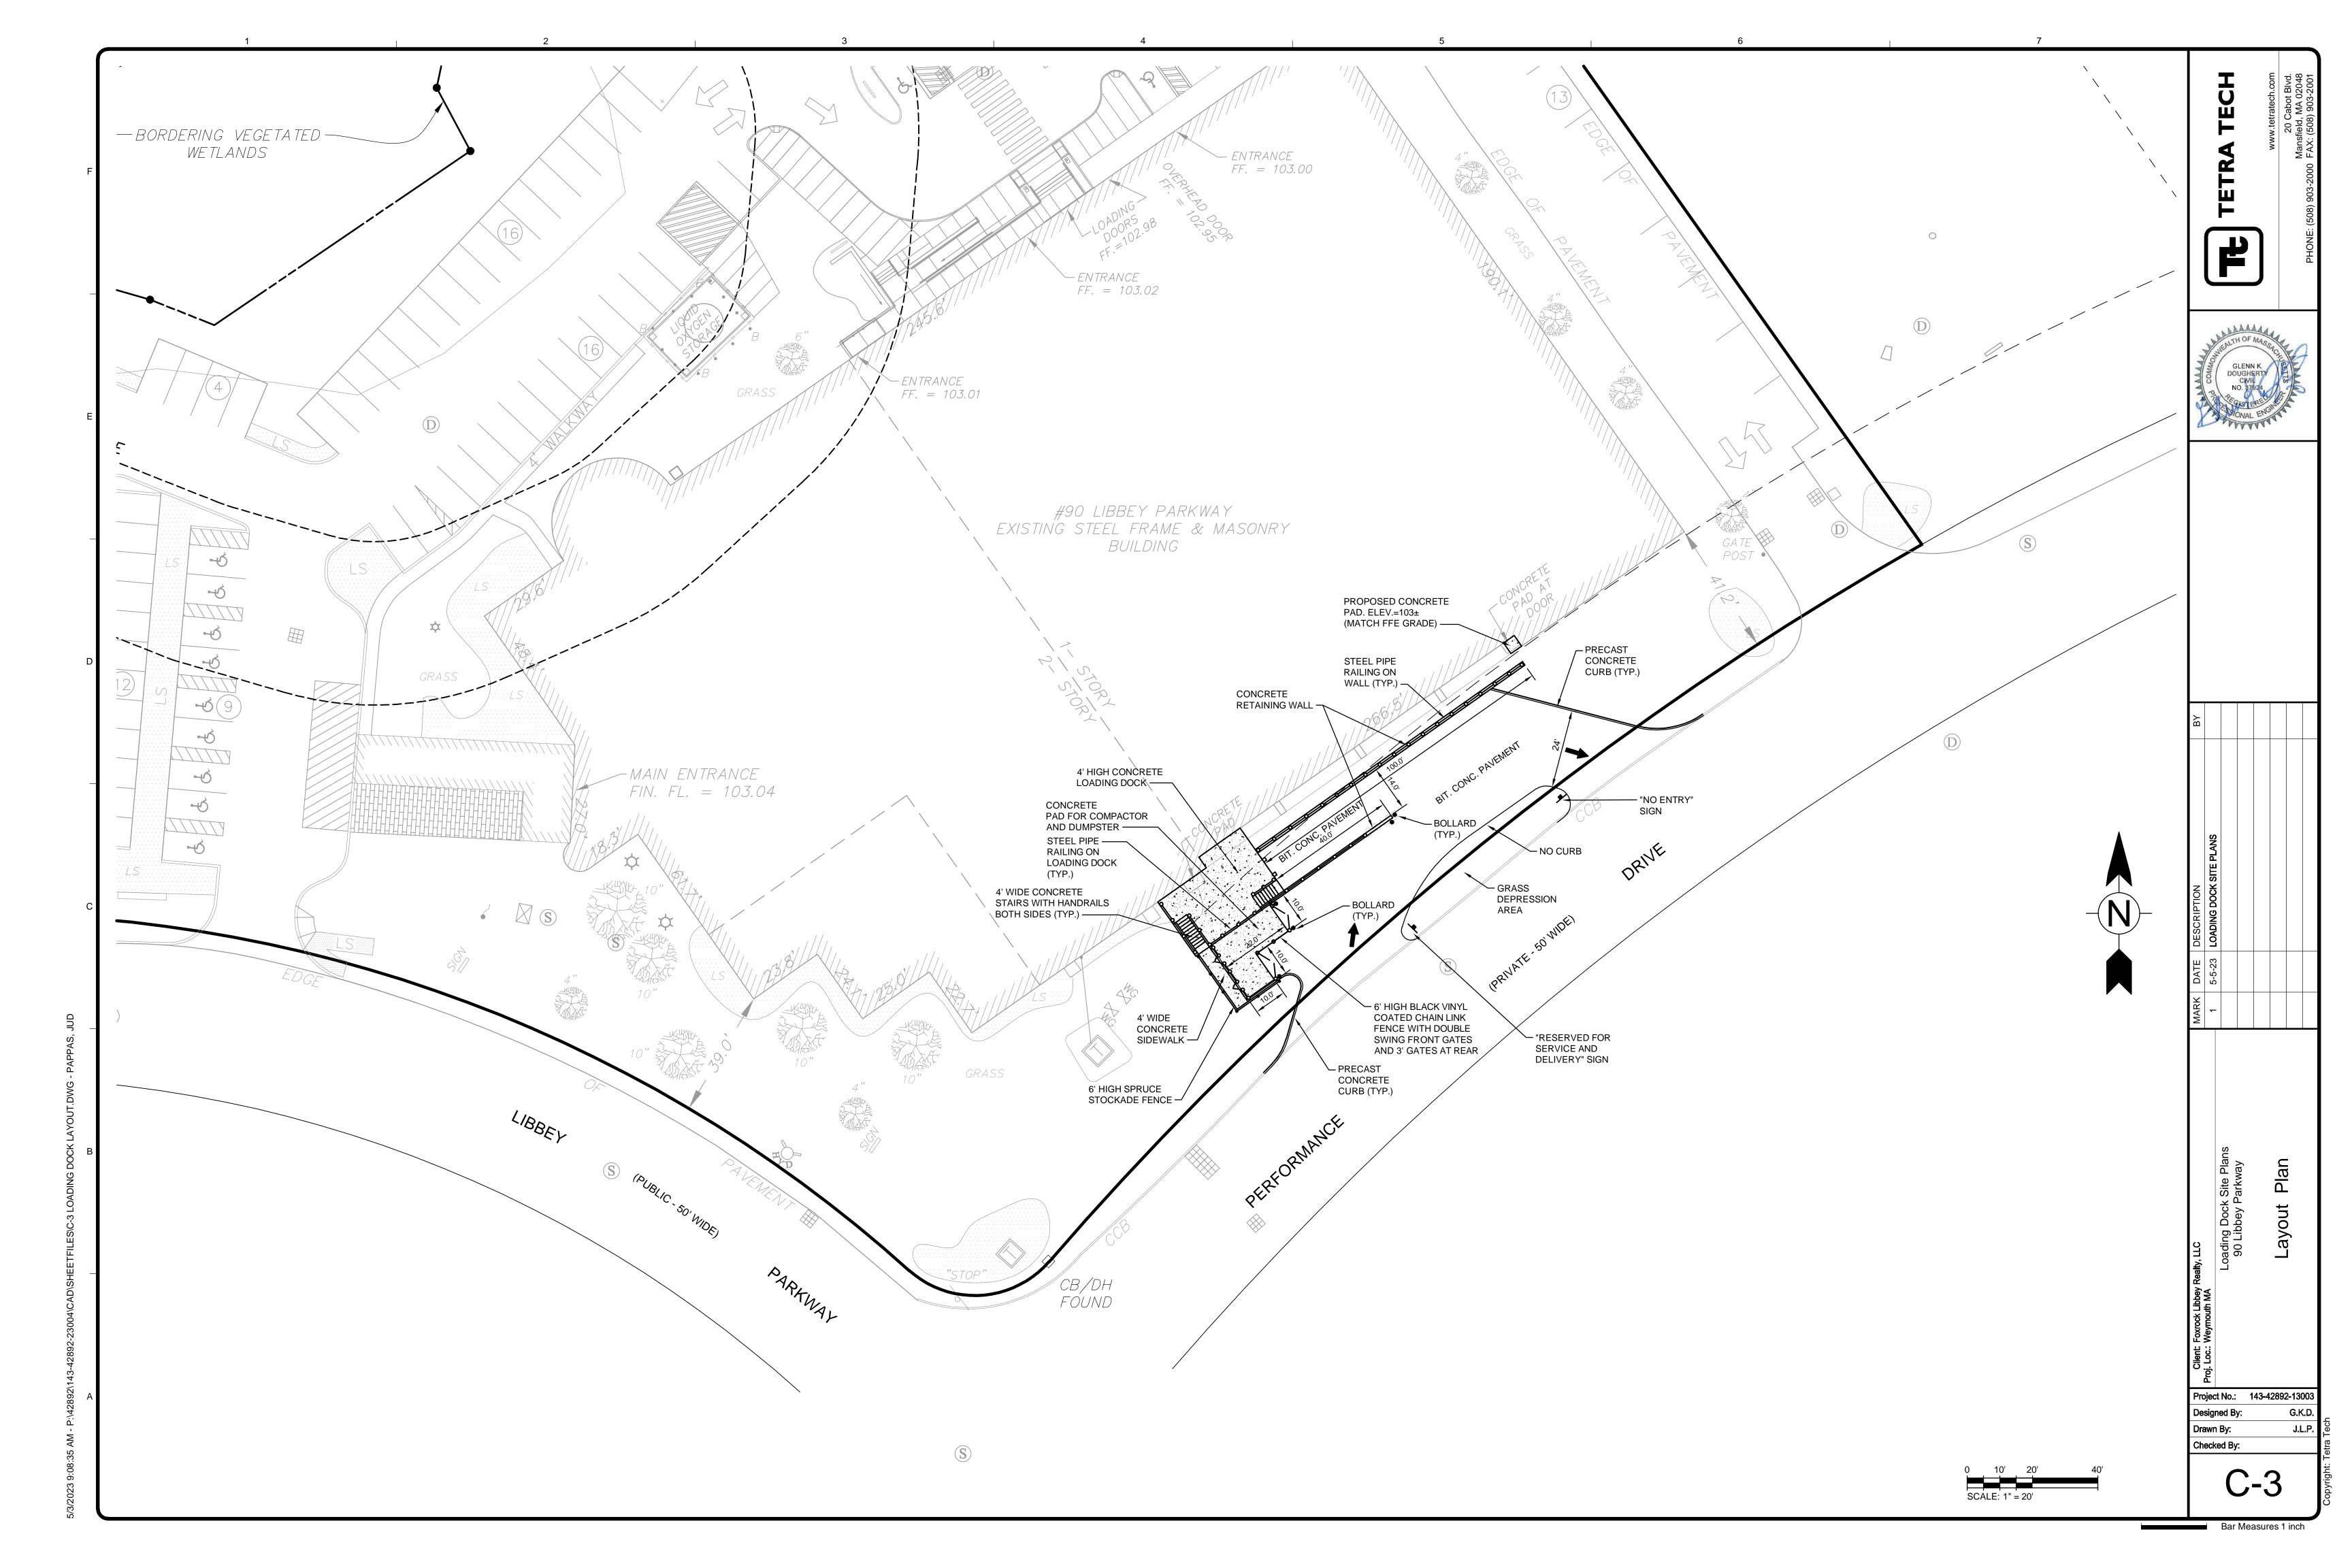

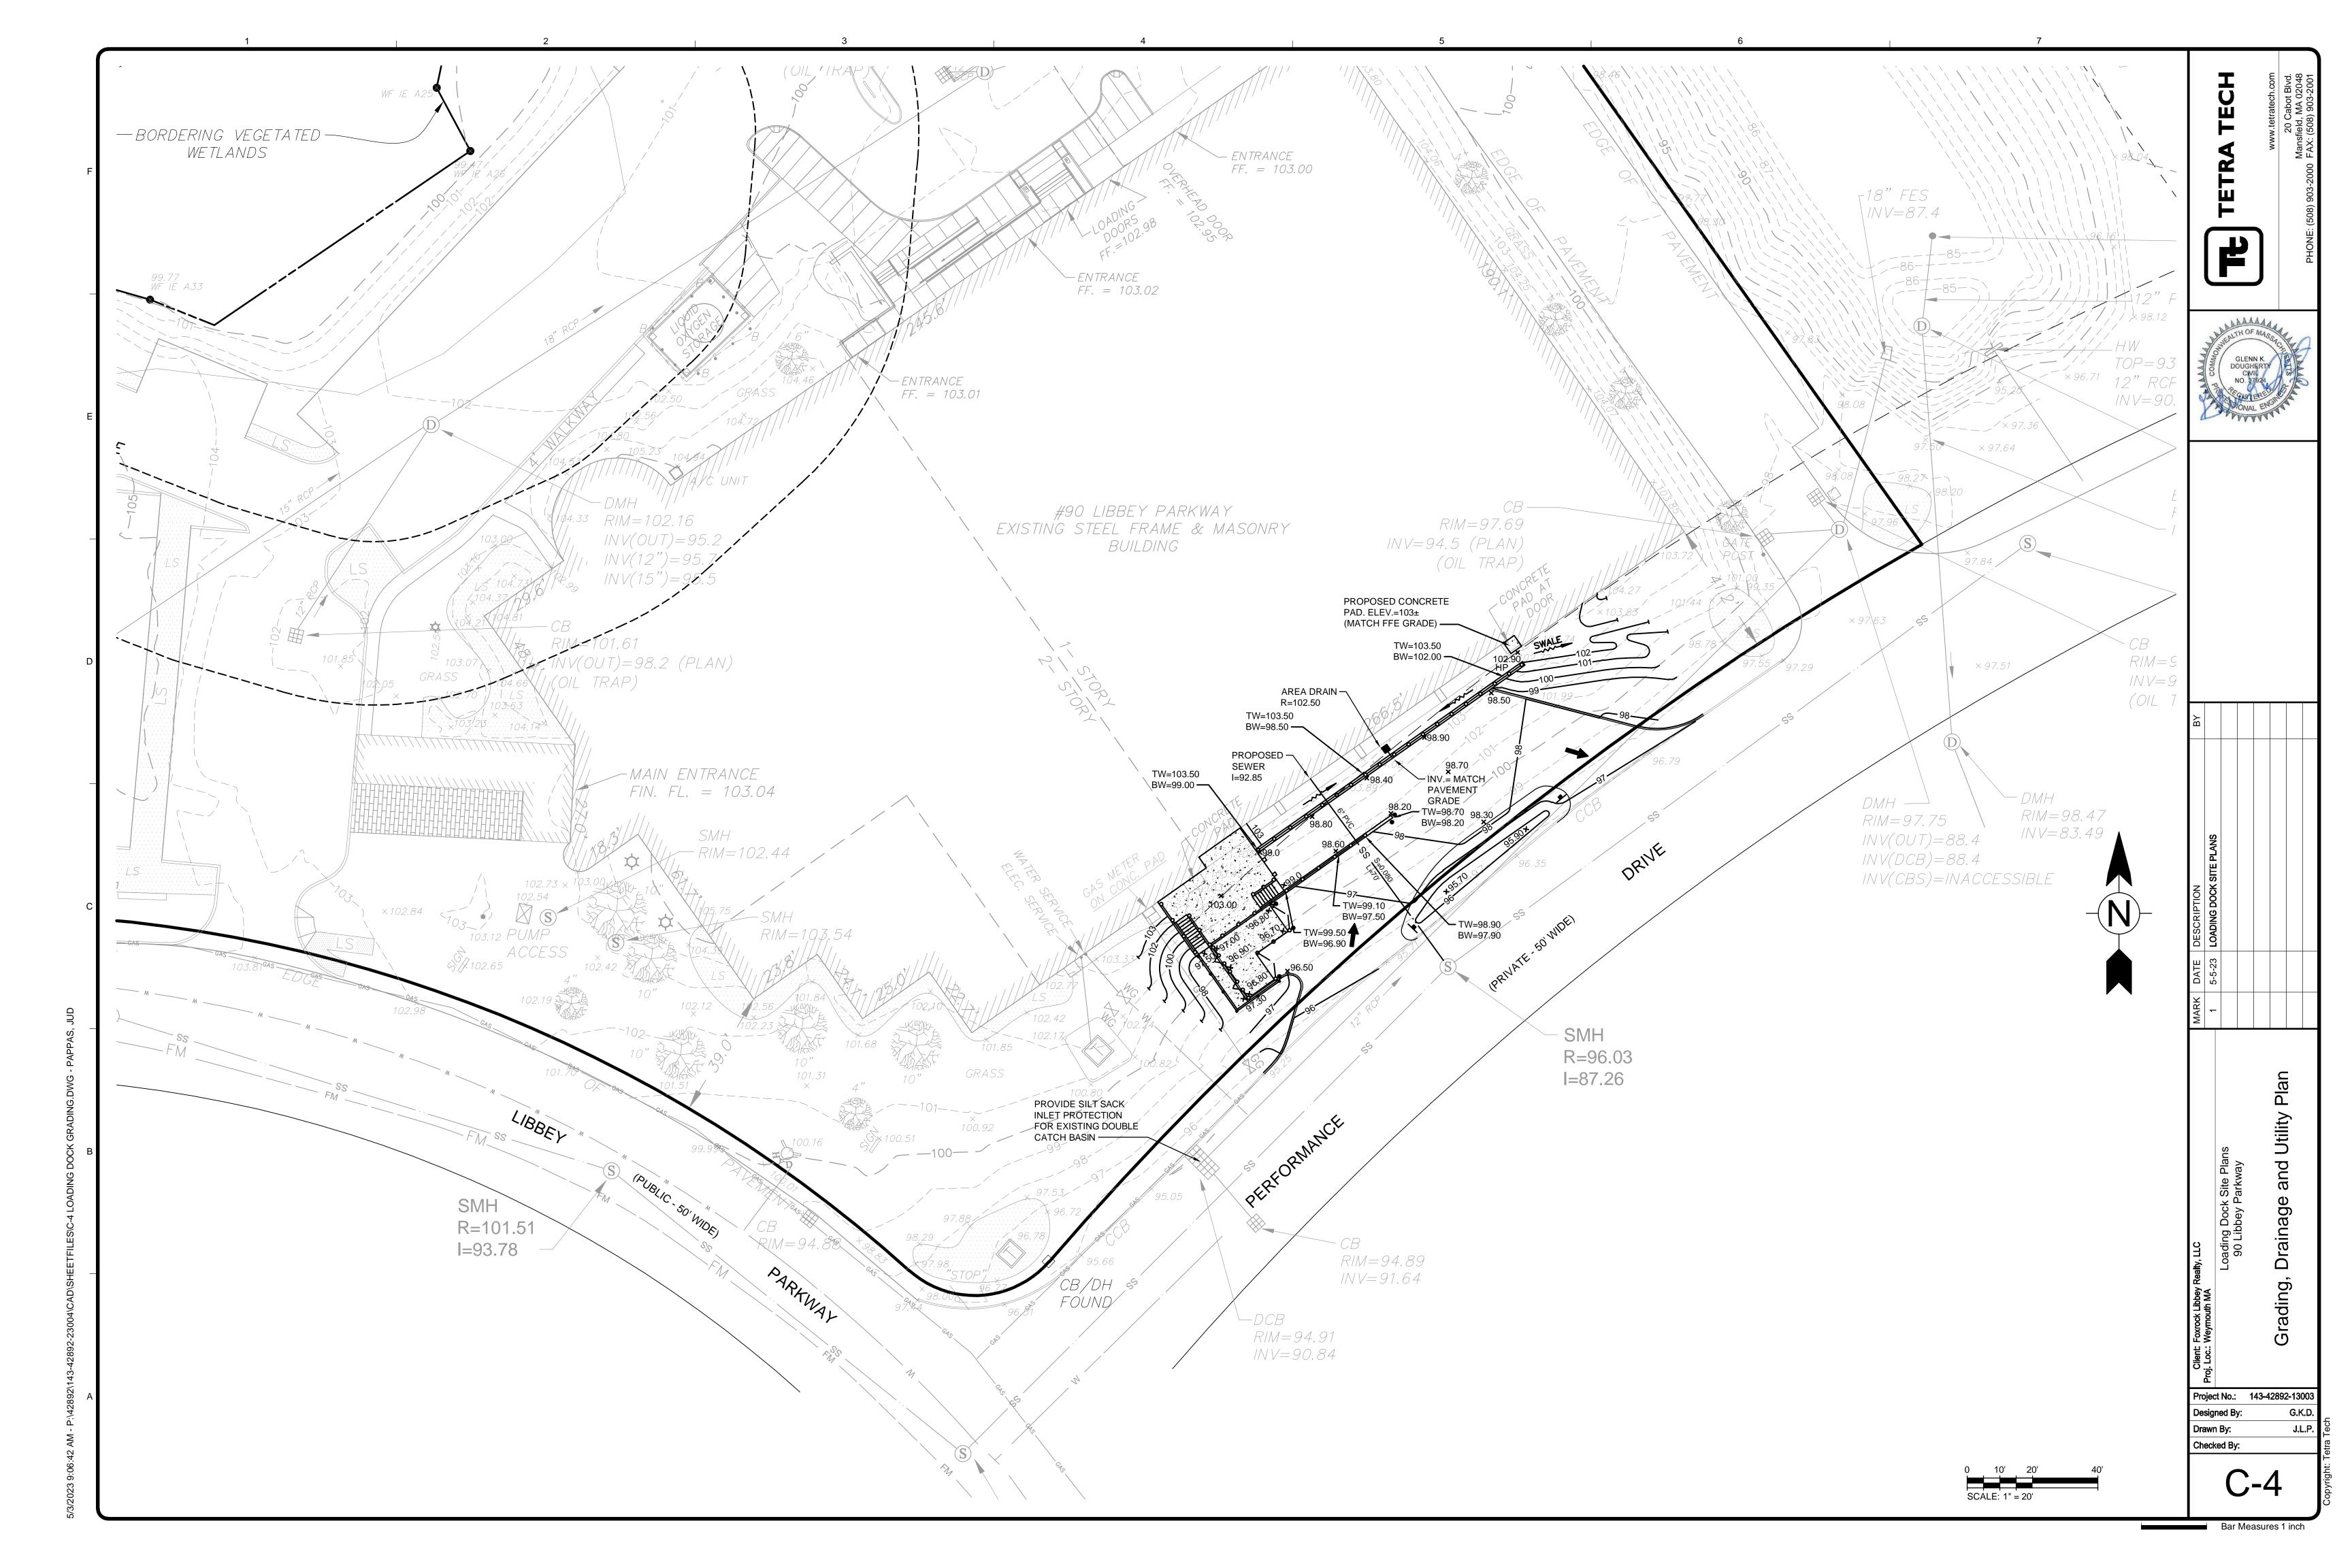

2) ALL CONSTRUCTION SHALL BE IN ACCORDANCE WITH THE WEYMOUTH SUBDIVISION REGULATIONS UNLESS OTHERWISE NOTED

3) THE MATERIAL OF PARKING PAVEMENT CONSTRUCTION AND CONSTRUCTION METHODOLOGIES SHALL BE IN ACCORDANCE WITH THE REQUIREMENTS OF THE TOWN OF WEYMOUTH AS STIPULATED IN THE RULES AND REGULATIONS RELATING TO THE SUBDIVISION OF LAND.

4) THE SEQUENCE OF ALL EXCAVATION OPERATIONS SHALL BE SUCH AS TO INSURE THE MOST EFFICIENT UTILIZATION OF EXISTING LEDGE EMBANKMENTS AND THE USE OF A MINIMUM AMOUNT OF BORROW. PRIOR TO ANY LEDGE REMOVAL, THE LEDGE AREA SHALL BE PARTIALLY OR COMPLETELY STRIPPED OF OVERBURDEN AS DIRECTED BY THE ENGINEER.

5) ALL SLOPES WHICH ARE 3 FT HORIZONTAL TO 1 FT VERTICAL OR FLATTER MAY BE GRASSED SLOPES. ALL SLOPES STEEPER THAN 3 FT HORIZONTAL TO 1 FT VERTICAL SHALL RECEIVE A SLOPE STABILIZATION GEOTEXTILE FABRIC (2:1) OR A RIP-RAP SLOPE TREATMENT (1:1) UNLESS OTHERWISE NOTED ON THE GRADING PLANS.

6) THE TOWN AND ALL UTILITY COMPANIES MUST BE NOTIFIED BY THE CONTRACTOR AT LEAST 48 HOURS PRIOR TO CONSTRUCTION. LOCATIONS OF EXISTING UTILITIES ARE APPROXIMATE ONLY AND ARE TO BE VERIFIED IN THE FIELD BY THE CONTRACTOR AT THE TIME OF CONSTRUCTION. ALL UNDERGROUND UTILITIES SHOWN WERE COMPILED ACCORDING TO AVAILABLE RECORD PLANS FROM THE VARIOUS UTILITY COMPANIES AND PUBLIC AGENCIES AND AREA APPROXIMATE ONLY. THE OWNER & TETRA TECH ASSUME NO RESPONSIBILITY FOR DAMAGE INCURRED AS A RESULT OF UTILITIES OMITTED OR INACCURATELY

WHILE WORKING IN THE VICINITY OF AN EXISTING UTILITY, REFER TO THE FOLLOWING: ALL UNDERGROUND UTILITIES SHOWN WERE COMPILED ACCORDING TO AVAILABLE RECORD PLANS FROM THE VARIOUS UTILITY COMPANIES AND PUBLIC AGENCIES AND ARE APPROXIMATE ONLY. SEE CHAPTER 370, ACTS OF 1963, MASSACHUSETTS GENERAL LAWS. WE ASSUME NO RESPONSIBILITY FOR DAMAGES INCURRED AS A RESULT OF UTILITIES OMITTED OR INACCURATELY SHOWN. BEFORE PLANNING FUTURE CONNECTIONS, THE APPROPRIATE PUBLIC ENGINEERING DEPARTMENT SHALL BE CONTACTED AND THE PROPOSED UTILITY WORK SHALL BE COORDINATED. DIG SAFE NUMBER; 1-888-344-7233.

8) THE CONTRACTOR SHALL GIVE TWENTY-FOUR (24) HOUR NOTICE TO PERTINENT TOWN DEPARTMENTS BEFORE COMMENCING ANY WORK.

9) ALL AREAS DISTURBED BY THE CONTRACTOR SHALL BE RESTORED TO EQUAL OR BETTER CONDITION. (SEE PLANTING AND EROSION CONTROL PLANS). ALL FINISHED SURFACES SHALL BE GRADED SMOOTHLY AND EVENLY.

10) AT THE COMPLETION OF THE CONTRACTOR'S OPERATION, THE CONTRACTOR SHALL BE RESPONSIBLE FOR CLEANING ALL DRAINAGE FACILITIES (NEW AND/OR EXISTING) OF DEBRIS. DRAINAGE SWALES AND STORMWATER BASINS SHALL BE CLEANED FOLLOWING CONSTRUCTION.

11) DO NOT SCALE PLANS. DUE TO REPROGRAPHIC STRETCH, PRINTS MAY NOT SCALE ACCURATELY.

12) FILL CONTAINING HAZARDOUS MATERIALS SHALL NOT BE USED.

13) LIMITS OF WORK SHALL BE MARKED IN THE FIELD PRIOR TO THE START OF CONSTRUCTION OR SITE CLÉARING.

14) THE CONTRACTOR SHALL BE RESPONSIBLE FOR MAINTAINING ADEQUATE RECORDS OF LOCATION AND ELÉVATION OF ALL WORK INSTALLED.

15) WATER PRESSURE REQUIREMENTS AND THE ACTUAL WATER PRESSURE TO BE PROVIDED AT THE

16) IT IS THE CONTRACTORS RESPONSIBILITY TO OBTAIN THE ELECTRONIC FILE FROM TETRA TECH FOR PROPER COORDINATION OF SURVEY LAYOUT.

17) THE CONTRACTOR MUST VERIFY EXISTING UTILITY LOCATIONS AS SHOWN ON THE DRAWINGS. REPORT DISCREPANCIES TO TETRA TECH AT (508) 903-2000.

18) CONTRACTOR MUST PAY ALL FEES AND PERMITS, INCLUDING BUT NOT LIMITED TO ANY BUILDING PERMIT FEES ASSOCIATED WITH RETAINING WALLS AND SITE FENCING.

19) ALL STORM DRAINS ARE 12" CORRUGATED HIGH-DENSITY POLYETHYLENE PIPE WITH SMOOTH

INTERIORS UNLESS OTHERWISE NOTED.


20) PROTECT ALL NEW AND EXISTING UTILITIES TO REMAIN DURING CONSTRUCTION.

21) CONTRACTOR IS RESPONSIBLE FOR COORDINATING WITH UTILITY COMPANIES.

22) THE CONTRACTOR MUST CONTACT THE APPROPRIATE UTILITY COMPANIES AND "DIGSAFE" (1-888-DIG-SAFE) AT LEAST 72 HOURS PRIOR TO ANY EXCAVATION WORK TO REQUEST EXACT FIELD LOCATION OF UTILITIES. NOTIFY THE ENGINEER OF ANY UTILITIES INTERFERING WITH THE PROPOSED

23) THE CONTRACTOR IS RESPONSIBLE FOR ESTABLISHING AND MAINTAINING ALL CONTROL POINTS AND BENCHMARKS NECESSARY FOR THE CONSTRUCTION OF THE PROJECT.

24) THE CONTRACTOR MUST CLEAN ALL NEW & EXISTING DRAINAGE STRUCTURES PRIOR TO PROJECT CLÓSEOUT.

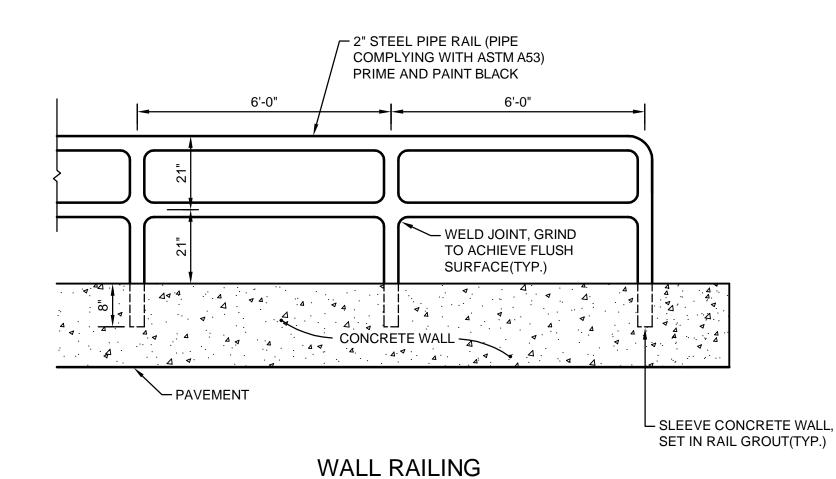

12" GRAVEL BASE — (M1.03.0 TYPE 'B') -PRECAST CONCRETE CURB BINDER COURSE -7 -FINISH GRADE TOP COURSE -CEMENT CONCRETE GRAVEL BASE M1.03.0 TYPE 'B' COMPACTED SUBGRADE-

CEMENT CONCRETE BACKING TO BE PROVIDED AT ALL JOINTS AND AT CURB MID SECTION FOR SPANS GREATER THAN 3 FEET. CONCRETE BACKING TO BE PLACED FROM BASE TO WITHIN 9 INCHES OF GRADE AND SPAN 1 FOOT AT JOINTS AND 1.5 FEET AT MID SECTION.

PRECAST CONCRETE CURB

NOT TO SCALE

SEE SITE PLAN

4" CONCRETE SLAB-

/X/X/X/

CEMENT CONCRETE WALK

NOT TO SCALE

SEE PLANS

REINFORCED CONCRETE SLAB (4000 PSI CONC.)

12" GRAVEL BORROW

BASE (M 1.03.0 C)

REINFORCED CONCRETE PAD

NOT TO SCALE

-COMPACTED SUB BASE

PAVEMENT SECTION

_ 2" MIN. COVER

COMPACTED SUBGRADE

CROSS SLOPE IS PREFERRED AT 1.5% AND SHALL NOT EXCEED 2.0%

-COMPACTED SUBGRADE

1" MINIMUM-

FINISH GRADE

8" GRAVEL

COMPACTED

BASE

- #4 BAR @ 12" E.W. TOP & BOTTOM

- SEE GEOTECHNICAL

REPORT FOR SUB BASE PREP

3" BIT. CONC. PAVEMENT

PLACED IN TWO LAYERS 1-1/2" TOP, 1-1/2" BINDER

·12" GRAVEL BASE COURSE

(MASS. HIGHWAY SPEC. M1.03.0 TYPE B GRAVEL BORROW)

COMPACTED TO 95%

COMPACTED TO 95%

MASS. HIGHWAY SPEC. TYPE I-1

- FINISH TO BE BRUSHED

BRISTLE BROOM FINISH-


6"x6"−#10 WIRE MESH —

CENTERED IN SLAB

3/4" CHAMFER ALL

FINISH GRADE

TOP EDGES -

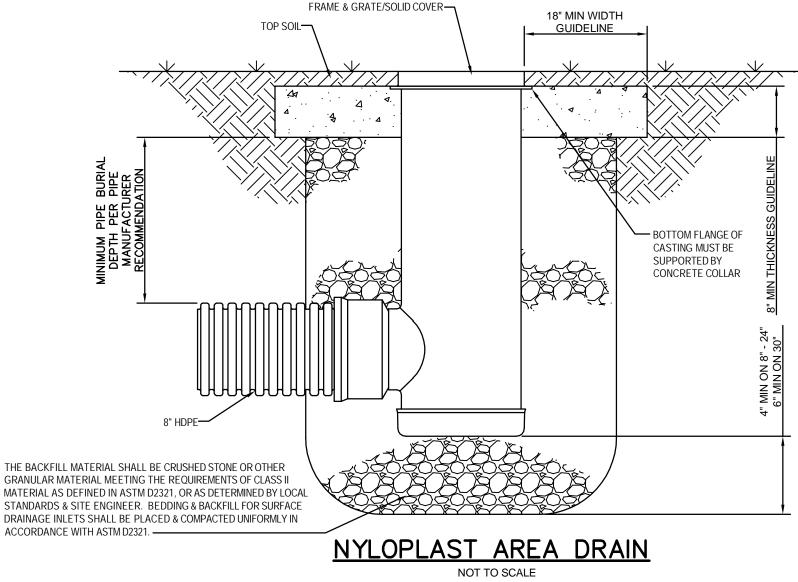

UNPAVED

PAVED

-1-1/2" CROWN -6" DIA. STEEL PIPE (CONCRETE FILLED) POST TO BE COVERED WITH YELLOW VINYL SLEEVE -FINISH GRADE 1" WASH-MIN. 3000 PSI-CONCRETE BASE

CONCRETE FILLED STEEL BOLLARD NOT TO SCALE

SEE SPECIFICATIONS -FOR FINISH GRADE EXISTING GRADE - PAVEMENT AND SUBBASE MATERIAL AS SPECIFIED COMMON FILL MATERIAL TO BE COMPACTED AS SPECIFIED — COMMON FILL MATERIAL TO BE COMPACTED AS SPECIFIED, NO STONES LARGER THAN 6" PERMITTED IN THIS AREA COMPACTED BEDDING MATERIAL TABLE NO. 1 PIPE SIZE (IN.) `A' (FT.) 8-12 0.7 15-18 8.0 36-48 1.5 12" MINIMUM (SEE NOTE 2) 48-72 2.0 SEWER OR DRAIN PIPE - COMPACTED CRUSHED STONE A.S.T.M. DESIGNATION D448 (MASS. 6" MINIMUM IN ROCK — STANDARD M2.01.4) PLACED AGAINST UNDISTURBED SIDES AND BOTTOM OF TRENCH. (SEE NOTE 2) - `A' MINIMUM, SEE TABLE 1, COMPACTED BEDDING MATERIAL UNDISTURBED EARTH EXCAVATION IN LEDGE **EXCAVATION IN EARTH**


NOTES:

- SHEETING, WHEN REQUIRED, TO BE CUT OFF AT LEAST 5 FEET BELOW STREET AND A MINIMUM OF 1 FOOT ABOVE TOP OF PIPE. WOOD SHEETING DRIVEN BELOW MID-DIAMETER OF THE PIPE SHALL BE LEFT IN PLACE. STEEL SHEETING DRIVEN BELOW MID-DIAMETER MAY BE WITHDRAWN IF APPROVED IN WRITING BY THE ENGINEER. FOR PVC PIPE ALL SHEETING DRIVEN BELOW MID-DIAMETER SHALL BE
- 2. WHEN APPROVED BY THE ENGINEER FOR PIPES OTHER THAN PVC SELECTED GRAVEL FILL MATERIAL MAY BE USED FROM MID-DIAMETER OF PIPE TO 12" ABOVE TOP OF PIPE. NO STONES LARGER THAN 2 INCHES IN ANY DIMENSION WILL BE PERMITTED IN THIS AREA - MASSACHUSETTS STATE MATERIAL STANDARD M1.03.0 TYPE C.
- 3. TRENCHES LOCATED ON THE ROAD SHOULDER SHALL BE TREATED THE SAME EXCEPT FOR PAVING.
- PROVIDE AT LEAST ONE IMPERVIOUS DAM IN GRAVEL BEDDING BETWEEN EACH MANHOLE WHERE DIRECTED, OR EVERY 300 FEET, WHICHEVER IS LESS.
- BEDDING MATERIAL FOR PVC PIPE SHALL MEET THE REQUIREMENTS OF ASTM D2321 CLASS I OR CLASS II EMBEDMENT MATERIALS.

SEWER AND DRAIN TRENCH


NOT TO SCALE

(PVC OR RCP)

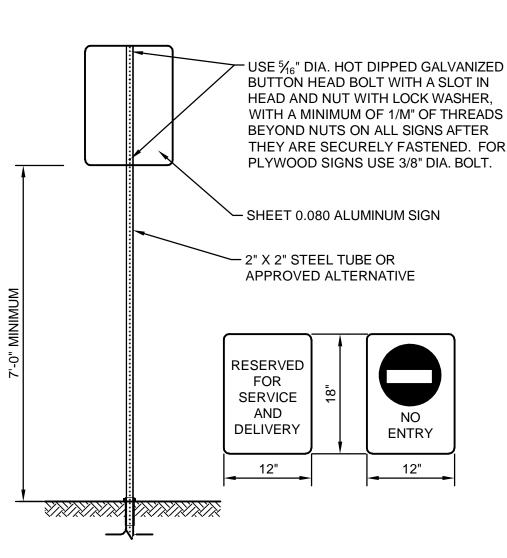

SIGN INSTALLATION

NOT TO SCALE

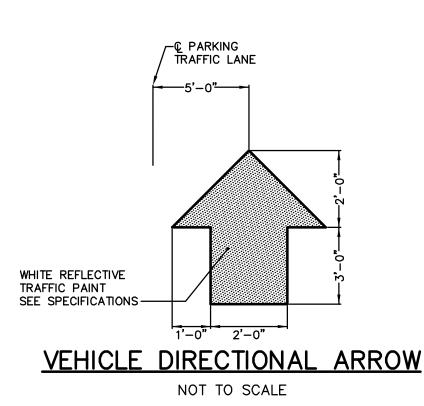



Sheet etail Project No.: 143-42892-13003

G.K.D. Designed By: Drawn By: J.L.P.


Checked By:

Bar Measures 1 inch

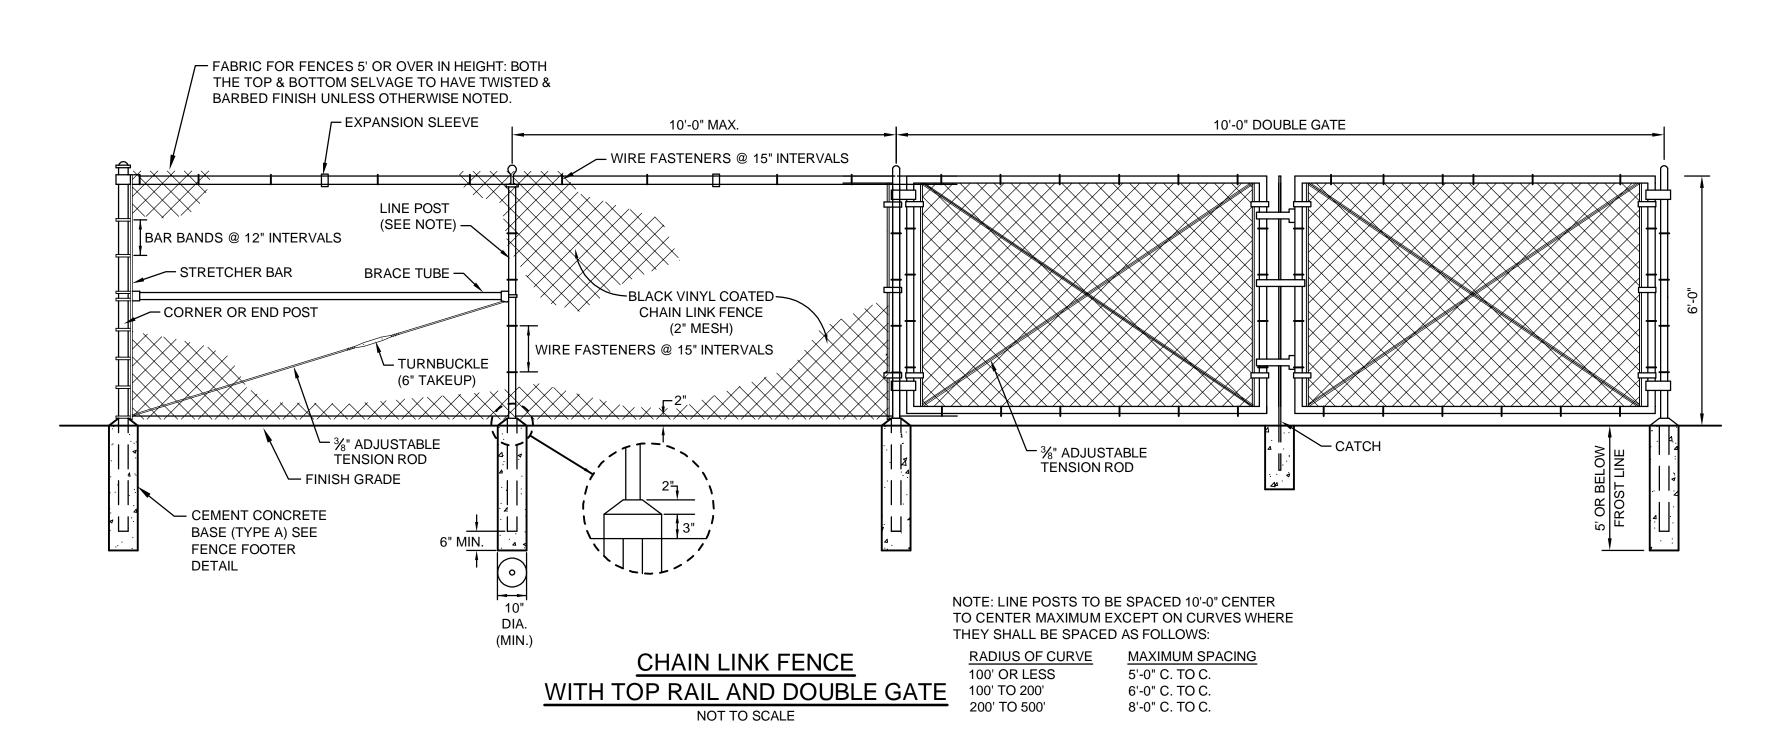


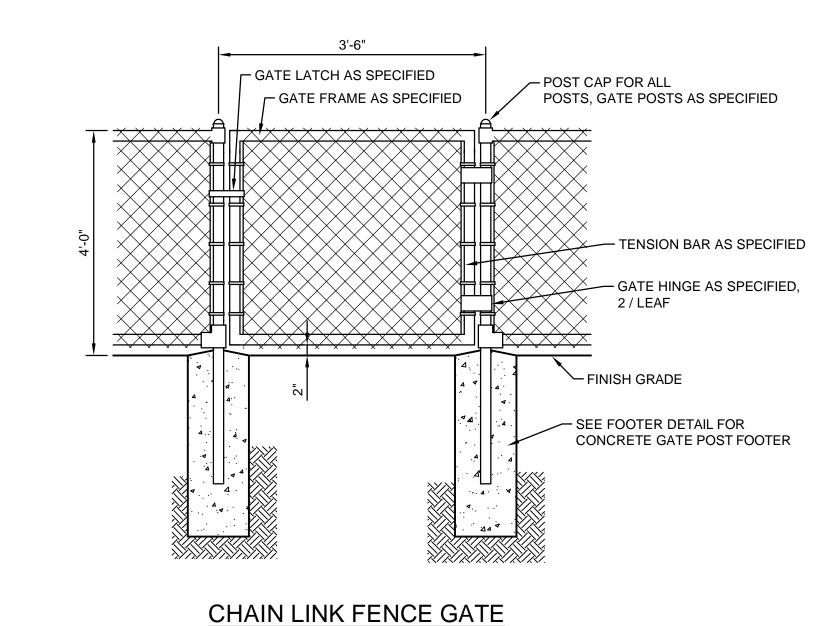

NOT TO SCALE

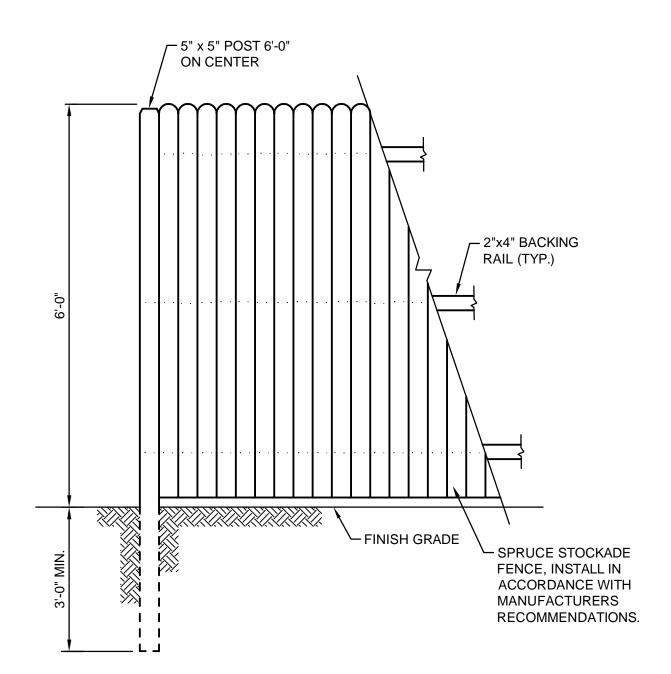

SPRUCE STOCKADE FENCE NOT TO SCALE

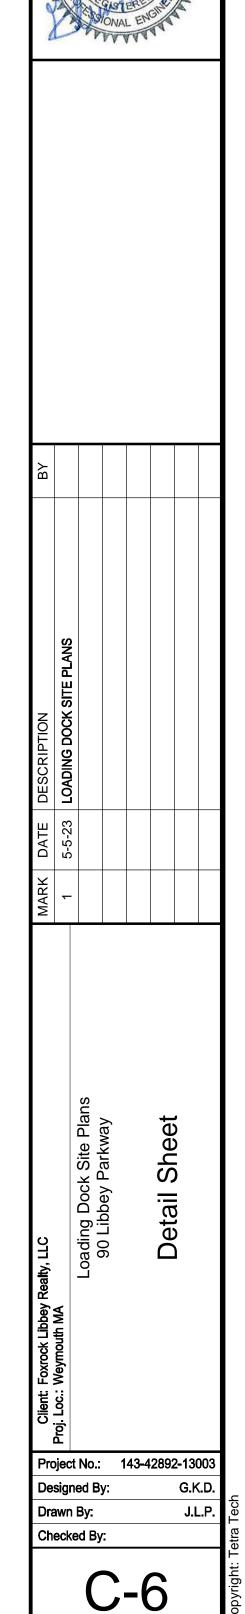

Bar Measures 1 inch

PLANT SCHEDULE - SHEET L3.01

DECIDUOUS TREES

QTY	KEY	BOTANICAL NAME	COMMON NAME	SIZE	ROOT	NOTES
1	AF	ACER X FREEMAN 'JEFFERSRED'	AUTUMN BLAZE FREEMAN MAPLE	2"- 2.5" CAL.	BALL & BURLAP	25' O.C. (N)

DECIDUOUS SHRUBS

16	CA	CEANOTHUS AMERICANUS	NEW JERSEY TEA	18"-24" HT.	#3 CONT.	3' O.C.	(N)
9	CS	CORNUS (SWIDA) SERICEA 'ARCTIC FIRE'	ARCTIC FIRE RED OSIER DOGWOOD	24"-30" HT.	#5 CONT.	5' O.C.	(N)
5	RA	RHUS AROMATICA 'GRO-LOW'	GRO-LOW FRAGRANT SUMAC	18"-24" HT.	#3 CONT.	4' O.C.	(N)
10	VD	VIBURNUM DENTATUM 'CHRISTOM"	BLUE MUFFIN VIBURNUM	24"-30" HT.	#5 CONT.	5' O.C.	(N)

PERENNIALS


8	MS	MISCANTHUS SINENSIS 'ADAGIO'	ADAGIO MAIDEN GRASS	18"-24" HT.	#3 CONT.	3' O.C.


TURF

3,475	SF	SEED LAWN; GENERAL; TALL FESCUE BLUE SEED MIX	SUMMIT SEED, ROCKFORD, WA; 800.457.6748 (N
347	SF	ERNST DETENTION BASIN SPECIAL MIX; ERMNX #126	ERNST SEEDS, MEADVILLE, PA; 800.873.3321 (N


O.C. = ON-CENTER SPACING (N) = NATIVE SPECIES

SECTION

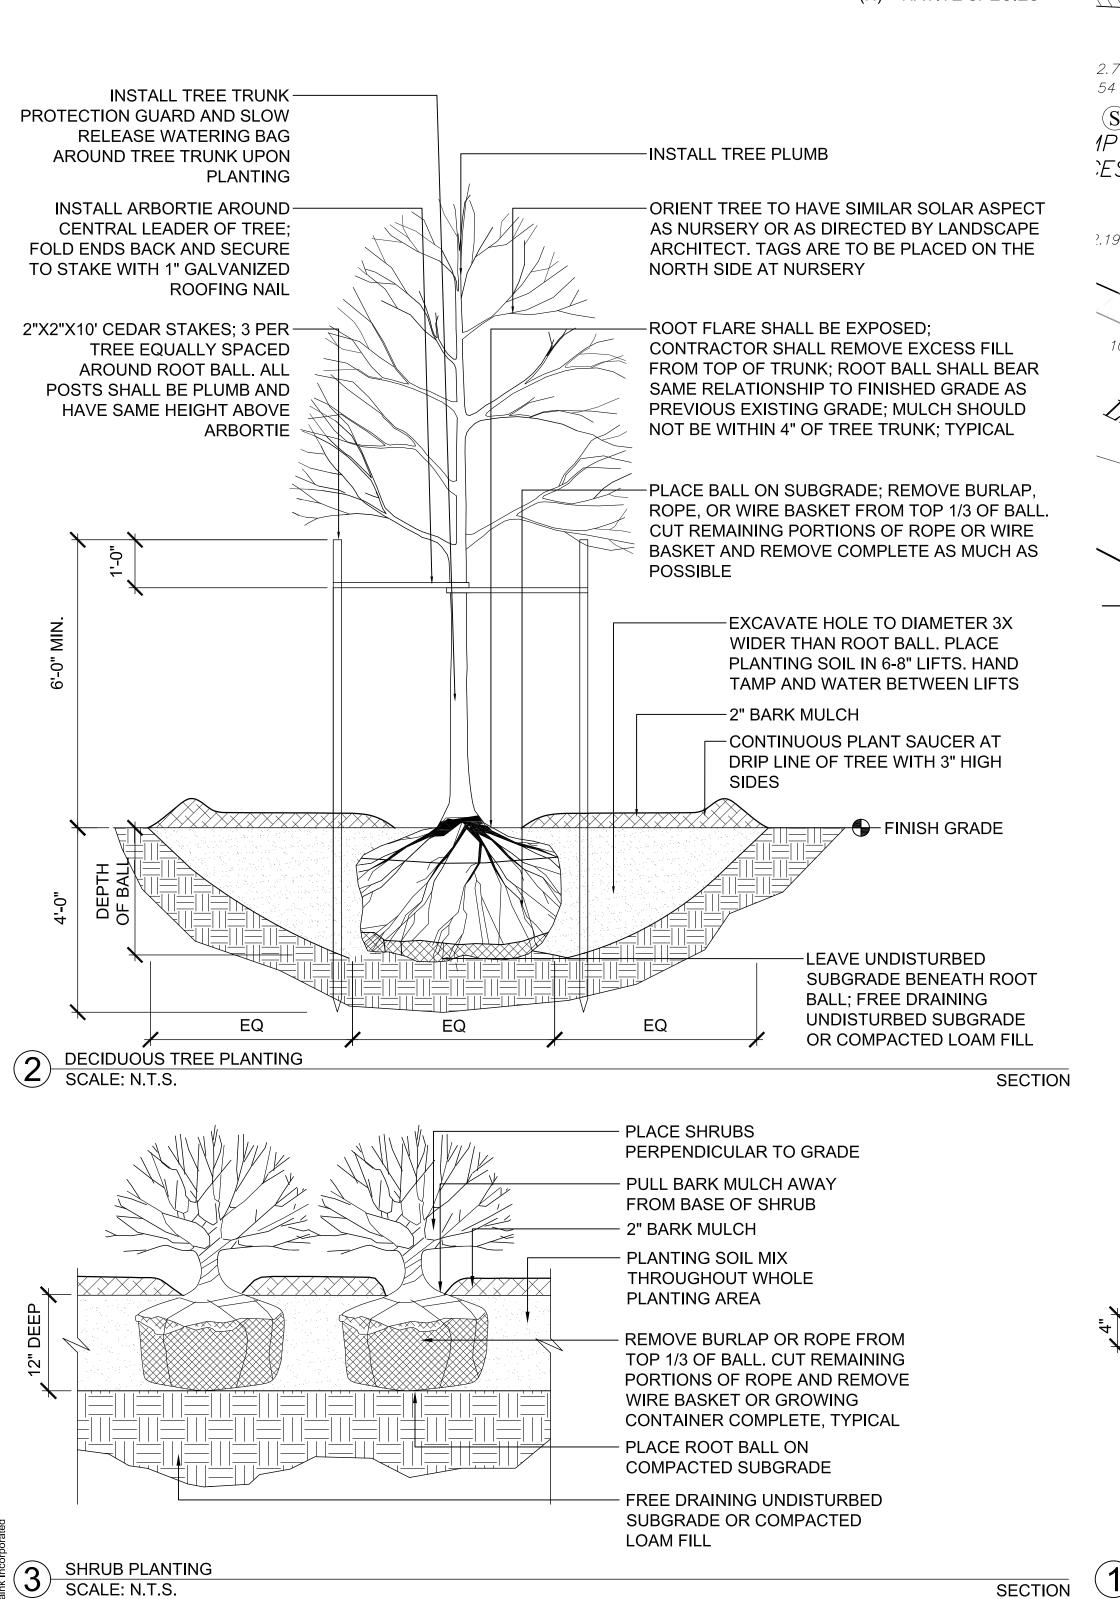

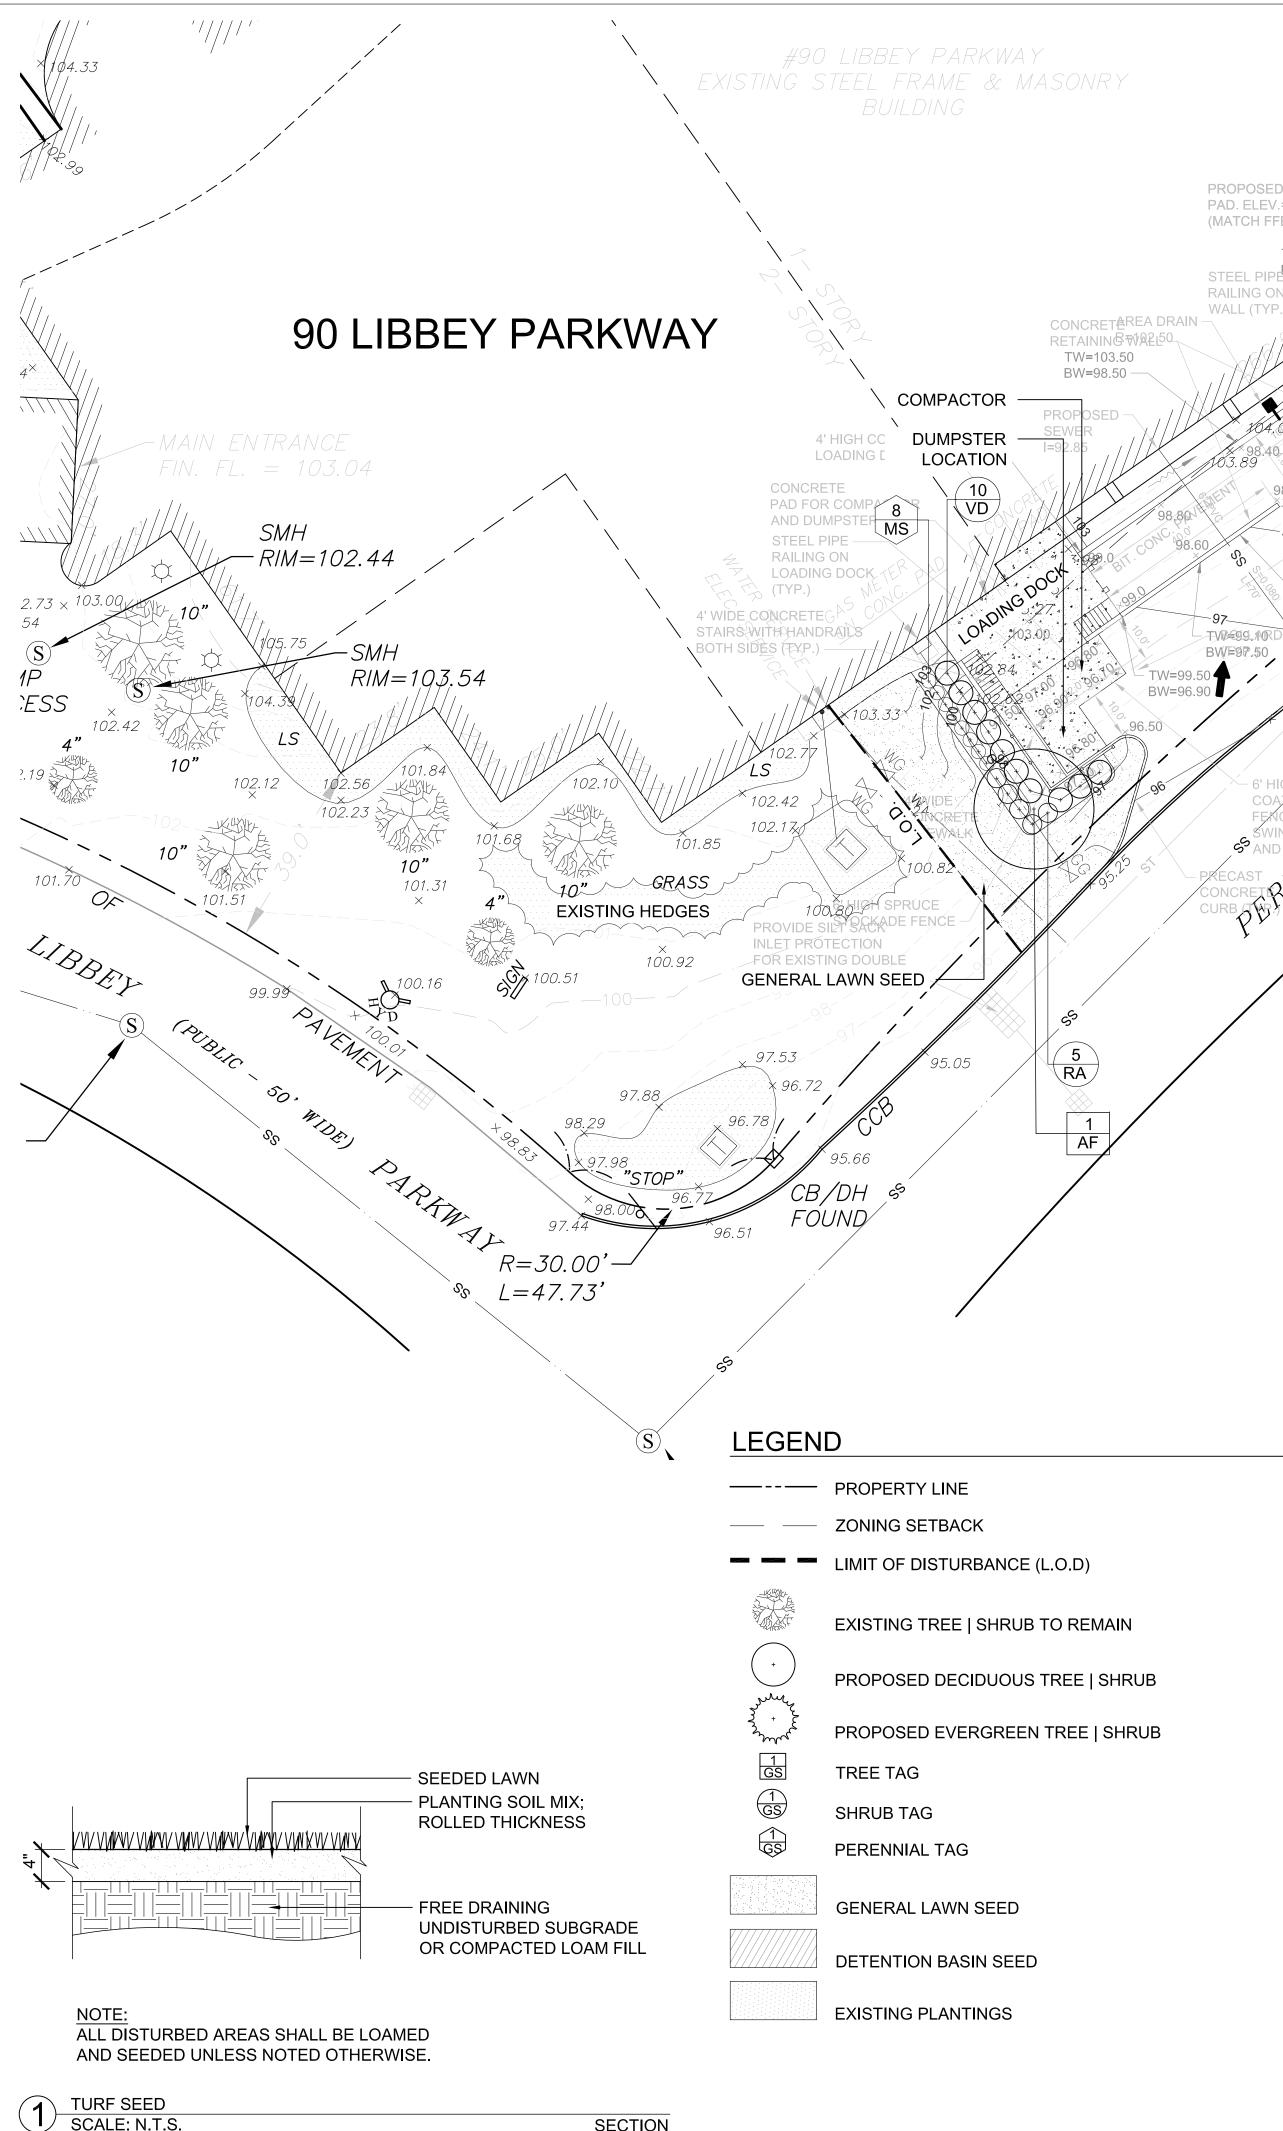

SECTION

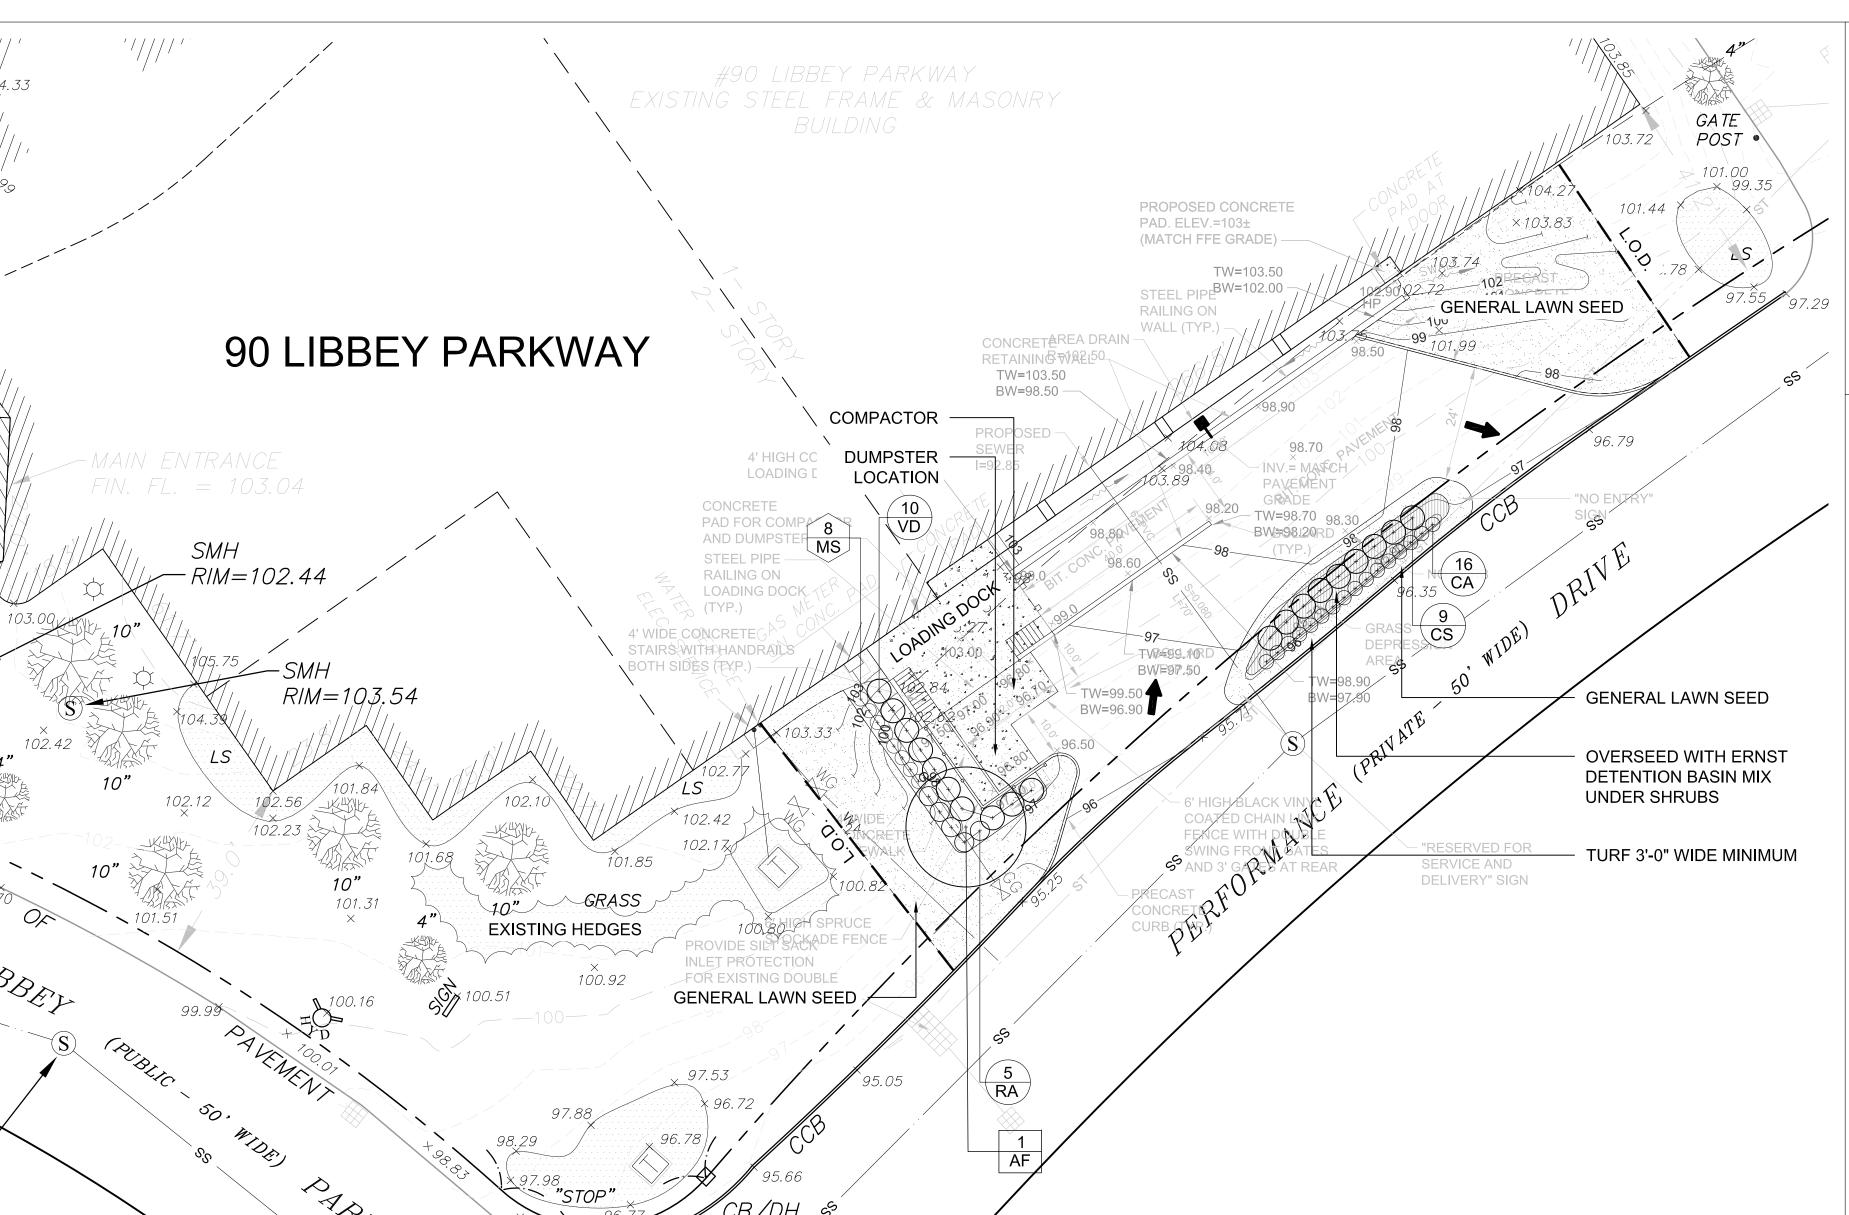

PLANTING PLAN NOTES:

1. ALL PLANTING SOILS SHALL BE (1) PART TOPSOIL, (1) PART COMPOSTED ORGANIC MATTER, (1) PART NATIVE SOIL MIXED PRIOR TO PLANTING INSTALLATION.

2. THE CONTRACTOR SHALL CONFIRM THE ACTUAL DEPTH OF ALL PLANTING AREAS PRIOR TO ANY PLANT MATERIAL BEING REPORT ANY LEDGE OR SUBSTANDARD SOIL/SUBSURFACE CONDITIONS TO THE OWNER'S REPRESENTATIVE

3. THE CONTRACTOR SHALL CONSIDER THE DISPLACEMENT OF PLANTING SOIL FOR THE PLANT MATERIAL ROOT BALLS IN THE OVERALL PLANTING BED FINISHED GRADE. ALLOW ENOUGH ROOM IN THE PLANTING BED ELEVATION TO SPREAD DISPLACED SOIL AND STILL MEET THE INDICATED FINISHED GRADE INCLUDING THE 2" OF HARDWOOD MULCH.

4. ANY MATERIALS ACCUMULATED OVER THE ROOT FLARE OF A TREE OR SHRUB MUST BE REMOVED COMPLETELY UNTIL THE ROOT FLARE IS EXPOSED AND ALL GIRDLING ROOTS REMOVED PRIOR TO PLANTING.

5. THE CONTRACTOR SHALL LOCATE AND VERIFY WITH THE OWNER'S REPRESENTATIVE ALL TREES, SHRUBS, PERENNIALS, AND/OR GROUNDCOVER TO REMAIN, TO BE REMOVED, OR TO BE TRANSPLANTED. PROTECT IN PLACE ALL EXISTING TREES, SHRUBS, AND GROUNDCOVER TO REMAIN

6. ALL NEW PLANTING MATERIAL SHALL CONFORM TO MINIMUM GUIDELINES ESTABLISHED BY THE AMERICAN STANDARD FOR NURSERY STOCK PUBLISHED BY THE AMERICAN ASSOCIATION OF NURSERYMEN, INC. (AAN). IN ADDITION, ALL NEW PLANT MATERIAL FOR THE PROJECT SHALL BE OF SPECIMEN QUALITY AND THE PLANT HEIGHT SHALL BE MEASURED FROM THE ROOT FLARE, NOT THE BOTTOM OF POT OR BURLAP BALL

7. STAKE THE LOCATION OF ALL PROPOSED PLANTING FOR APPROVAL BY THE OWNER'S REPRESENTATIVE PRIOR TO THE COMMENCEMENT OF PLANTING.

8. IN THE EVENT THAT QUANTITY DISCREPANCIES OR MATERIAL OMISSIONS OCCUR BETWEEN THE PLANT MATERIALS LIST AND THE DRAWINGS, THE HIGHER NUMBER OF PLANTS SHALL GOVERN. THE CONTRACTOR SHALL REPORT DISCREPANCIES TO THE OWNER'S REPRESENTATIVE.

9. ANY PROPOSED SUBSTITUTIONS OF PLANT SPECIES SHALL BE MADE WITH PLANTS OF EQUIVALENT OVERALL FORM, HEIGHT, BRANCHING HABIT, FLOWER, LEAF, FRUIT, COLOR, AND CULTURE MUST BE APPROVED BY THE OWNER'S REPRESENTATIVE.

10. ALL LAWN AREAS DISTURBED BY CONSTRUCTION OPERATIONS

INSIDE AND OUTSIDE THE LIMIT OF WORK SHALL BE LOAMED AND

SEEDED.



PREPARED BY:

LANDSCAPE ARCHITECT

Terraink, Inc

7 Central Street Suite 150 Arlington, MA 02476

ENGINEER Tetra Tech


Phone 781.316.1595

20 Cabot Boulevard Suite 305 Mansfield, MA 02048 Phone 508.903.2001

DEVELOPER

FoxRock Properties P.O. Box 690528 Quincy, MA 02269 Phone 781.752.6357

Comment

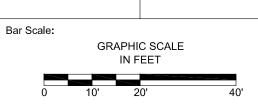

NORTH


90 LIBBEY PARKWAY WEYMOUTH, MA

SCREEN -**PLANTING**

Project # 23007 Drawn By: AR 1" = 20'-0" Checked By: JC | KAC

Sheet Number:

L3.01

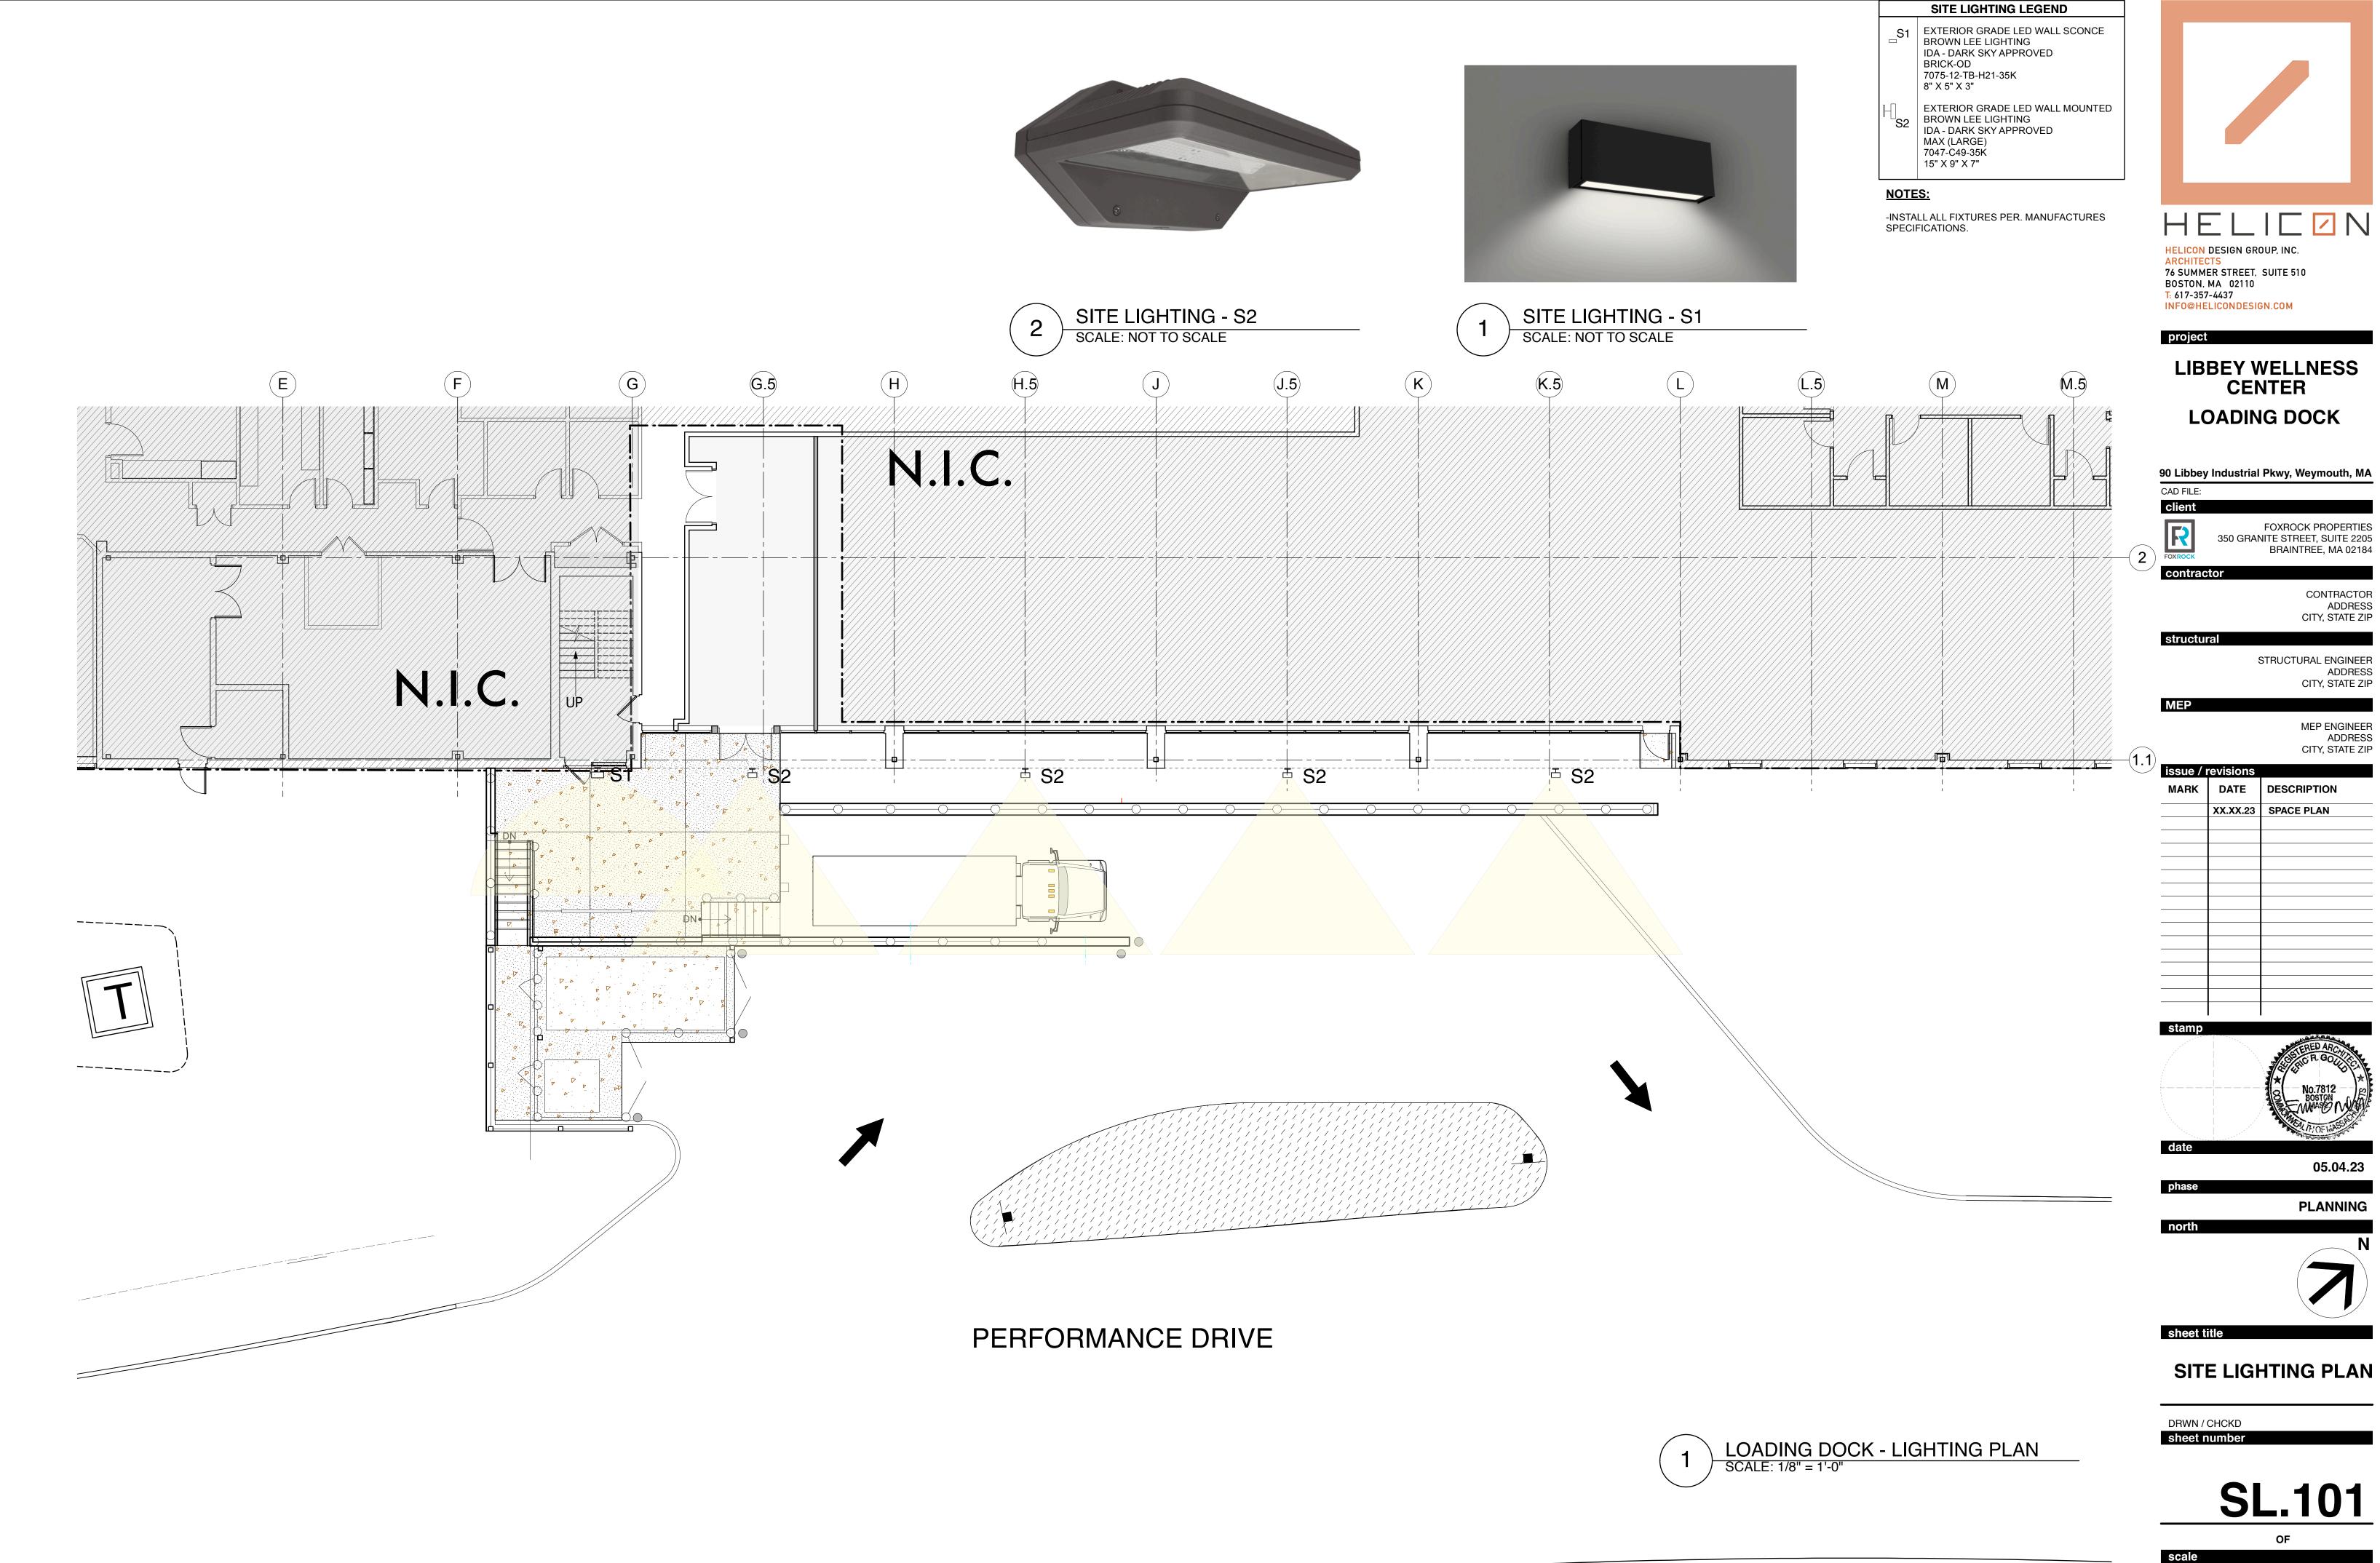

LIBBEY WELLNESS **CENTER**

90 Libbey Industrial Pkwy, Weymouth, MA

FOXROCK PROPERTIES 350 GRANITE STREET, SUITE 2205 BRAINTREE, MA 02184

CONTRACTOR ADDRESS CITY, STATE ZIP

ADDRESS CITY, STATE ZIP

MEP ENGINEER

ADDRESS CITY, STATE ZIP

MARK DATE DESCRIPTION XX.XX.23 SPACE PLAN



SL.101

AS NOTED