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### **APPLICANT**:

ELKSY DEVELOPMENT LLC **180 CANTON AVENUE** MILTON, MA 02186

### SURVEYOR / ENGINEER :



CROCKER DESIGN GROUP, LLC 2 SHARP STREET, UNIT A Design HINGHAM, MA 02043 **Group** PHONE: (781) 919-0808






# SITE PLAN APPLICATION

# CORNERSTONE AT WEYMOUTH FOR

# ELKSY DEVELOPMENT LLC

-MAP 35 BLOCK 447 LOT 3 (1197 WASHINGTON STREET) -MAP 35 BLOCK 447 LOT 1 (1215 WASHINGTON STREET)

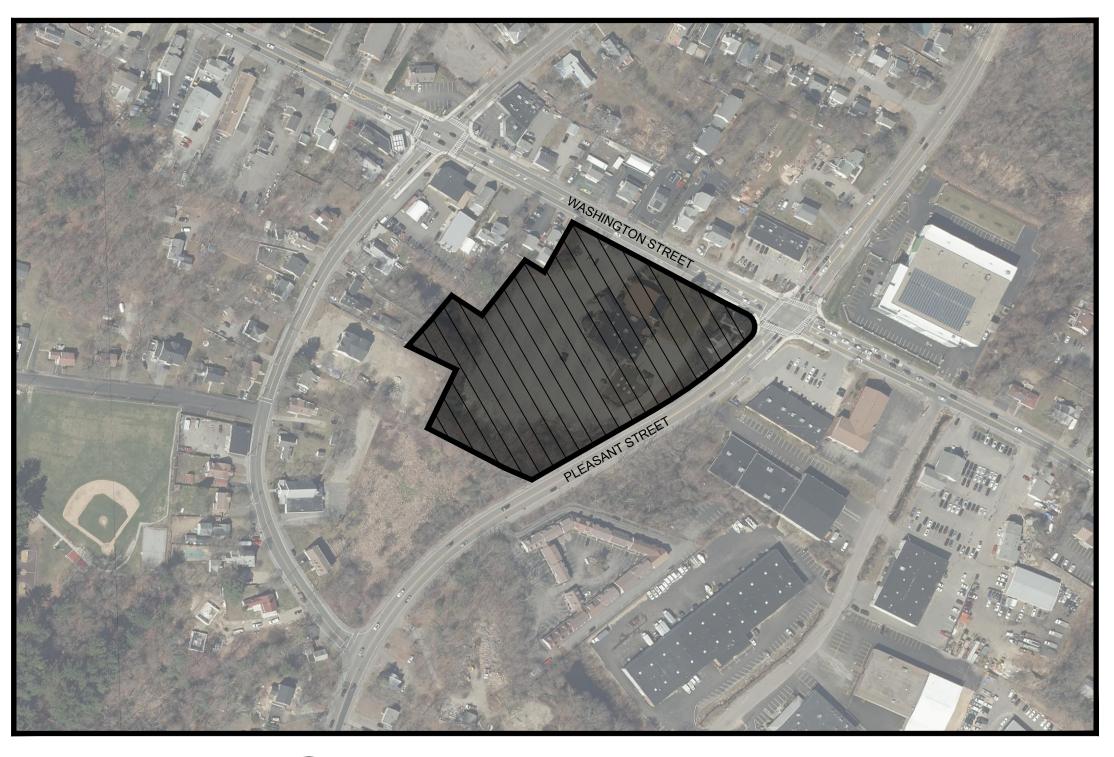



MEYER ARCHITECTS, INC. 227 EAST LANCASTER AVENUE ARDMORE, PA 19003-2304 MEYER PHONE: (610) 649-8500

### LANDSCAPE ARHITECT:

LONGSTONE GARDENS 1905 MILLERSVILLE PIKE LANCASTER, PA 17603 PHONE: (267) 664-6336

# REAL ESTATE COUNSEL:

DROHAN TOCCHIO & MORGAN PC 175 DERBY ST., SUITE 30 HINGHAM, MA 02043 781-749-7200

# DRAWING INDEX:

NORTH

200 100

C-0	COVER SHEET
C-1	DEMOLITION - SEDIMENT & EROSI
	CONTROL PLAN
C-2	LAYOUT PLAN
C-3.1	GRADING PLAN
C-3.2	DRAINAGE PLAN
C-4	UTILITIES PLAN
C-5	VEHICLE TURNING PLAN EXHIBIT
C-6.1	DETAIL SHEET (1 OF 3)
C-6.2	DETAIL SHEET (2 OF 3)
C-6.3	DETAIL SHEET (3 OF 3)

AERIAL LOCUS MAP SCALE: 1' = 200' 200 400

# SUPPLEMENTAL PLANS:

& EROSION


EXISTING CONDITIONS PLAN (SHEET 1 OF 1) LANDSCAPE PLAN (LA-1) LIGHTING PLAN (LA-2)

Auchalia B - 12 - 2022 GABRIEL R. CROCKER CIVIL No. 47917 GABRIEL R. CROCKER PROFESSIONAL ENGINEER, MA REGISTRATION #47917
Crocker Design Group 2 SHARP STREET, UNIT A HINGHAM, MA 02043 P: 781–919–0808
Project CORNERSTONE AT WEYMOUTH #1197 WASHINGTON STREET WEYMOUTH, MA
Prepared for ELKSY DEVELOPMENT LLC #180 CANTON AVENUE MILTON, MA 02186
Drawing Title
Project No. 100-142 Drawing No.
Date 7-1-2022
Scale C-O
Drawn By ASZ
Approved By GC


8.12.22 REV. PER ZBA/CON COMM COMMENTS

Description

Date

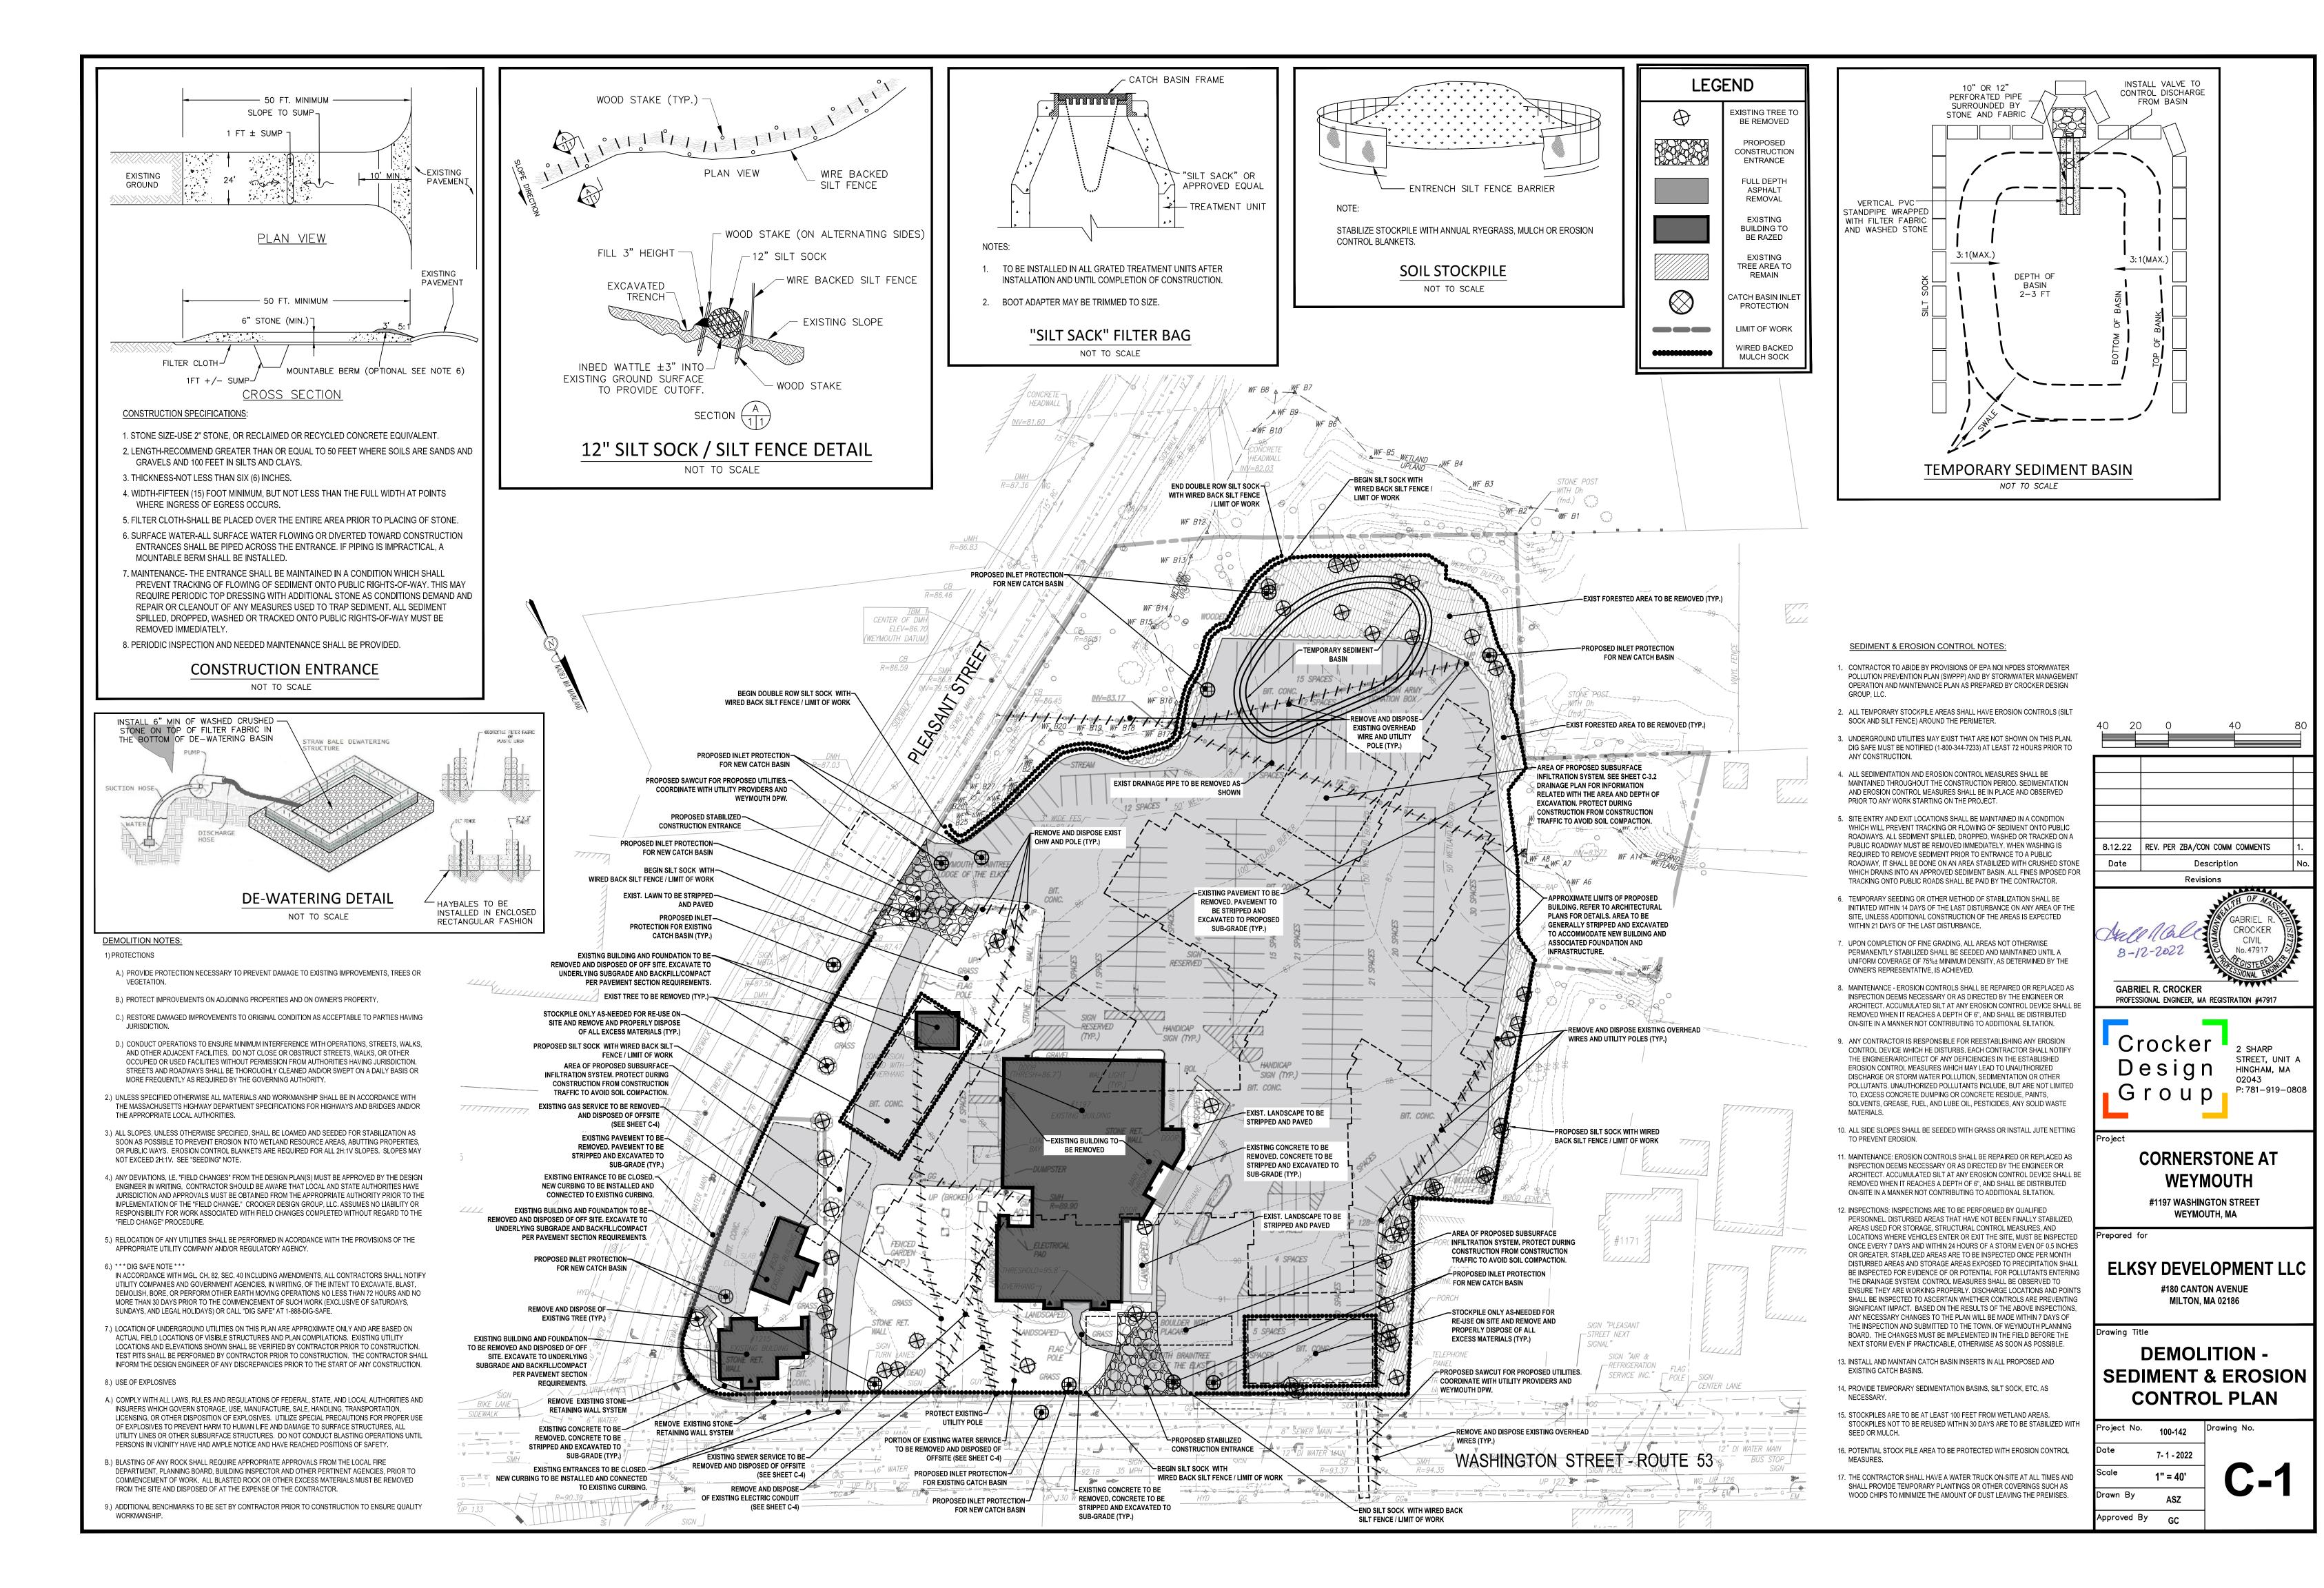



DIMENSIONAL CRITERIA	REQUIRED	EXISTING	EXISTING	PROPOSED	
PER CCOD BYLAWS VII B		MAP 35 BLOCK 447 LOT 1 MULTI-FAMILY RESIDENTIAL	MAP 35 BLOCK 447 LOT 3 PRIVATE CLUB/ LODGE	MIXED USE-SENIOR LIVING FACILITY MIXED USE-SENIOR LIVING	
MINIMUM LOT AREA (SF)	30,000 SF (0.68 AC)	11,415 SF (0.26 AC)	198,041 SF (4.54 AC)	209,456 SF (4.81 AC)	4
	N/A	87.05' (WASHINGTON ST.) 168.89' (PLEASANT ST.)	351.61' (WASHINGTON ST.) 404.99' (PLEASANT ST.)	438.66' (WASHINGTON ST.) 573.88' (PLEASANT ST.)	
IAX IMPERVIOUS (%) IINIMUM FRONT YARD (FT) EXCLUDING PROJECTIONS)	75% MIN 25'	73.5% (+/- 8,400 SF) 5.3' (WASHINGTON ST.) 21.1' (PLEASANT ST.)	61.3% (+/- 121,400 SF) 51.9' (WASHINGTON ST.) 108.5' (PLEASANT ST.)	60.1% (+/- 127,371 SF) 55.5' (WASHINGTON ST.) 85.6' (PLEASANT ST.) >5' (LANDSCAPE FEATURE TO	
INIMUM SIDE YARD (FT) EXCLUDING PROJECTIONS)	10' 20' (NO BUILD BUFFER)	4.7' (TO WEST) 59.27' (TO SOUTH)	119.2' (TO WEST) 312.5' (TO SOUTH)	WASHINGTON ST. & PLEASANT ST.) 20' (TO WEST) 99.1' (TO SOUTH)	
IINIMUM REAR YARD (FT) EXCLUDING PROJECTIONS) MAX. BLDG. HEIGHT	15' 3 STORIES, 40' MAX	N/A	N/A	N/A 3 STORIES, ≼40' TO ROOF	CENTER ELET (WEYMOUTH
EXCLUDING PROJECTIONS) EXCLUDING SUPERSTRUCTURES)	3 STORIES, 35' MAX (WITHIN 45' OF ABUTTING RESIDENTIAL USE)	2 STORIES,<40'	2 STORIES,<40'	3 STORIES, LESS THAN 35' WITHIN 45' OF ABUTTING RESIDENTIAL USE	[//////////////////////////////////////
IAX. BLDG. COVERAGE	60%	26.3% (±2,670 SF) ±0.27 (GFA=3,085 SF)	6.4% (±12,750 SF)	26.3% (±55,073 SF) 0.50 (GFA=104,728 sf)	
IIN OPEN SPACE	15%	31.6% (±3,614 SF)	37.6% (±74,440 SF)	39.8% (±83,456 SF)	- /
PARKING PARKING SETBACK	USE DEPENDENT 5' ALONG FRONTAGE	±8 SPACES ±5' ALONG PLEASANT	±247 SPACES 23' ALONG PLEASANT ST	133 SPACES 5.0' ALONG PLEASANT ST	
	20' BUFFER (ABUTTING RESIDENTIAL USE)	ST FRONTAGE	0' ALONG WASHINGTON ST 8' BUFFER (ABUTTING RES USE)	5.0' ALONG WASHINGTON ST 20.0' BUFFER (ABUTTING RES USE)	EXIST T
GENERAL NOTES:	1		1	1	]
1. THIS PLAN REFERENCES A ENTITLED EXISTING CONDITIO		BY CDG			ENHANCED BUF RESTORATION (
2. ACCESSIBLE CURB RAMPS	SHALL BE PER THE MASS			Δ	L'ANDŚCAPE PL
ARCHITECTURAL ACCESS BO DISABILITIES ACT (ADA) ACC		ICANS WITH			
3. THE FOLLOWING LAYOUT C OTHERWISE NOTED ON THE F DIMENSIONS ARE TO FACE C	PLAN:	JNLESS		K p	FLUSH WITH PVMN
DIMENSIONS ARE TO THE CE ALL TIES TO PROPERTY LINE	NTER OF PAVEMENT MARKI				
PROPERTY LINE UNLESS OTH 4. ALL LINES AND DIMENSION	NS ARE PARALLEL OR PERF				SAW-CUT LINE
TO THE LINES FROM WHICH OTHERWISE INDICATED.					
5. CONTRACTOR SHALL REPO OWNER OR HIS REPRESENTA		5 TO THE			
6. THE CONTRACTOR SHALL GRADES REQUIRED AND PRO	FURNISH AND SET ALL LIN				
	MONUMENTS SHALL BE RE		•		
A LICENSED SURVEYOR AT N	NO COST TO THE OWNER.			AU	
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THE CONTRACTOR SHALL VERIFY EXISTING GRADES IN THE FIELD AND REPORT ANY

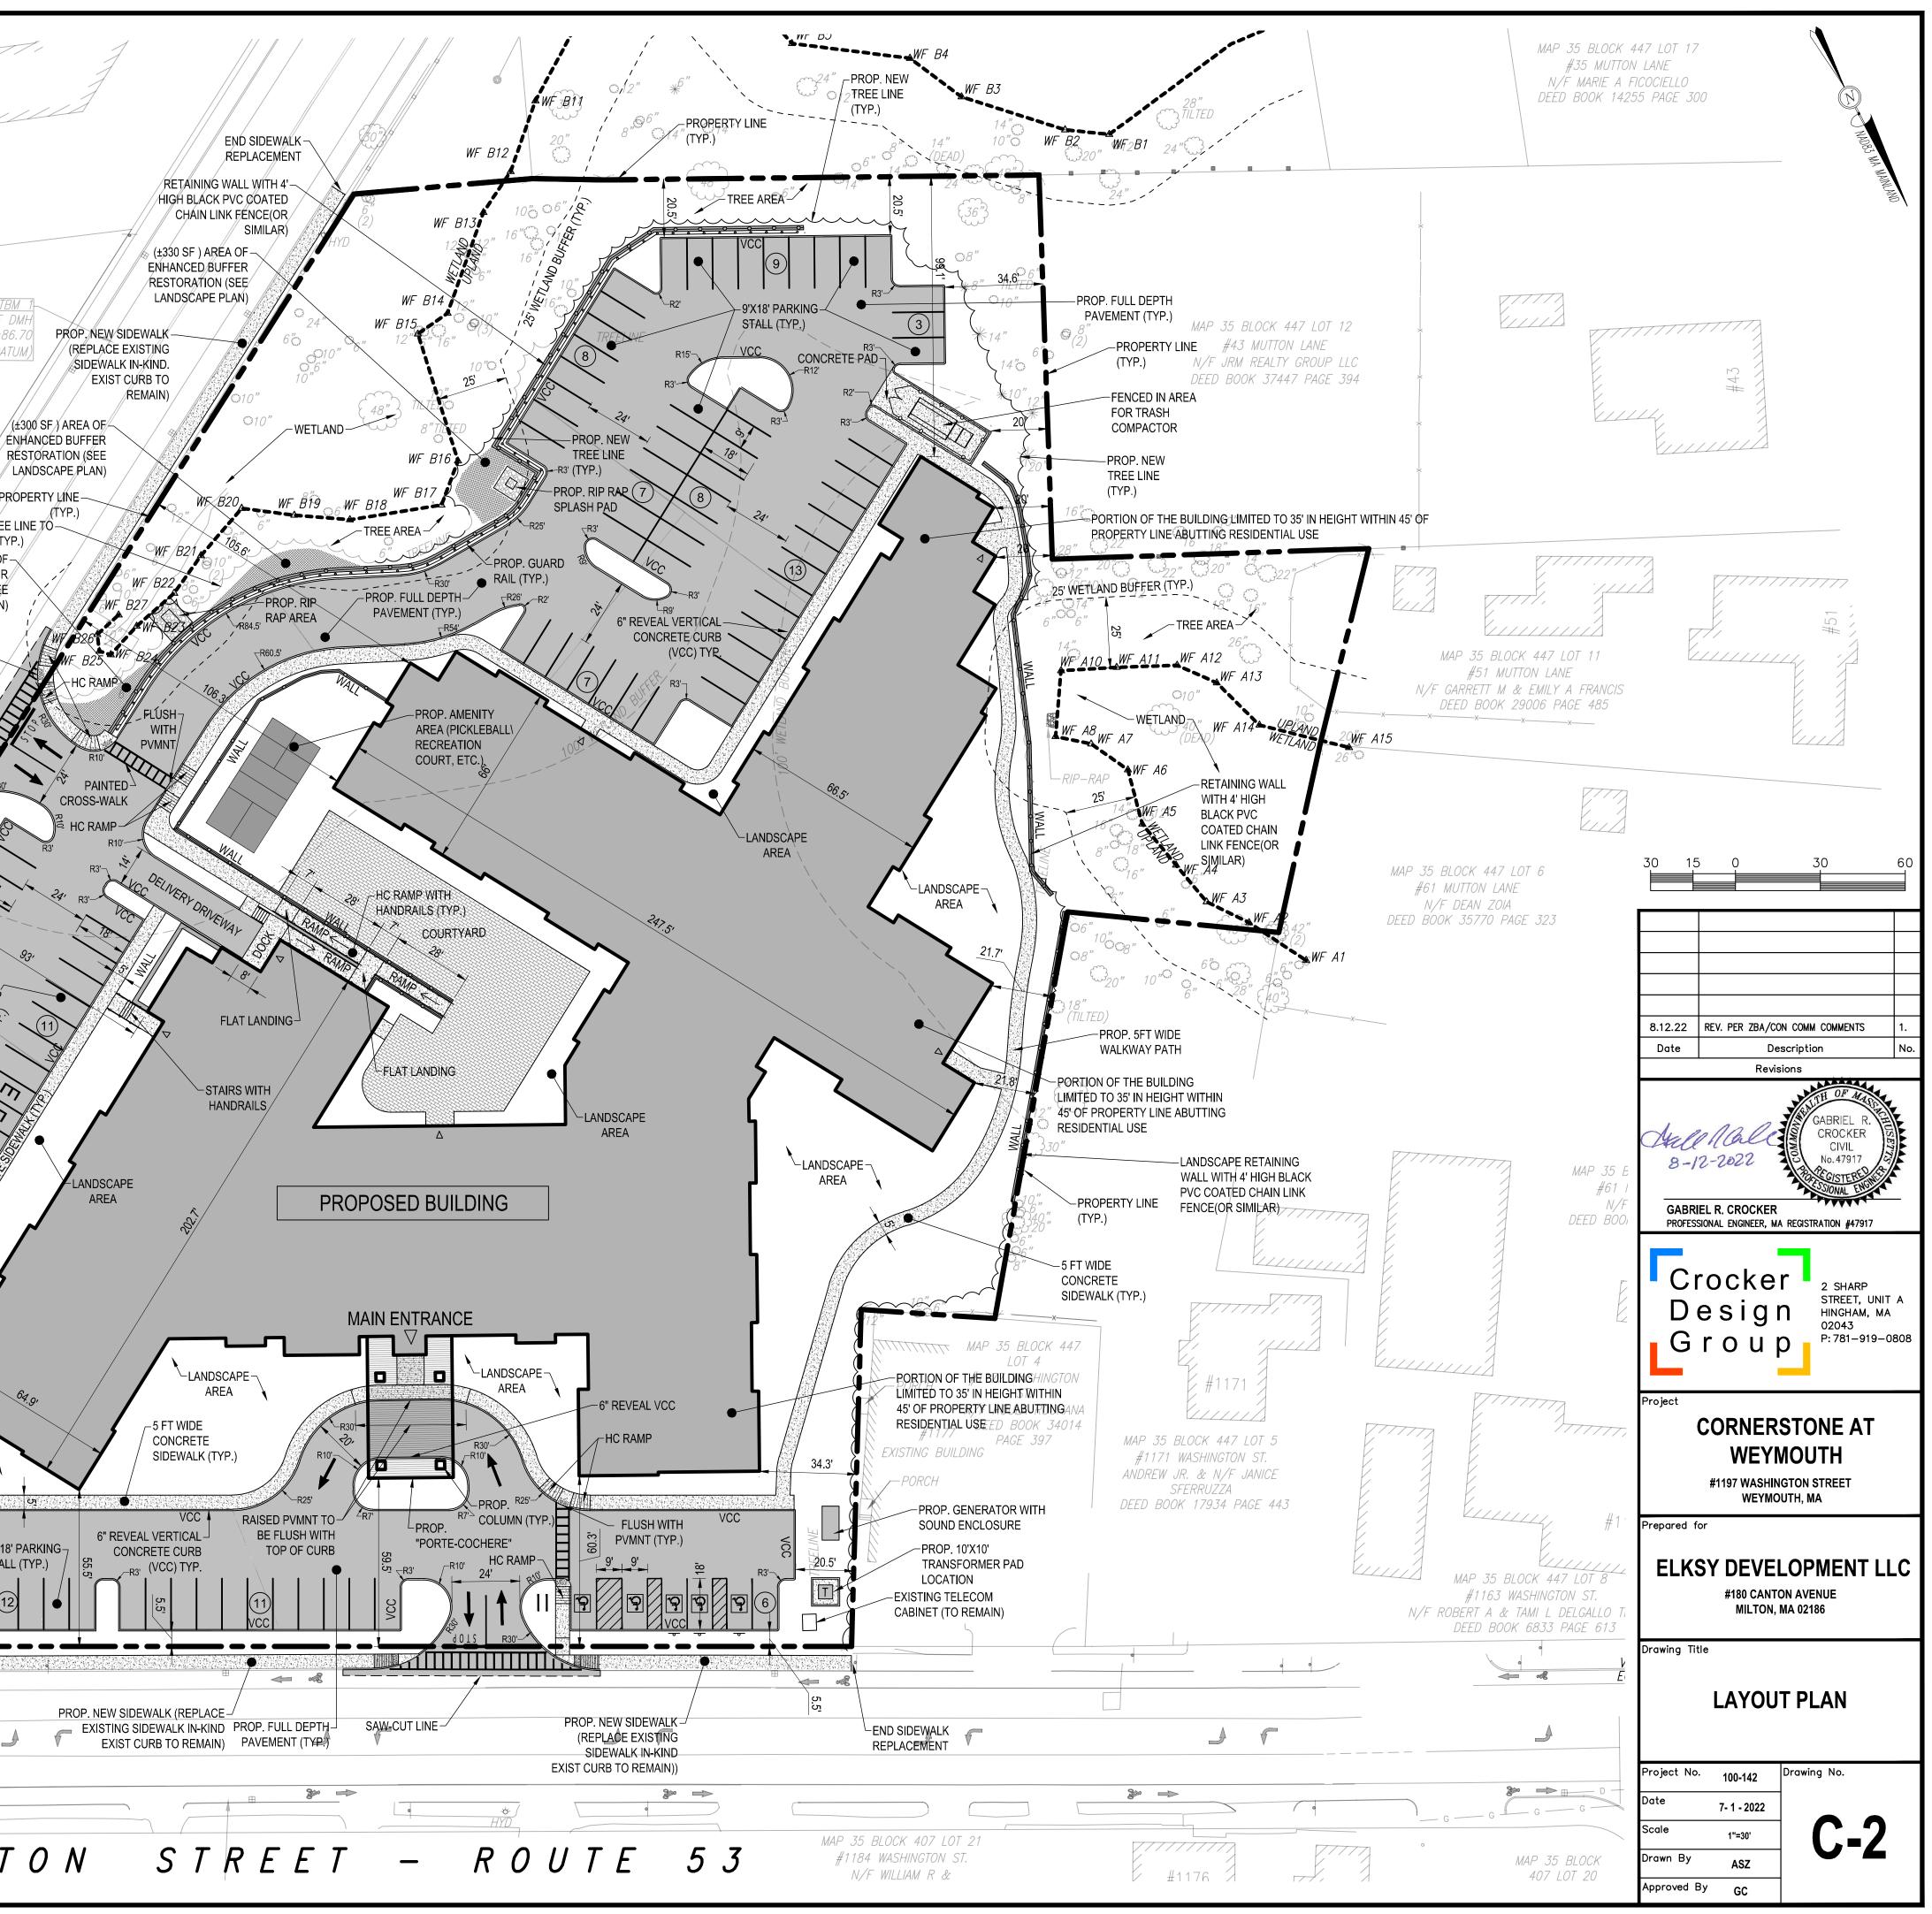



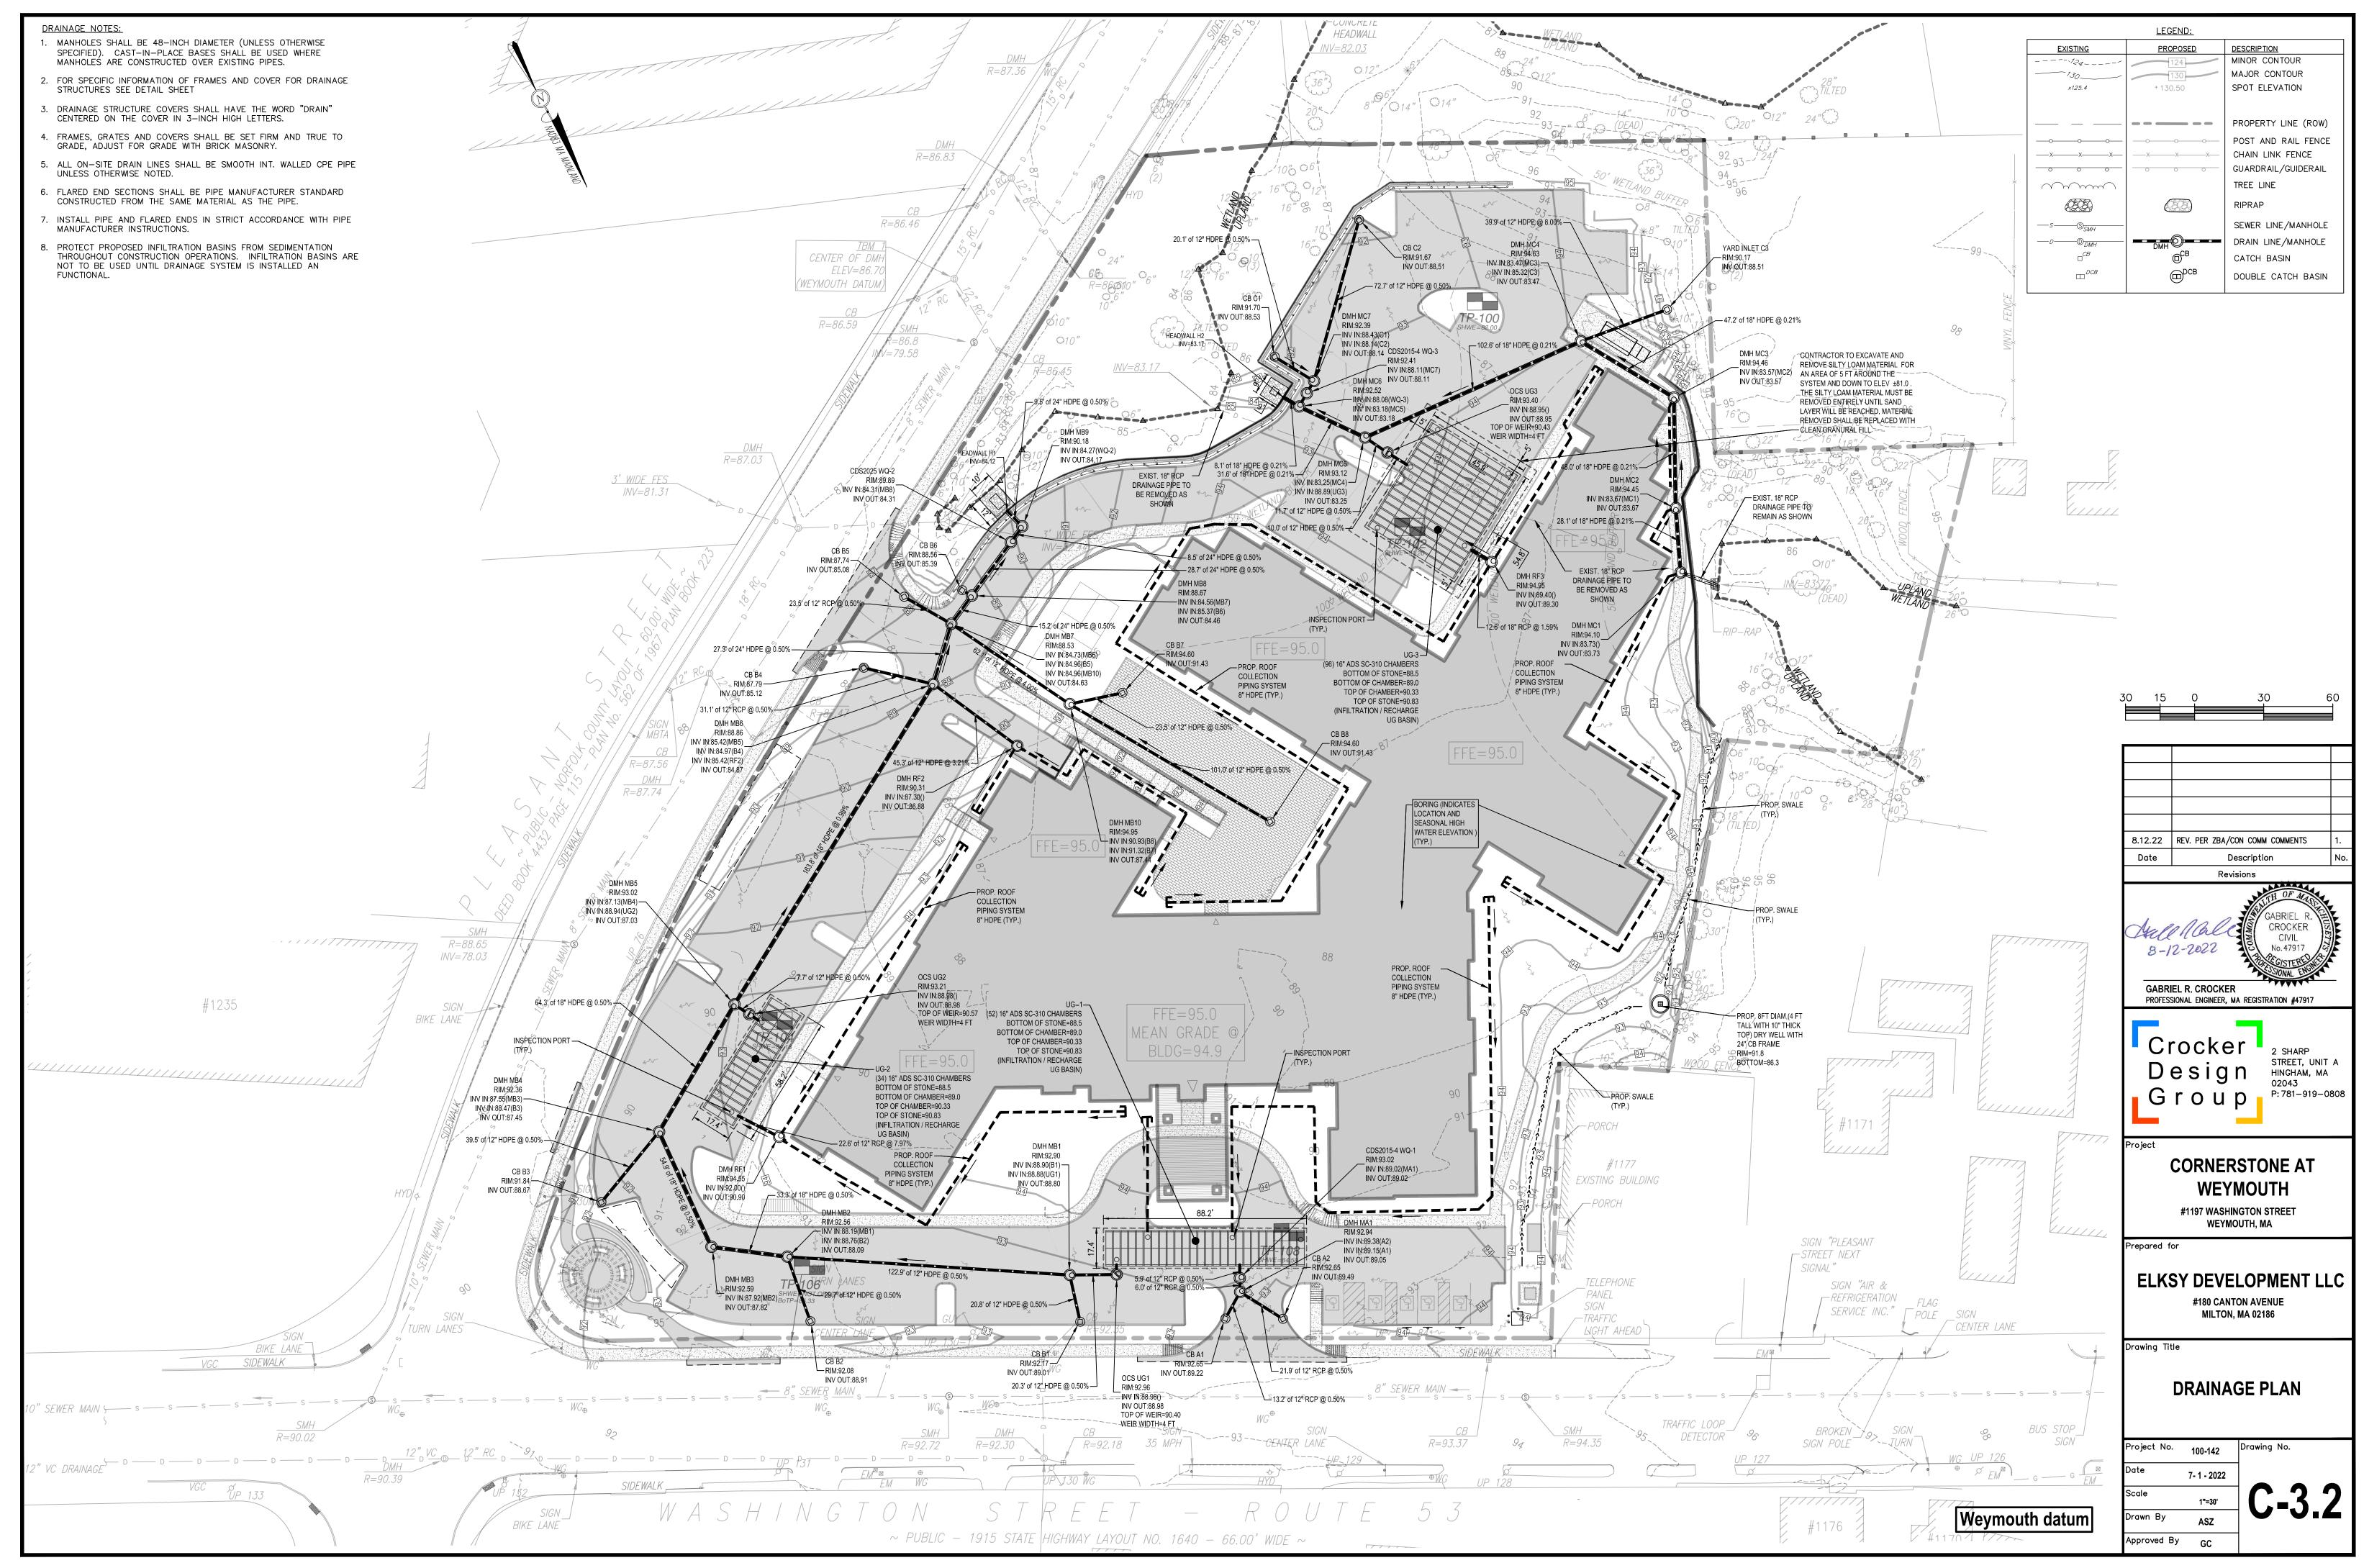

#### <u>GENERAL NOTES</u>

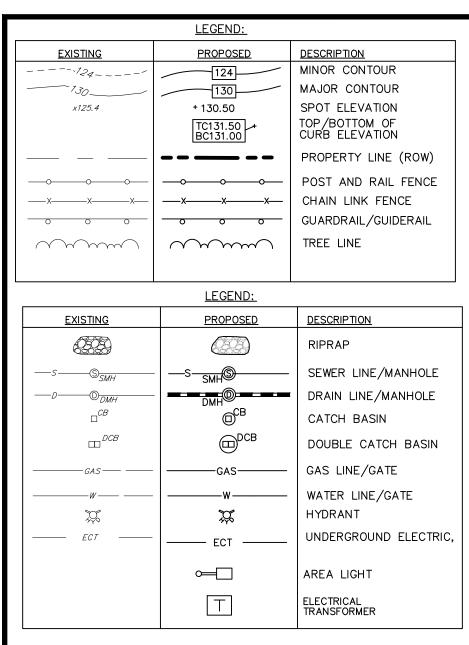THE CONTRACTOR SHALL BE RESPONSIBLE FOR VERIFYING THAT THE PROPOSED IMPROVEMENTS SHOWN ON THE PLANS DO NOT CONFLICT WITH ANY KNOWN EXISTING OR OTHER PROPOSED IMPROVEMENTS. IF ANY CONFLICTS ARE DISCOVERED, THE CONTRACTOR SHALL NOTIFY THE OWNER AND THE ENGINEER PRIOR TO INSTALLATION OF ANY PORTION OF THE SITE WORK WHICH WOULD BE AFFECTED.

2. AT ALL LOCATIONS WHERE EXISTING CURBING OR PAVEMENT ABUTS NEW CONSTRUCTION, THE EDGE OF THE EXISTING CURB OR PAVEMENT SHALL BE SAW CUT TO A CLEAN, SMOOTH EDGE. BLEND NEW PAVEMENT, CURBS AND EARTHWORK SMOOTHLY INTO EXISTING BY MATCHING LINES, GRADES AND JOINTS.

3. THE CONTRACTOR SHALL MAKE ALL ARRANGEMENTS FOR THE ALTERATION AND ADJUSTMENT OF GAS, ELECTRIC, TELEPHONE AND ANY OTHER PRIVATE UTILITIES BY THE UTILITY COMPANIES, AS REQUIRED. WHERE AN EXISTING UTILITY IS FOUND TO CONFLICT WITH THE PROPOSED WORK, THE LOCATION, ELEVATION AND SIZE OF THE UTILITY SHALL BE ACCURATELY DETERMINED WITHOUT DELAY BY THE CONTRACTOR, AND THE INFORMATION FURNISHED TO THE OWNER AND ARCHITECT FOR RESOLUTION.

4. ALL UTILITY COVERS, GRATES, ETC. SHALL BE ADJUSTED TO BE FLUSH WITH THE PAVEMENT FINISH GRADE UNLESS OTHERWISE NOTED. RIM ELEVATIONS OF DRAINAGE STRUCTURES AND MANHOLES ARE APPROXIMATE.

CONTRACTOR SHALL MAINTAIN POSITIVE DRAINAGE AWAY FROM ALL BUILDING FOUNDATIONS, STRUCTURES AND PLANTING BEDS. PITCH EVENLY BETWEEN SPOT GRADES.

6. THE CONTRACTOR SHALL PRESERVE FROM DAMAGE ALL VEGETATION DESIGNATED TO REMAIN AS SHOWN ON THE DRAWINGS, FLAGGED IN THE FIELD OR AS DIRECTED BY THE LANDSCAPE ARCHITECT. THE LIMIT OF CLEARING SHALL BE IN ACCORDANCE WITH LIMIT OF WORK AS SHOWN ON THE DRAWINGS, UNLESS OTHERWISE SPECIFIED. NO TREES SHALL BE CUT, REMOVED, DESTROYED OR TRIMMED OUTSIDE THE LIMIT OF WORK WITHOUT APPROVAL OF THE OWNER AND THE TOWN OF THE PLYMPTON PLANNING BOARD.

7. THE CONTRACTOR SHALL ALTER THE MASONRY OF THE TOP SECTION OF ALL EXISTING DRAINAGE STRUCTURES AS NECESSARY FOR CHANGES IN GRADE, AND RESET ALL WATER AND DRAINAGE FRAMES, GRATES AND BOXES TO THE PROPOSED FINISH SURFACE GRADE.

8. UNDERGROUND UTILITIES WERE COMPILED FROM AVAILABLE RECORD PLANS OF UTILITY COMPANIES AND PUBLIC AGENCIES AND ARE APPROXIMATE AND ASSUMED. BEFORE COMMENCING SITE WORK IN ANY AREA, CONTACT "DIG SAFE" AT 1-888-344-7233 TO ACCURATELY LOCATE UNDERGROUND UTILITIES. ANY DAMAGE TO EXISTING UTILITIES OR STRUCTURES SHALL BE THE CONTRACTOR'S RESPONSIBILITY. NO EXCAVATION SHALL BE DONE UNTIL UTILITY COMPANIES ARE PROPERLY NOTIFIED IN ADVANCE.

9. ALL SITEWORK SHALL CONFORM TO THE CONTRACT DOCUMENTS AND SHALL COMPLY WITH APPLICABLE CODES AND REGULATIONS, AND THE STORMWATER POLLUTION PREVENTION PLAN (SWPPP) PREPARED FOR THE PROJECT. THE CONTRACTOR SHALL MAKE ALL NOTIFICATIONS REQUIRED FOR INSPECTIONS AND TESTING ASSOCIATED WITH

10. THE CONTRACTOR SHALL OBTAIN ALL NECESSARY PERMITS AND CONSTRUCTION SHALL COMPLY WITH ALL TOWN OF HINGHAM DEPARTMENT OF PUBLIC WORKS FOR PAVING, PAVEMENT CUTTING, EXCAVATION, UTILITY CONNECTIONS, BACKFILLING, AND PATCHING.

11. ALL RIP RAP STONE SHALL BE HAND CHINKED AND SHALL CONFORM TO MASSACHUSETTS HIGHWAY DEPARTMENT STANDARDS.

12. SIZES OF DOMESTIC AND FIRE WATER SERVICES TO BE DETERMINED BY PROJECT MEP ENGINEER AND FIRE PROTECTION ENGINEER.

13. CONTRACTOR IS CAUTIONED THAT NOT EVERY FITTING ON THE WATER AND FIRE SERVICE ARE LABELED. TYPICAL FITTINGS ARE LABELED FROM TIME TO TIME, HOWEVER THE INTENT OF THESE DRAWINGS IS THAT THE CONTRACTOR PROVIDE A COMPLETE WORKING SYSTEM, INCLUSIVE OF ALL COMPONENTS NECESSARY TO CONSTRUCT OPERATE AND MAINTAIN BOTH THE FIRE AND WATER SYSTEMS.

15. LOCATION OF ELECTRICAL AND TELECOM SYSTEMS ARE APPROXIMATE. REFER TO FINAL ELECTRICAL SITE PLANS FOR DETAIL INFORMATION AND LOCATION OF ALL ELECTRIC, TELECOM, CABLE AND

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12" VC DRAINAGE

EQUIPMENTS.

#805  $\mathcal{C}$ LOCK 446 LOT 23 LEASANT STREET RL REALTY LLC *CK 17449 PAGE 83*  $\boldsymbol{\mathcal{L}}$ XIIIIIIIIIA  $\mathcal{S}$ R=88.65 SS INV=78.03

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446 LOT 22 HINGTON ST. ADING POST INC. 1649 PAGE 731


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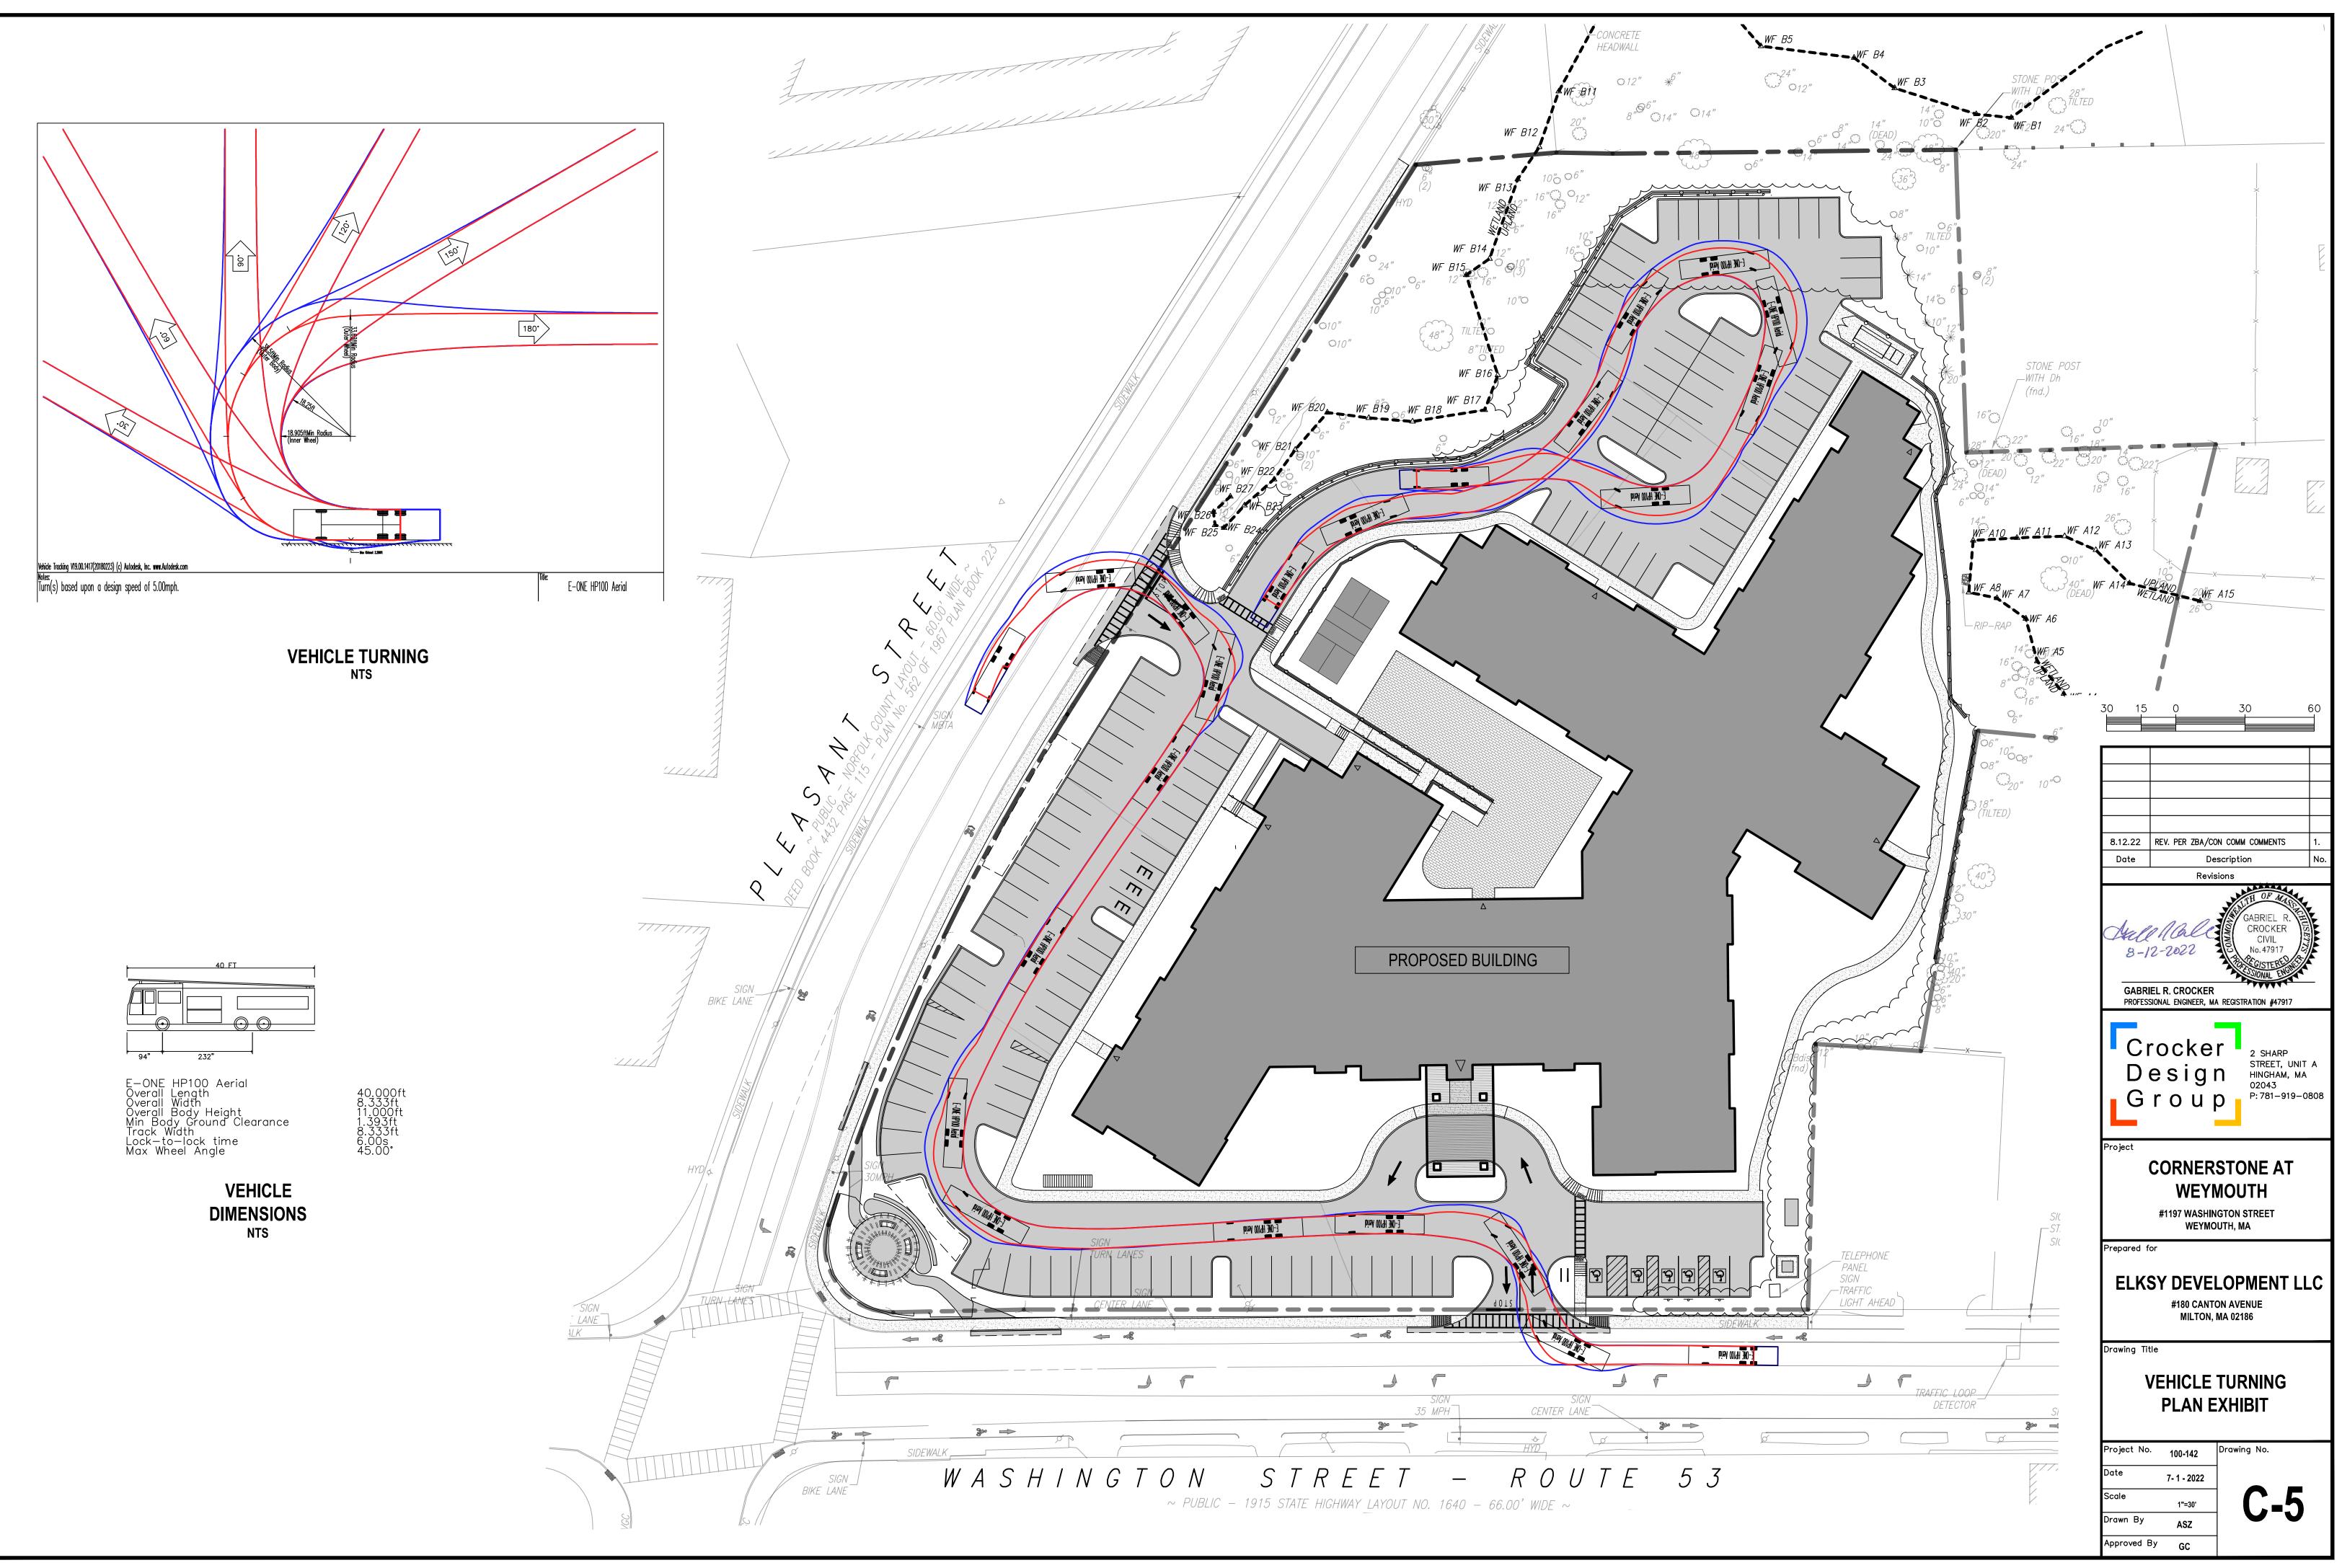
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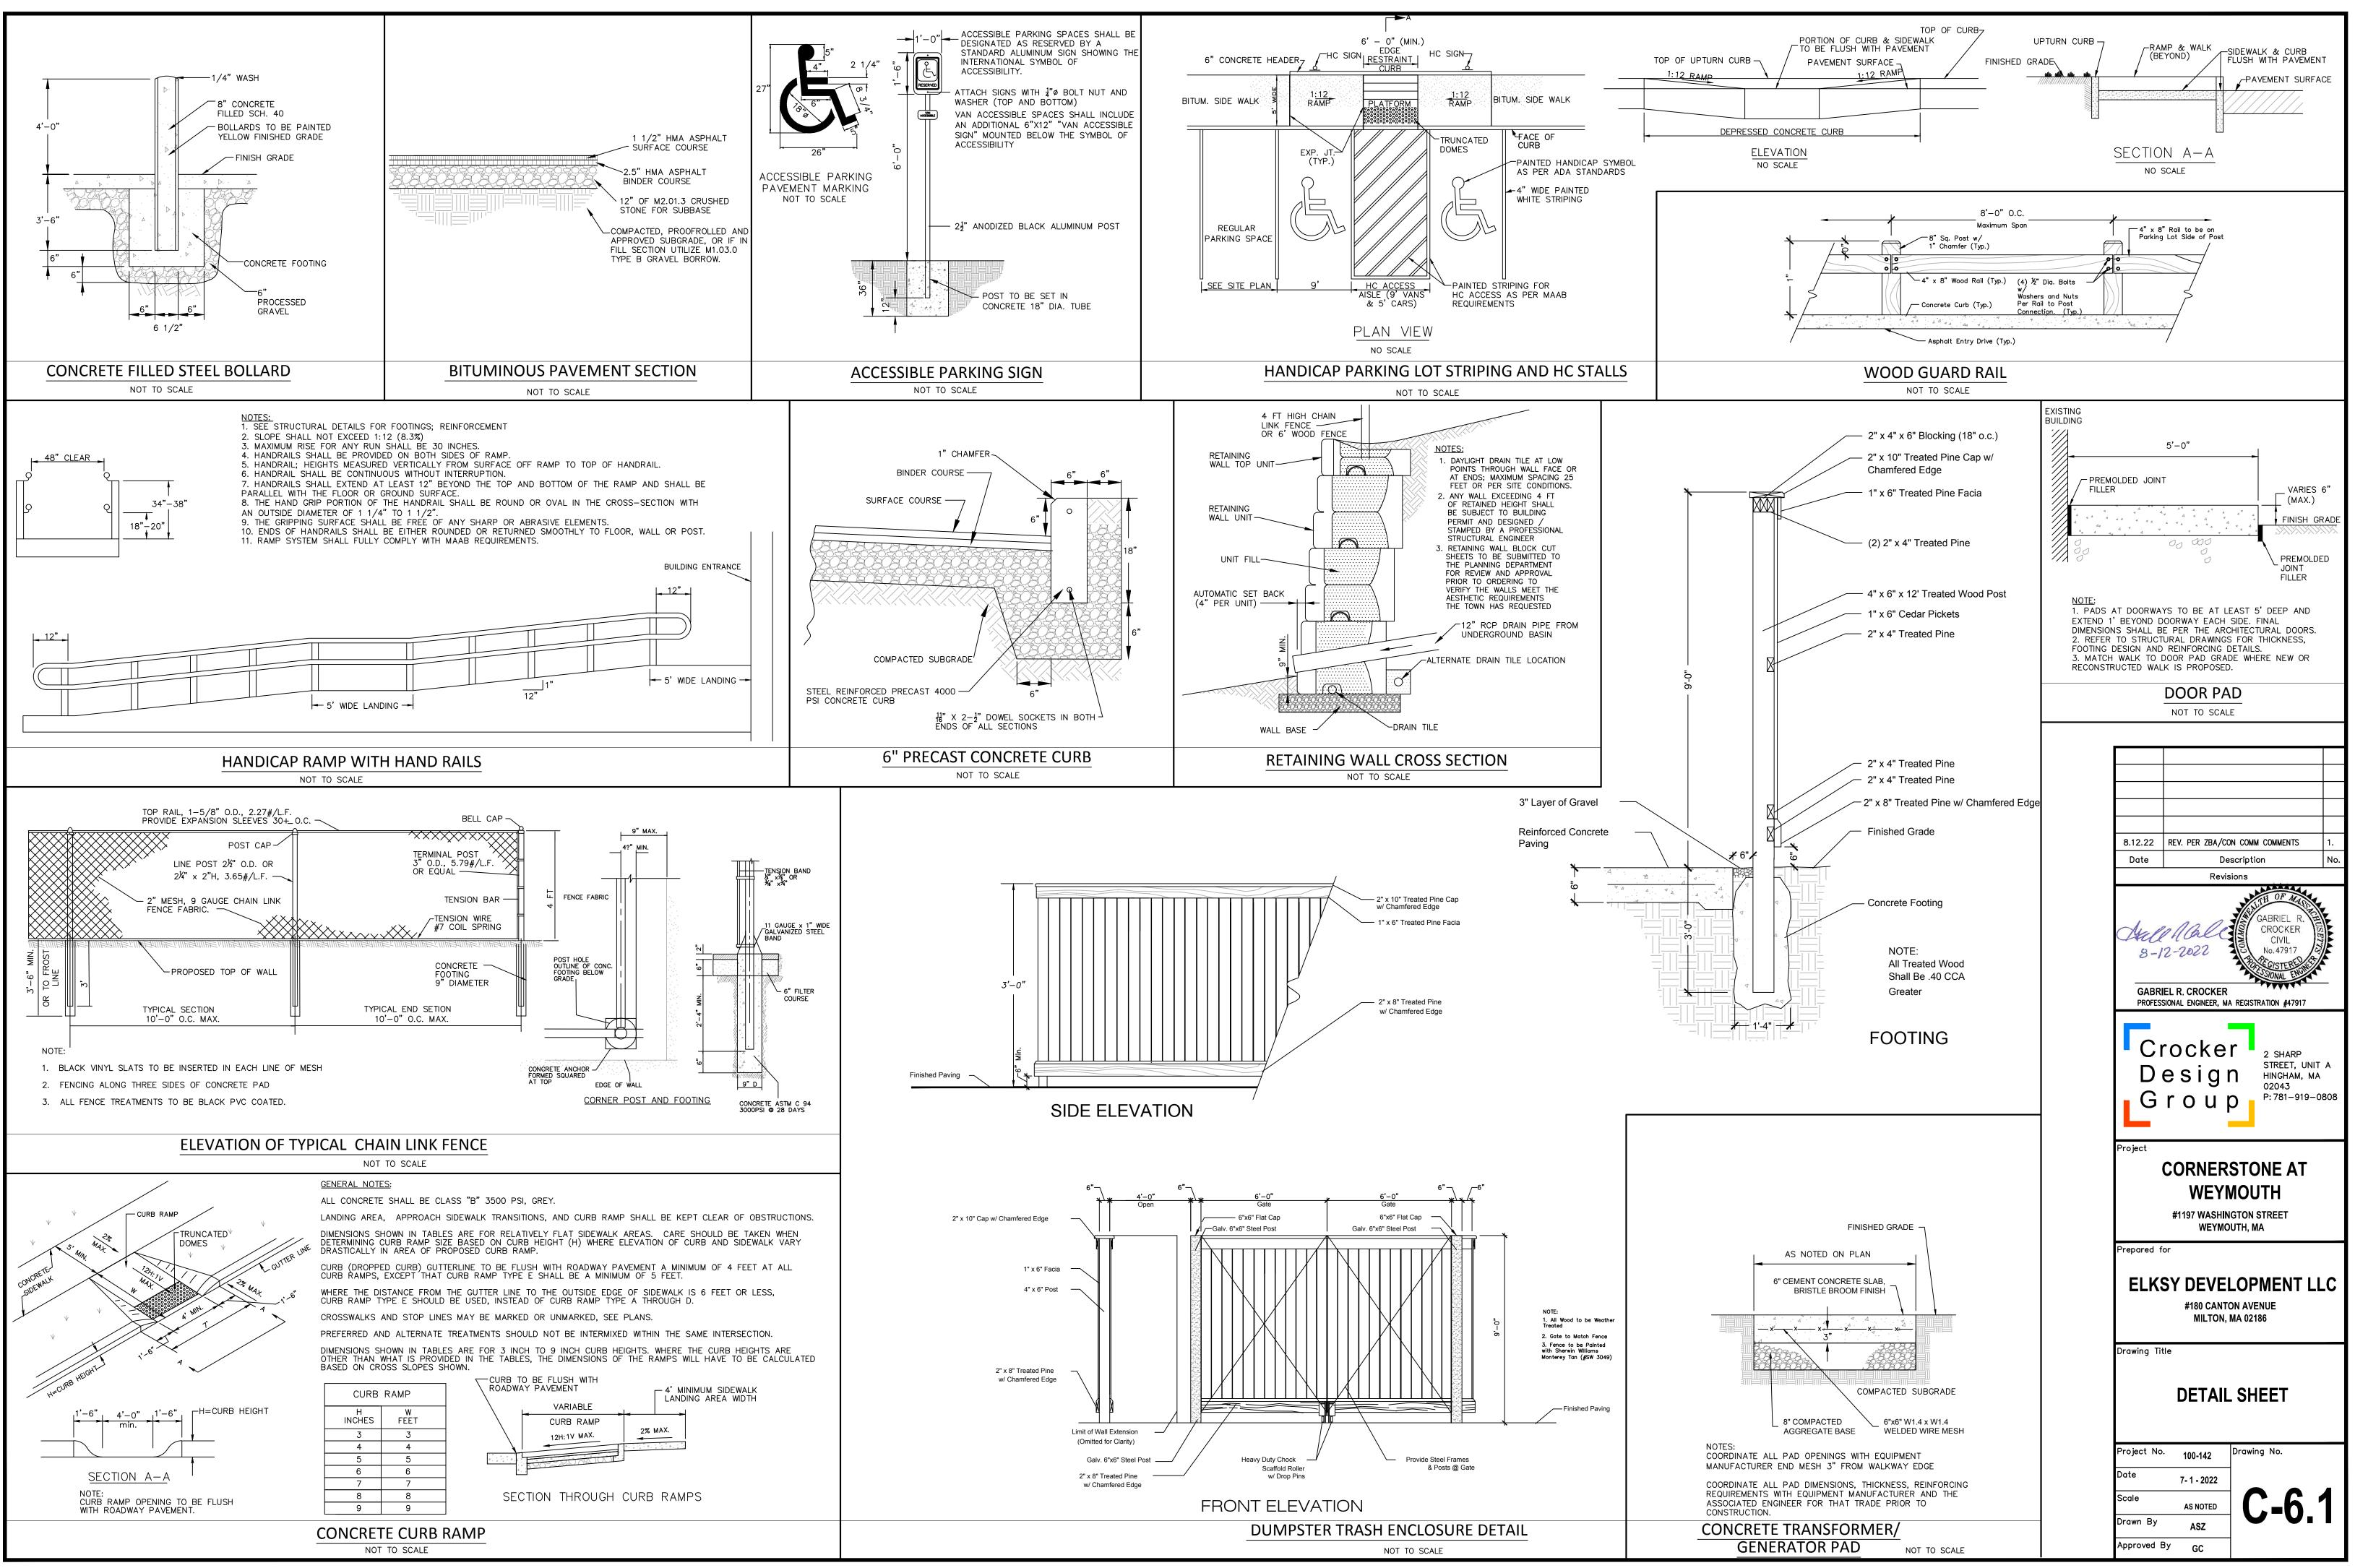
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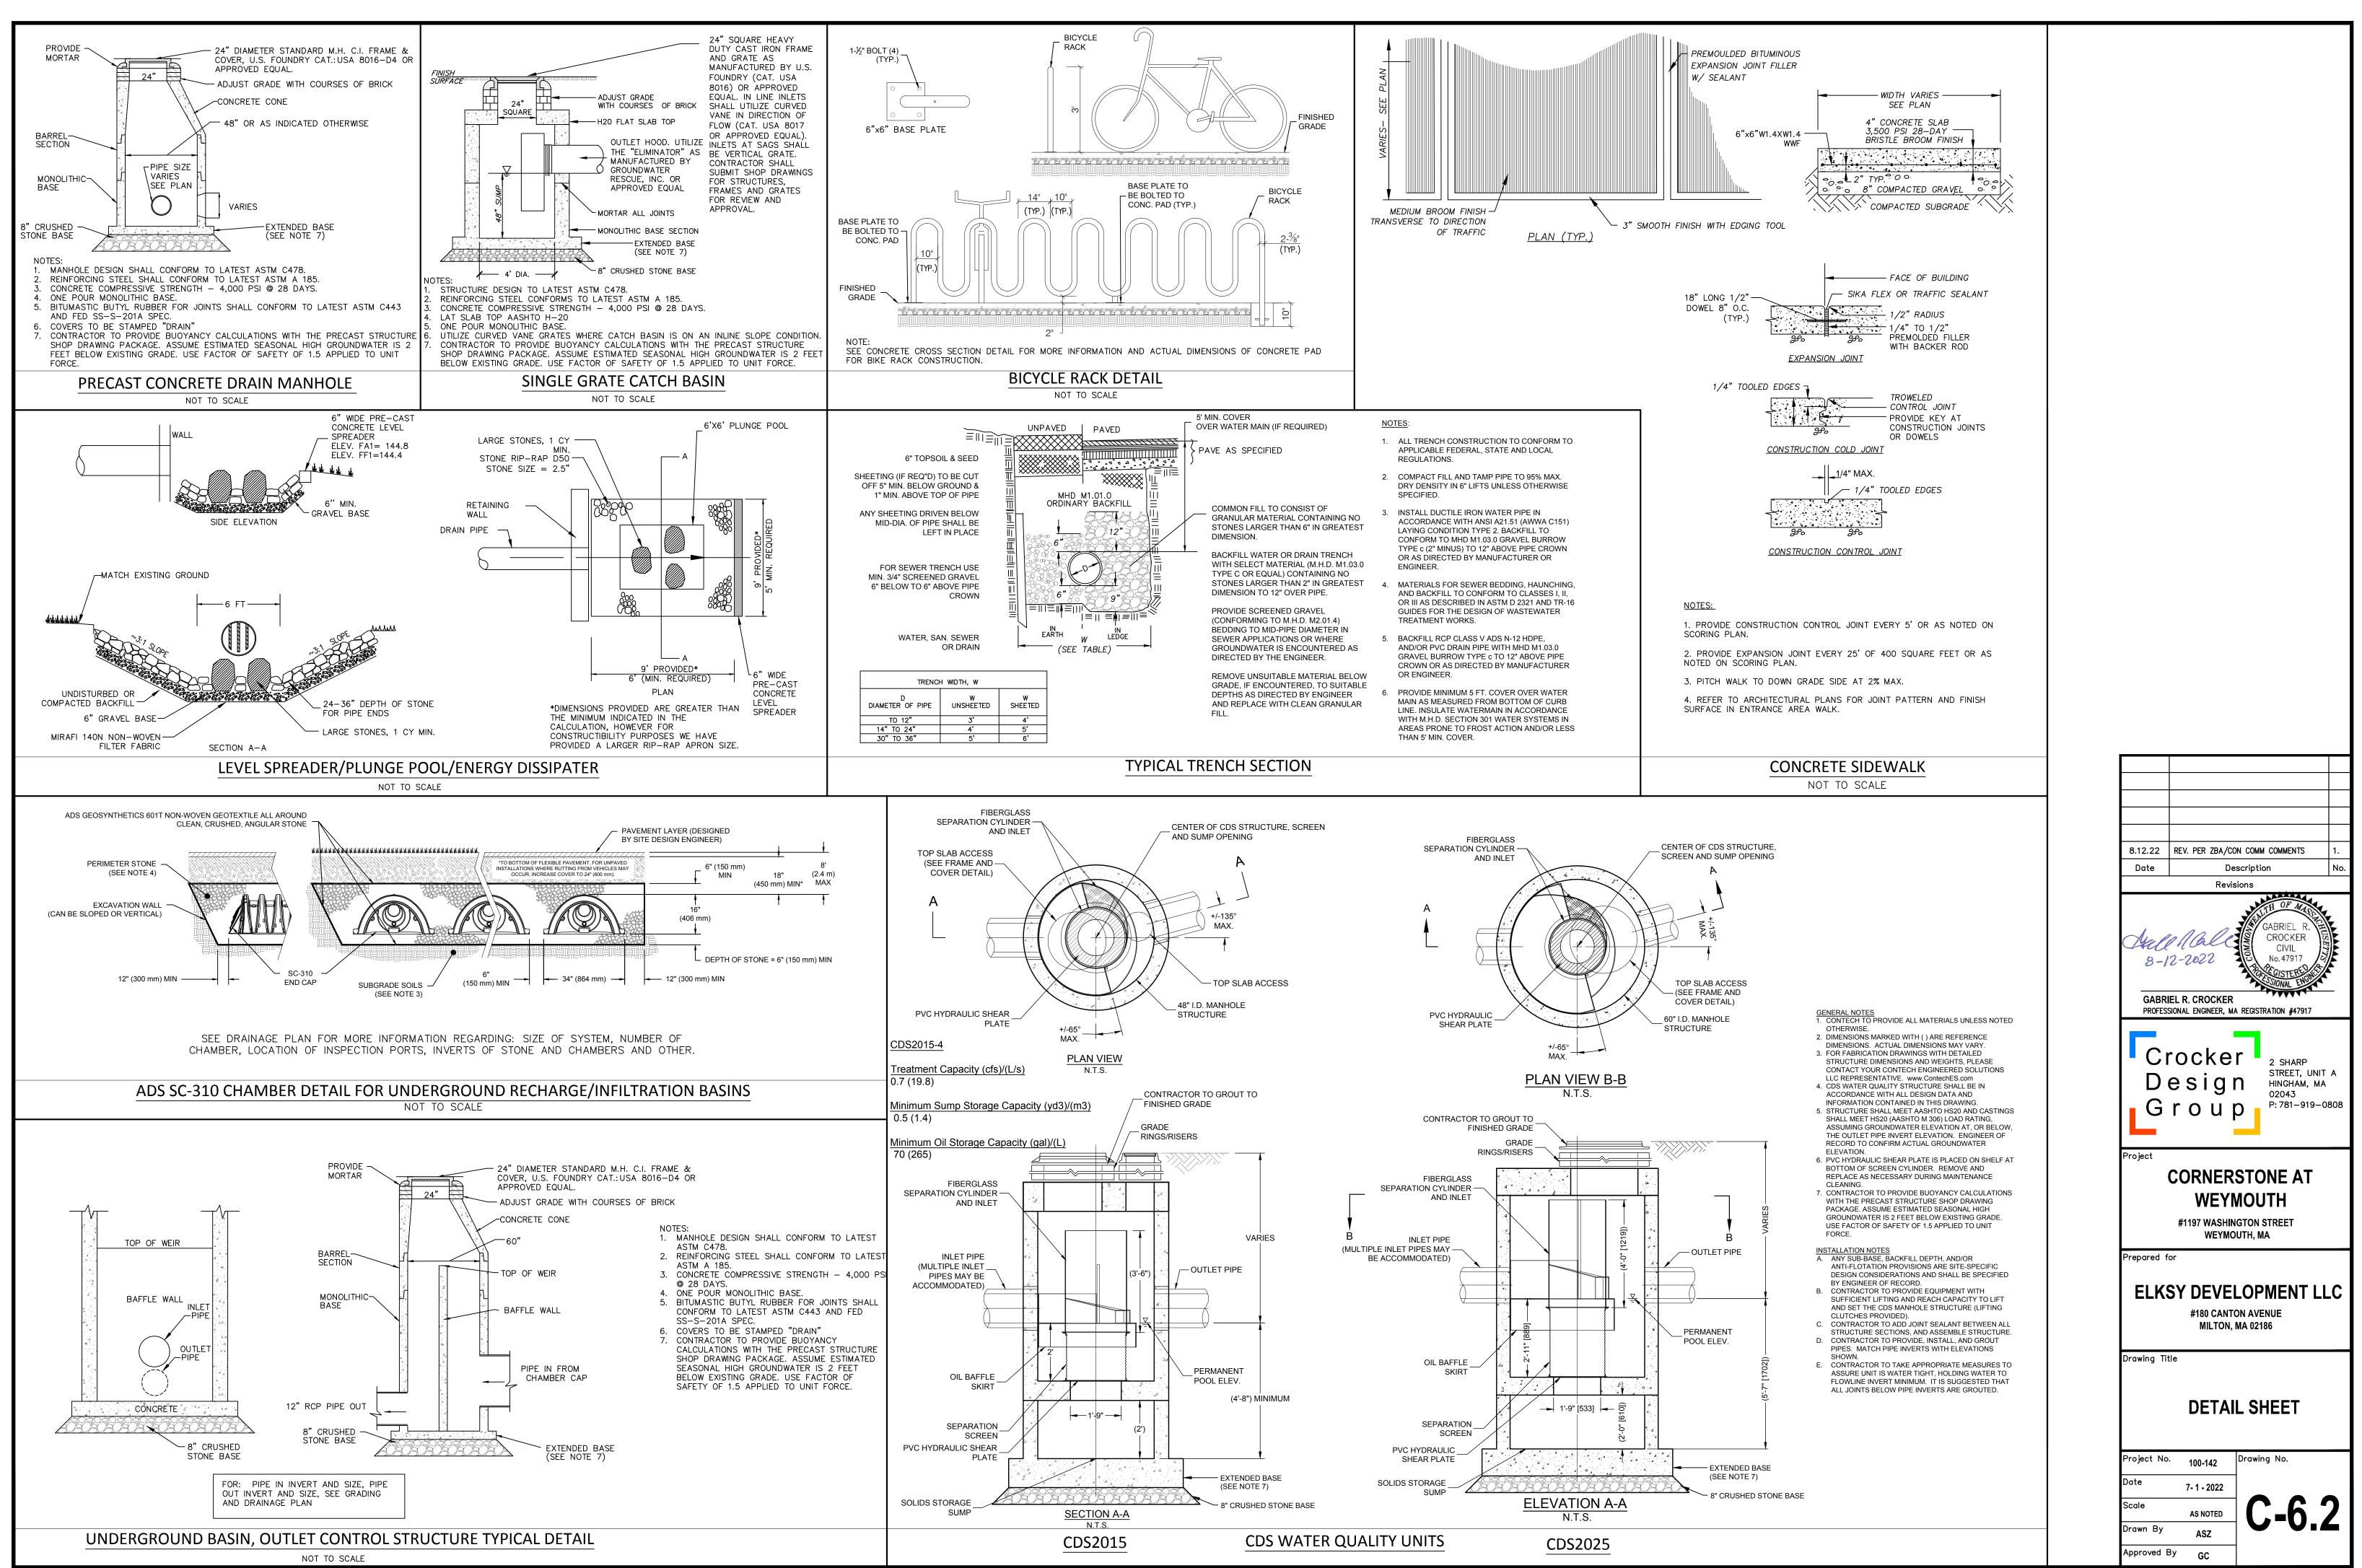
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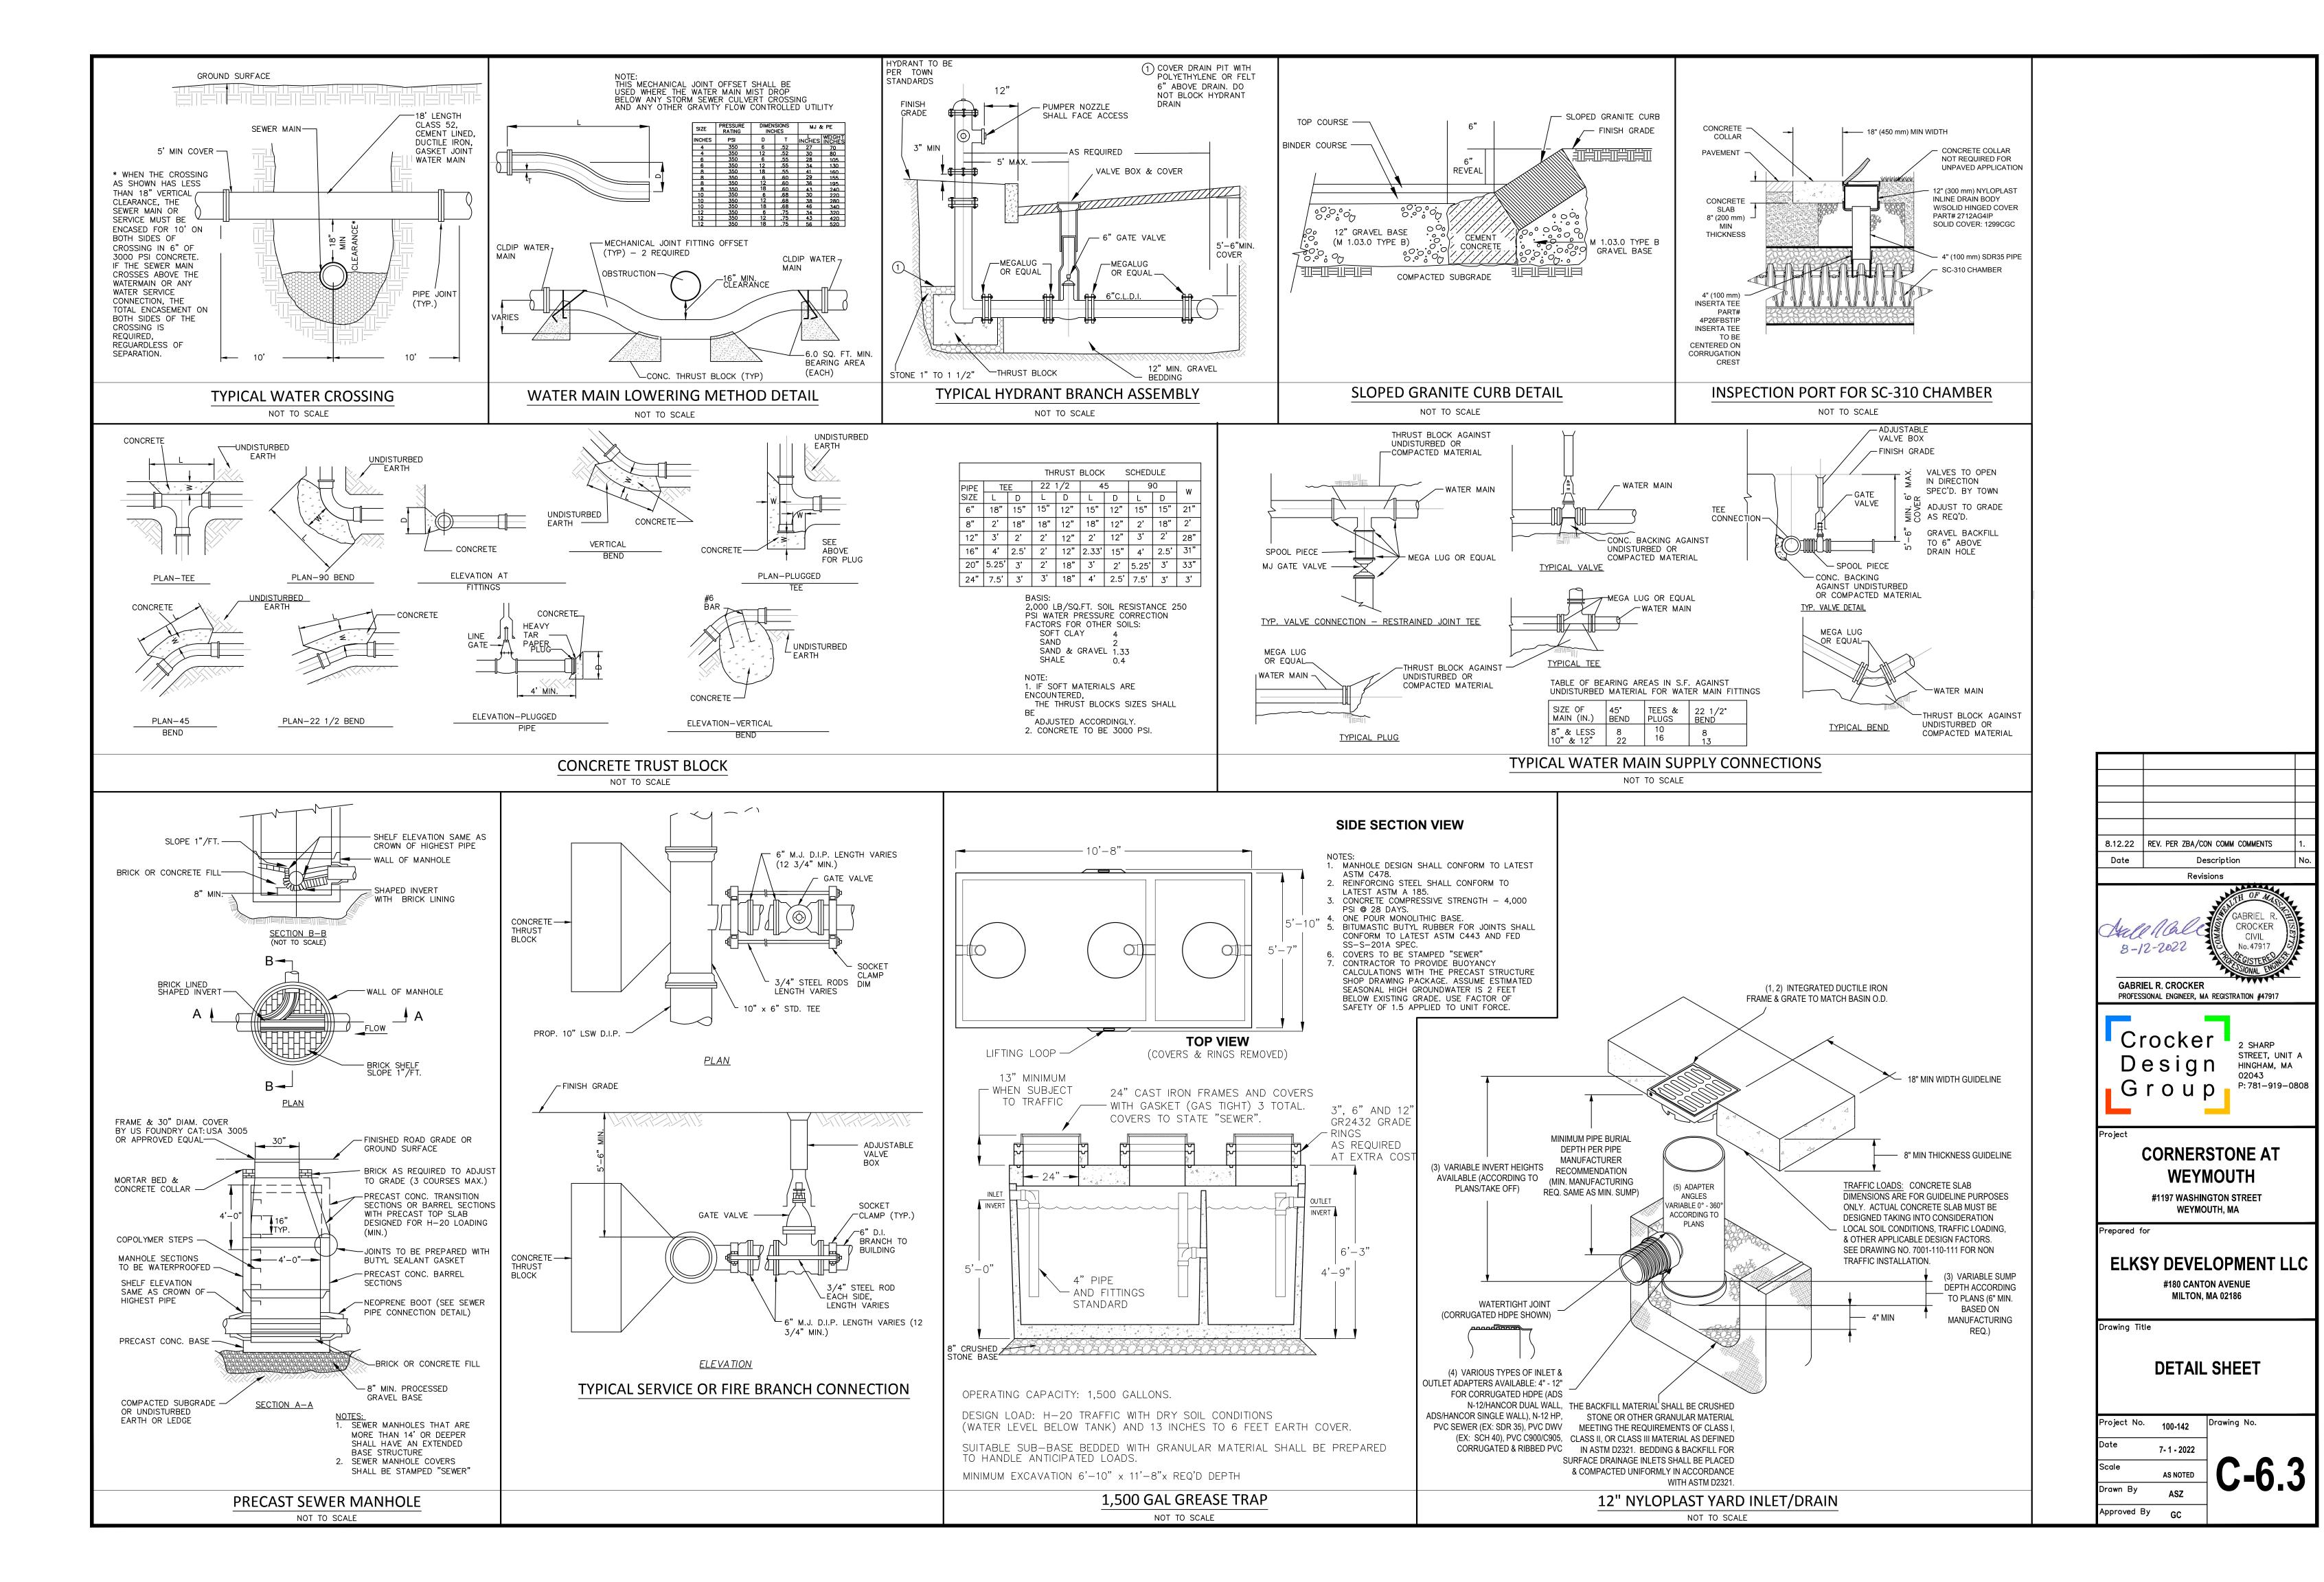
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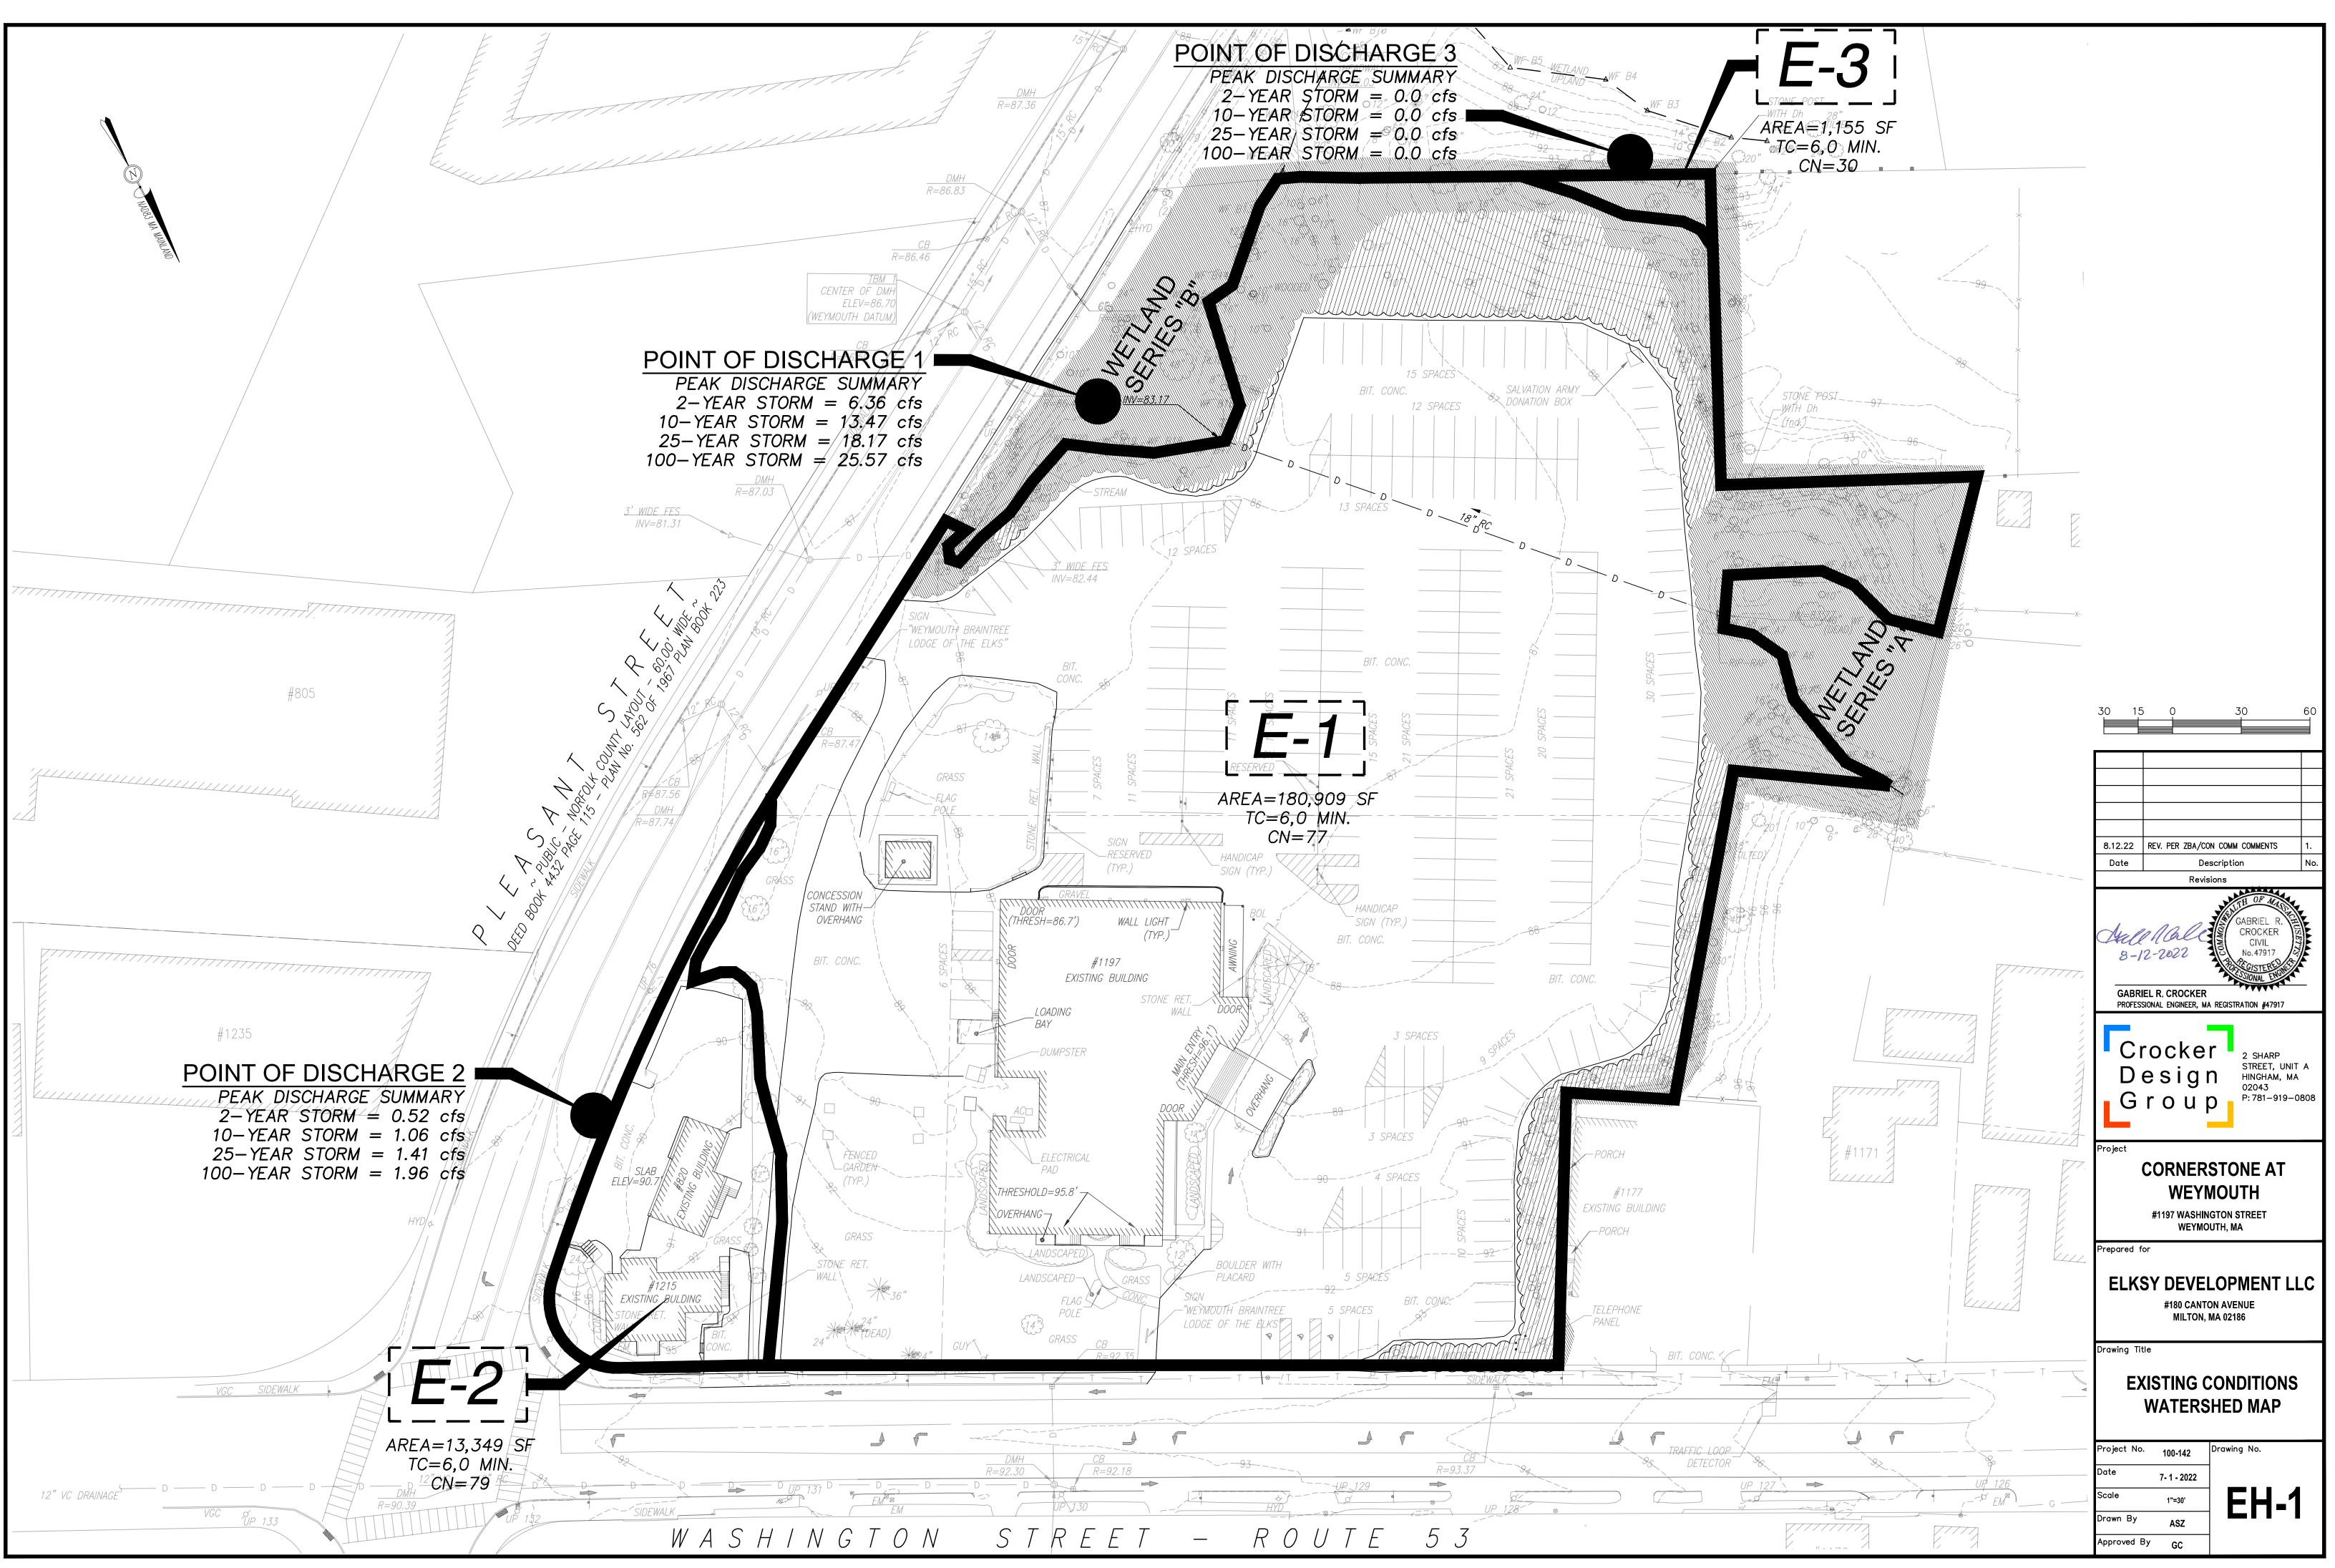














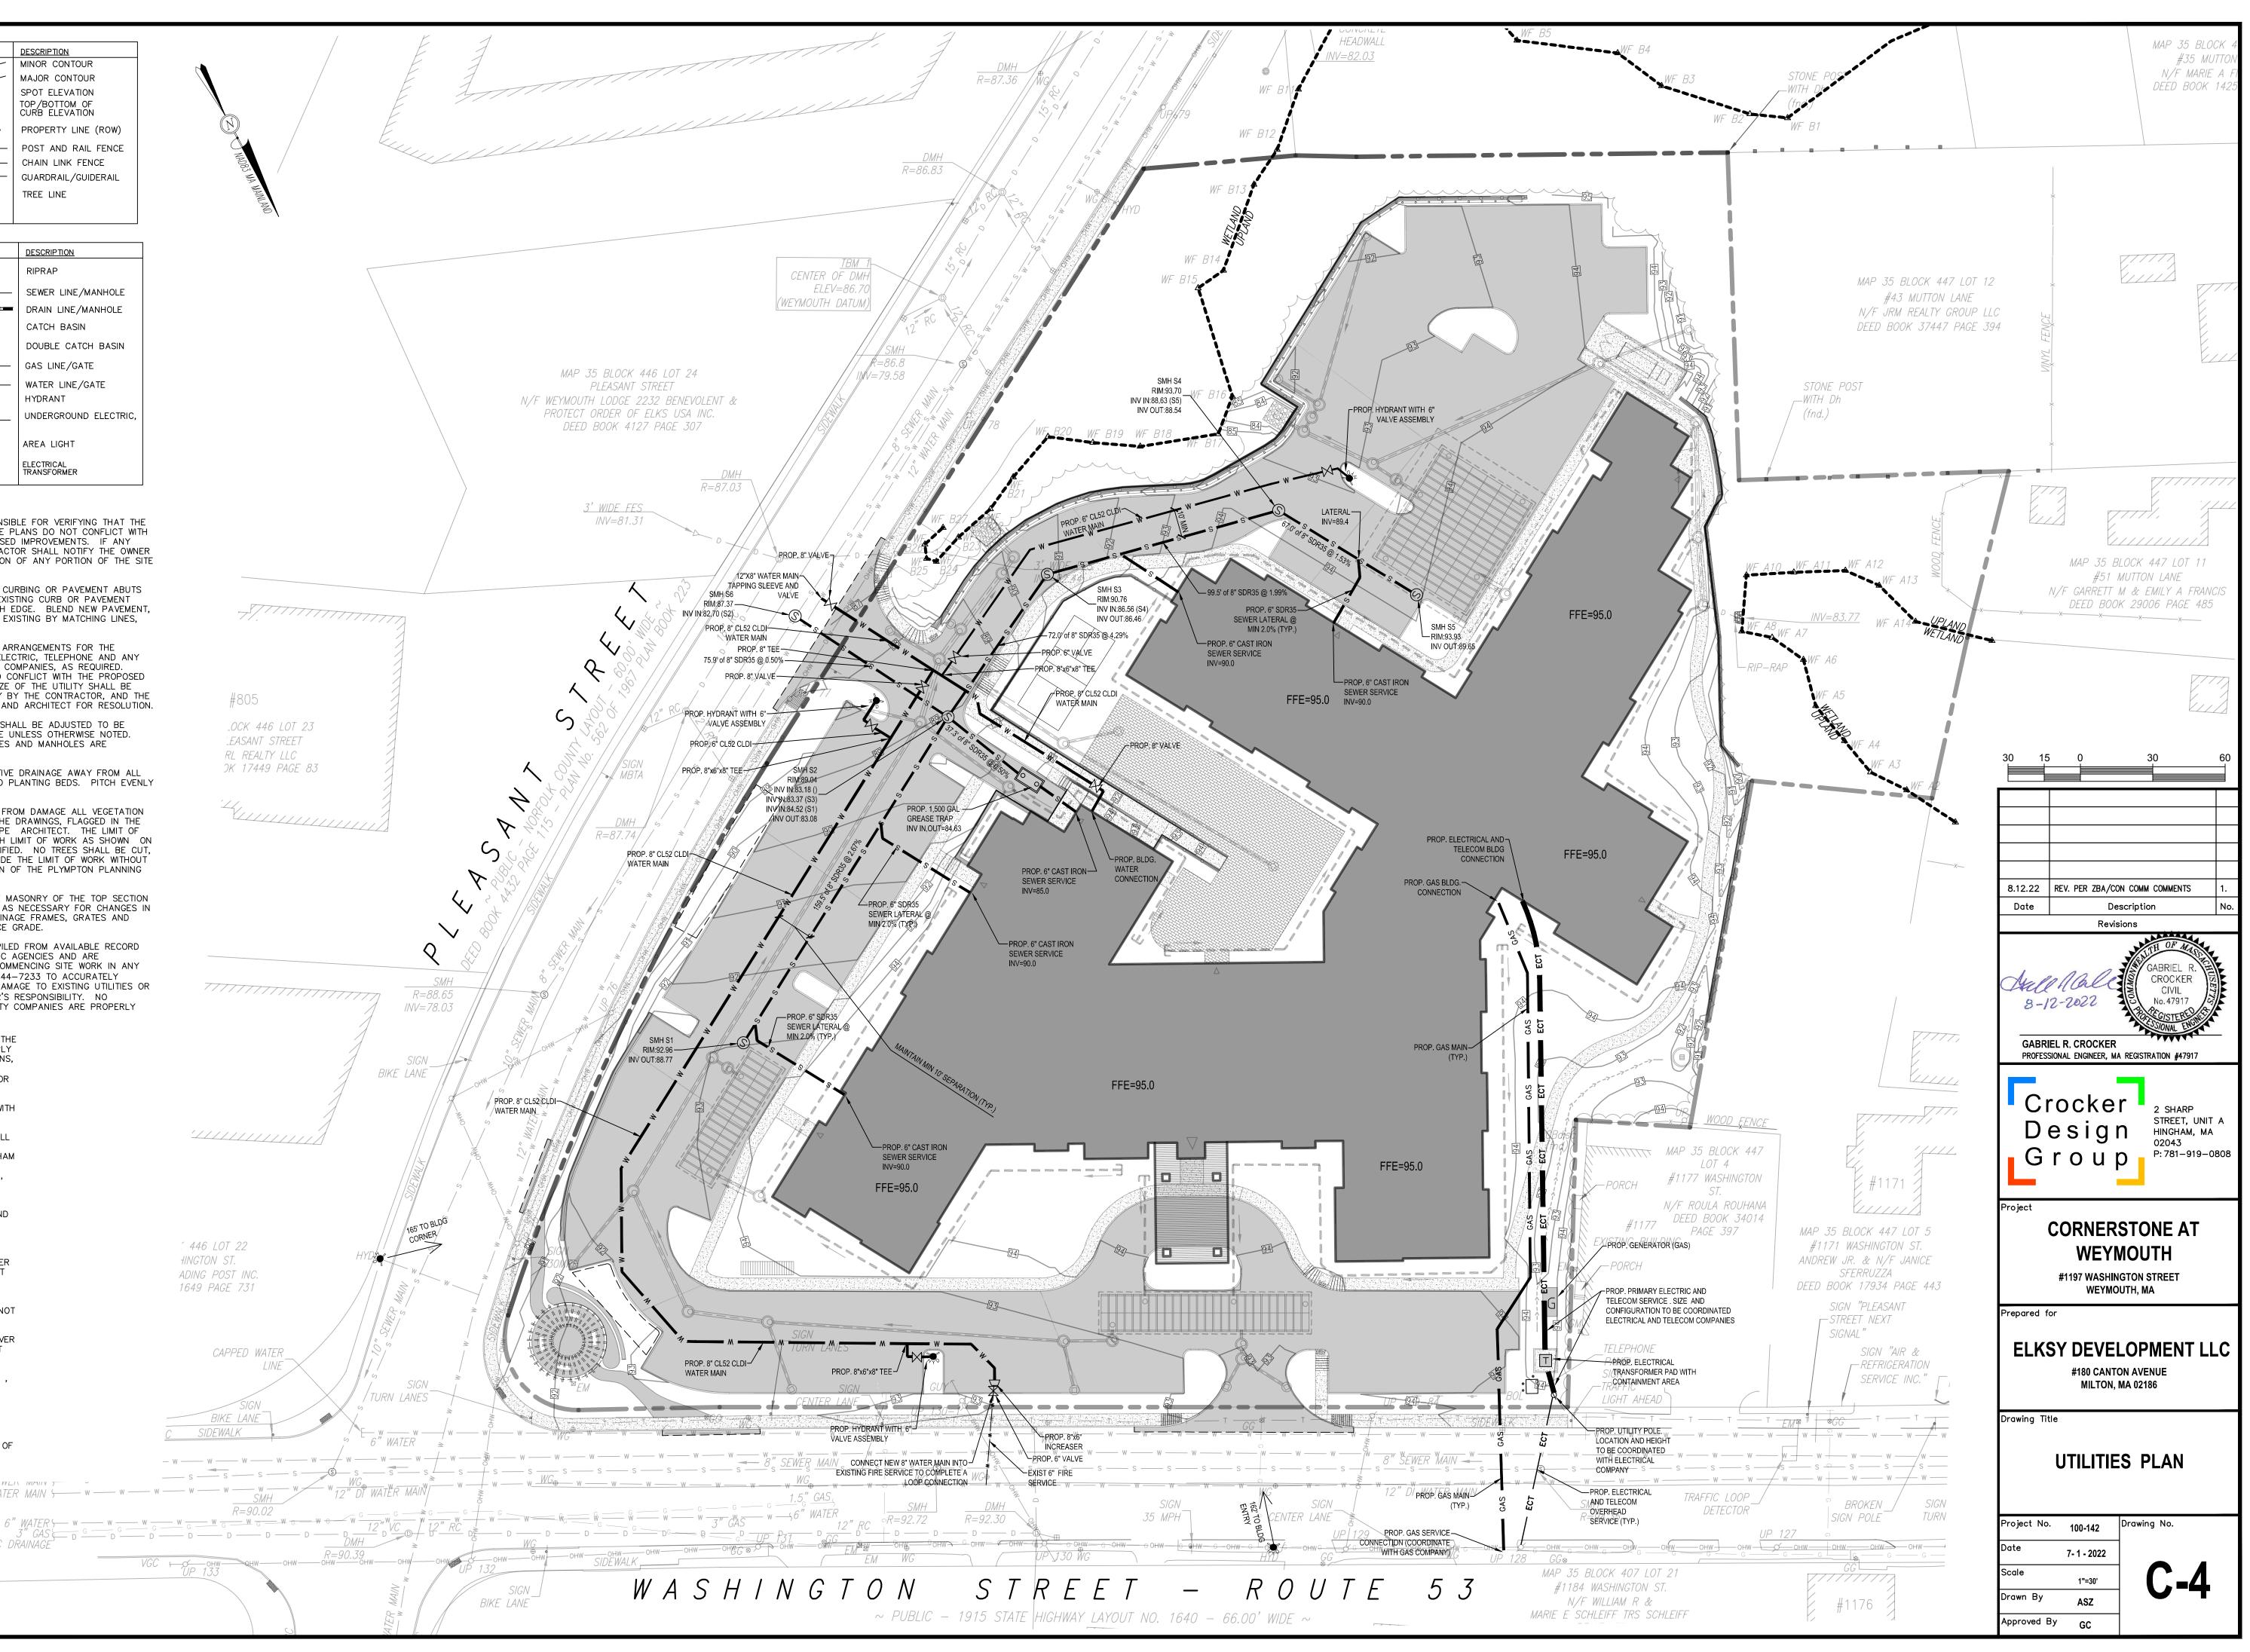


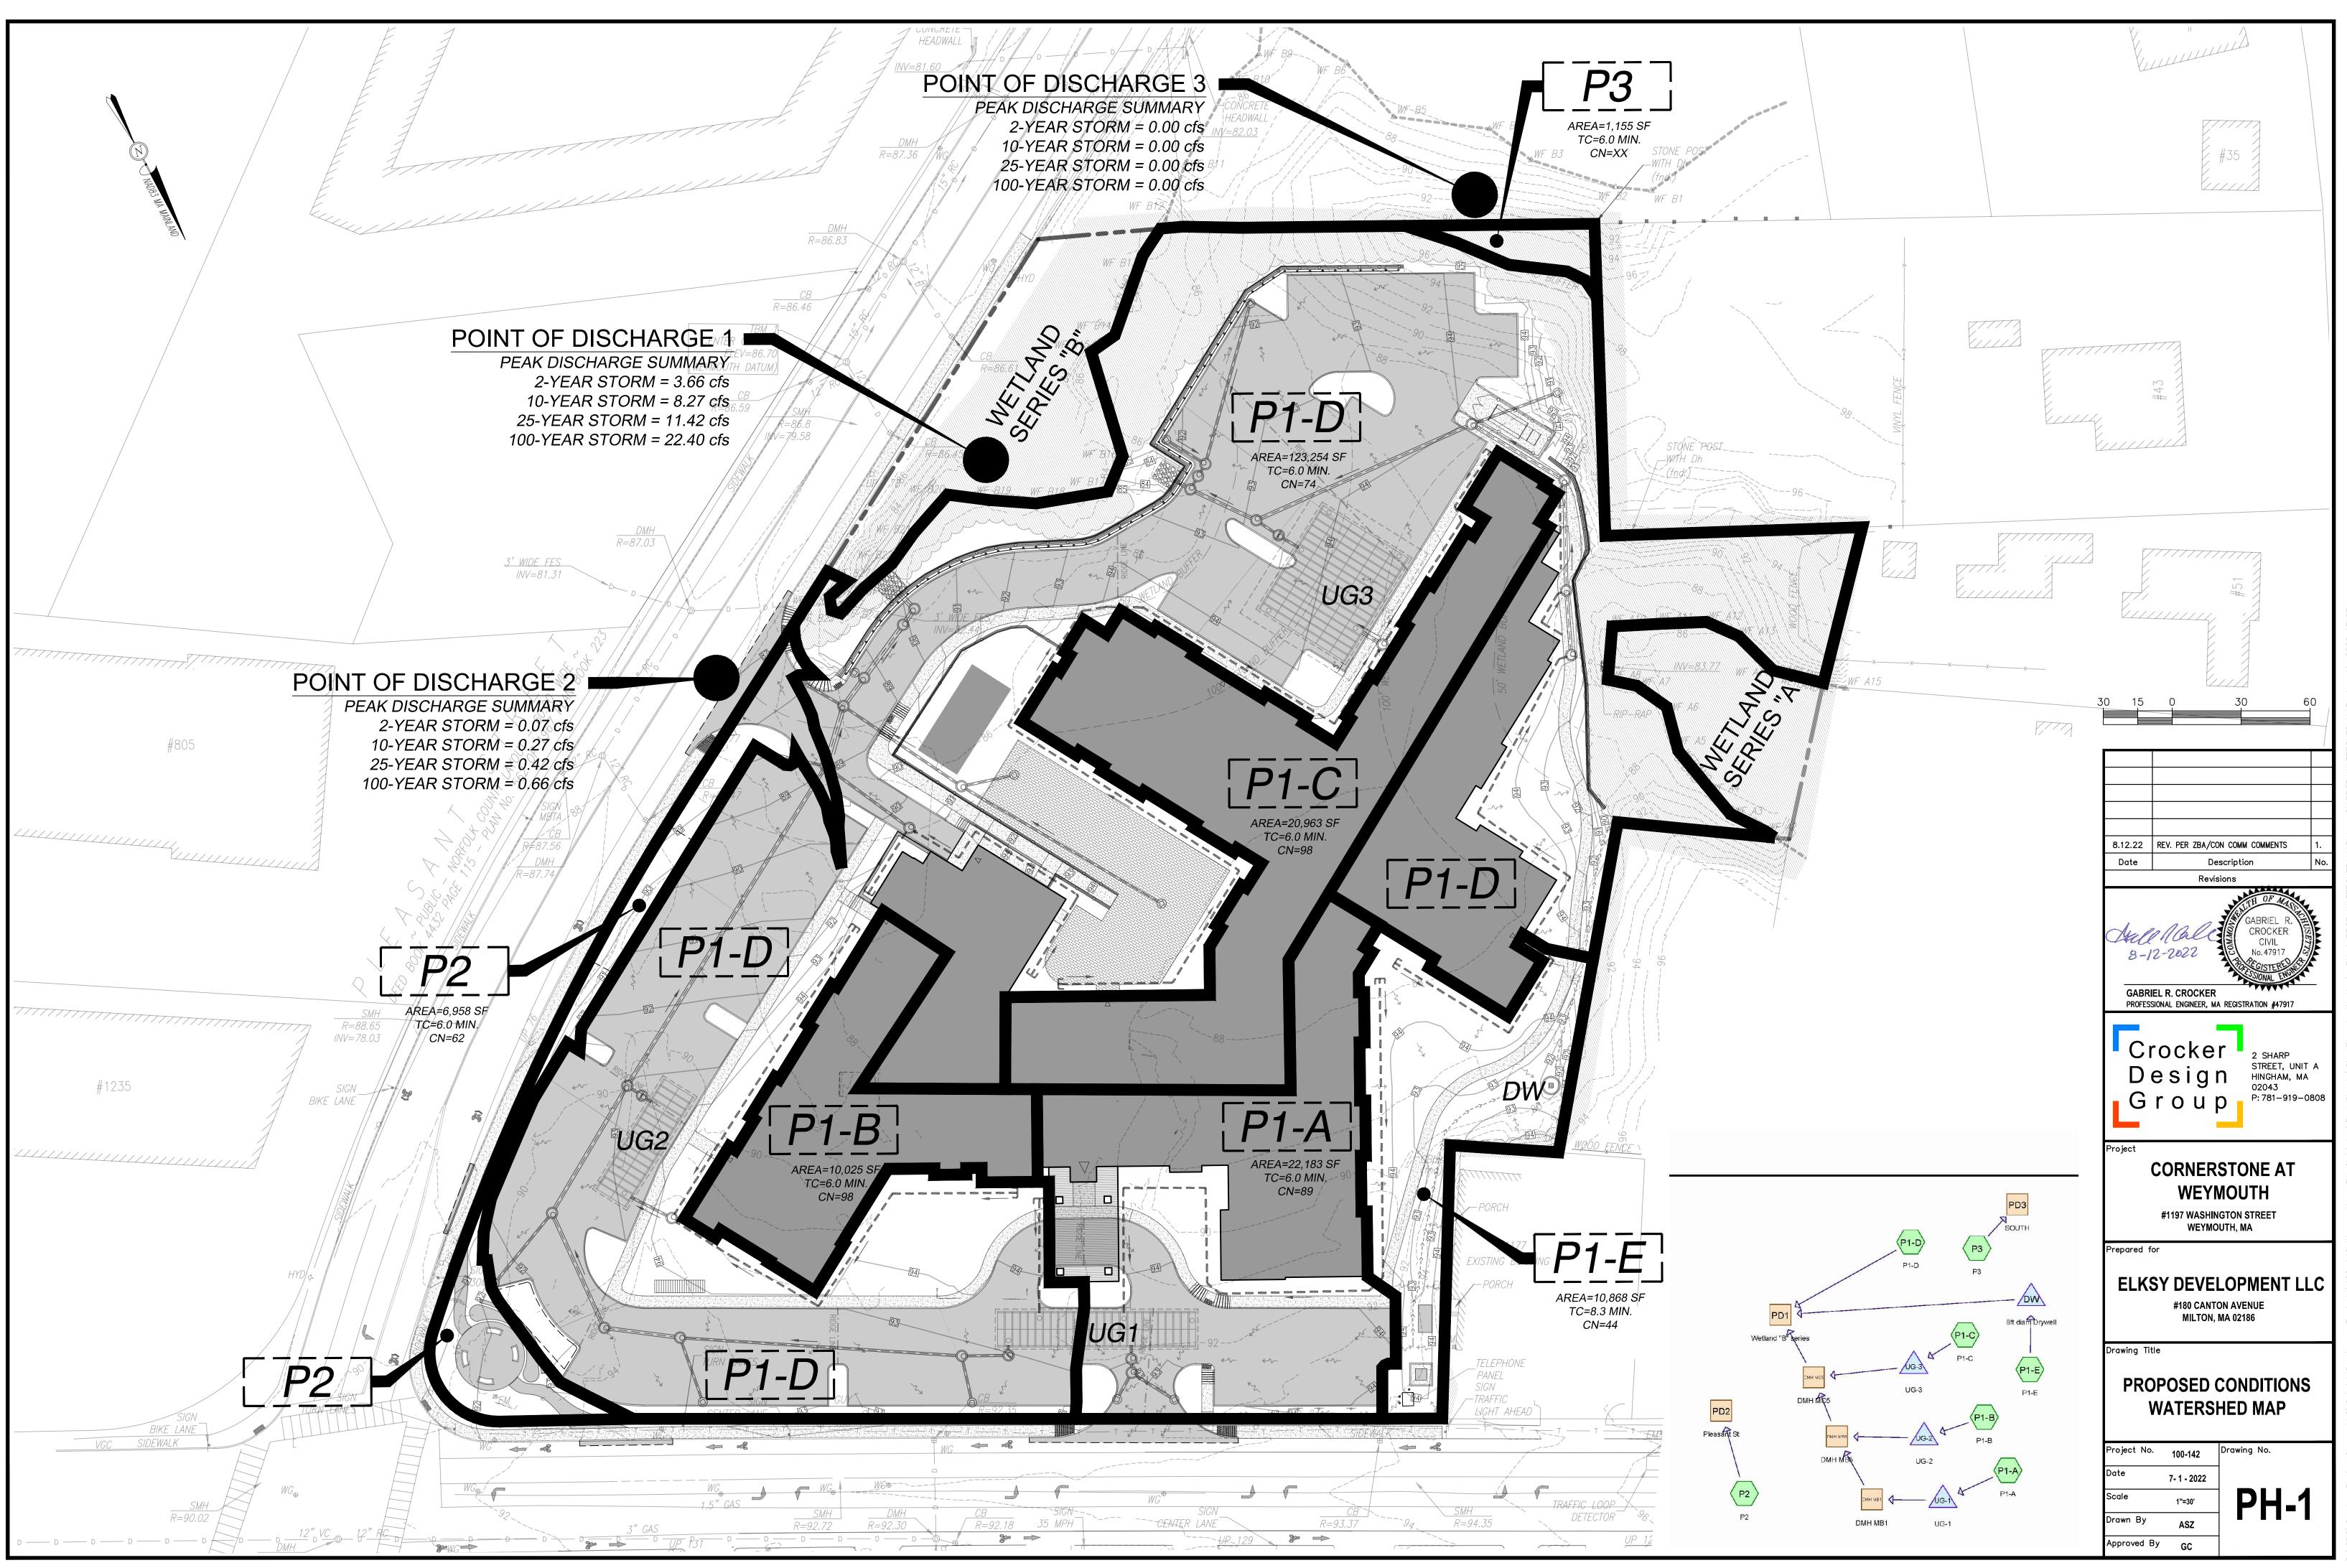

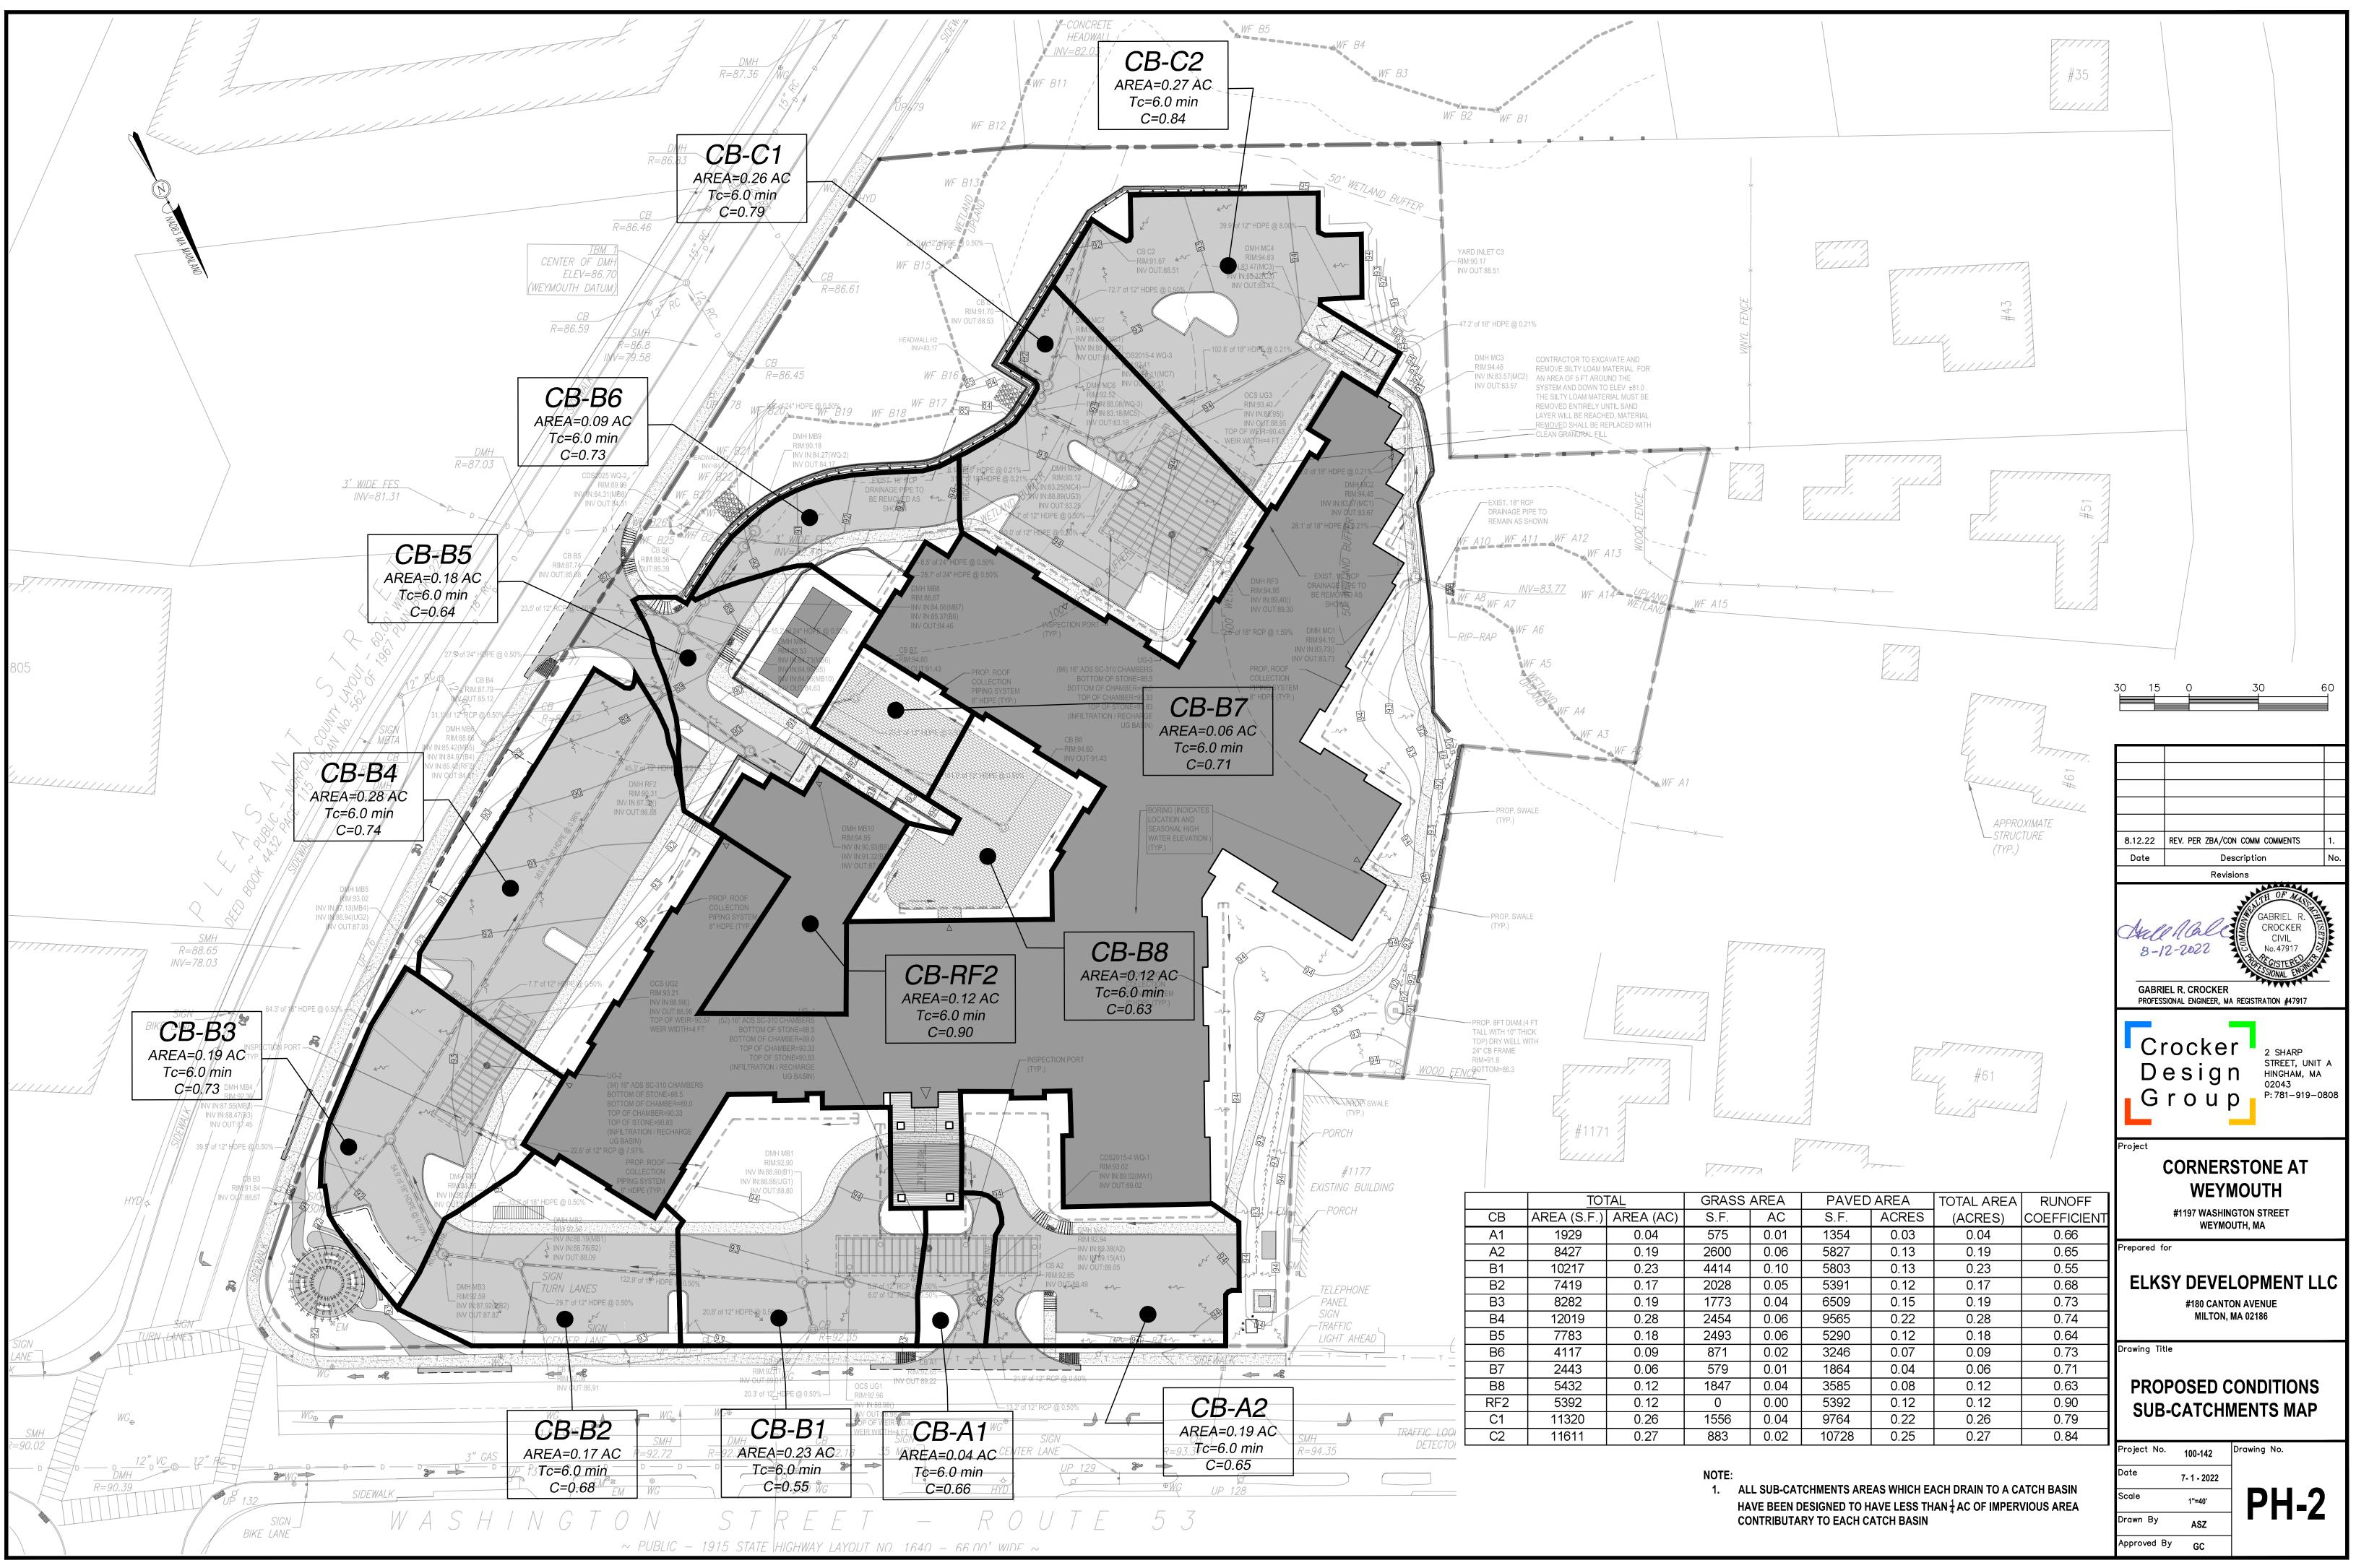


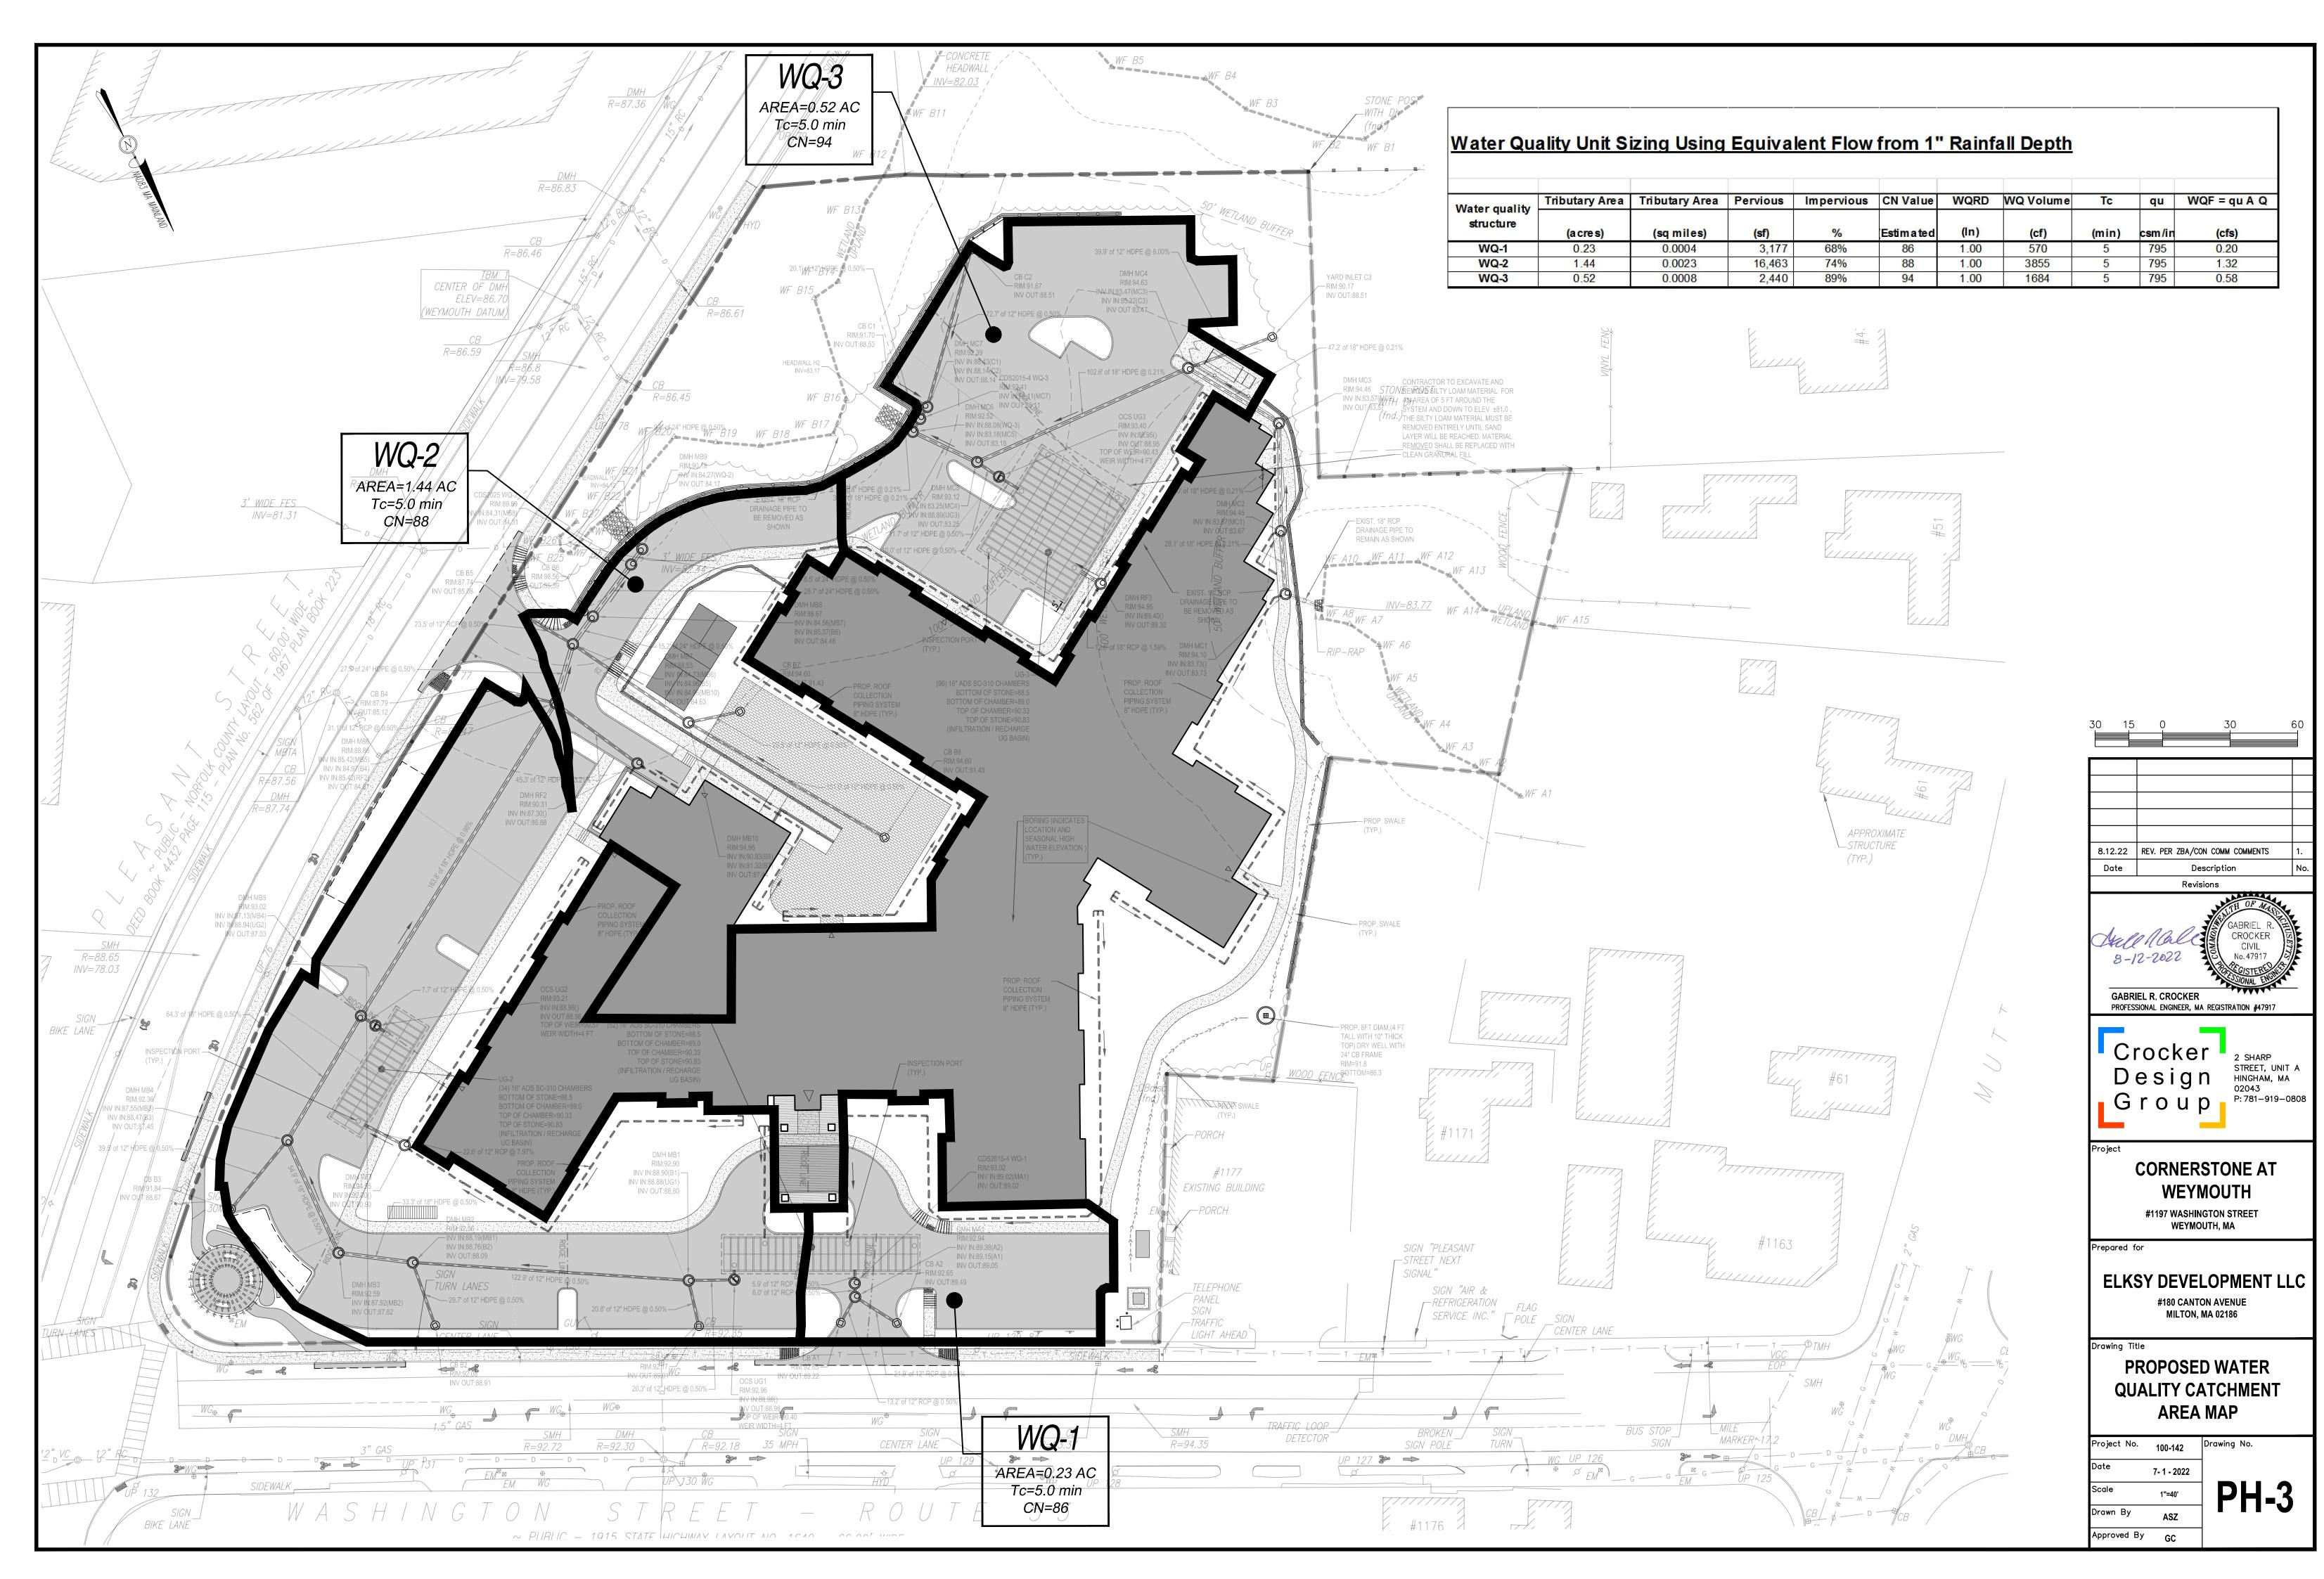

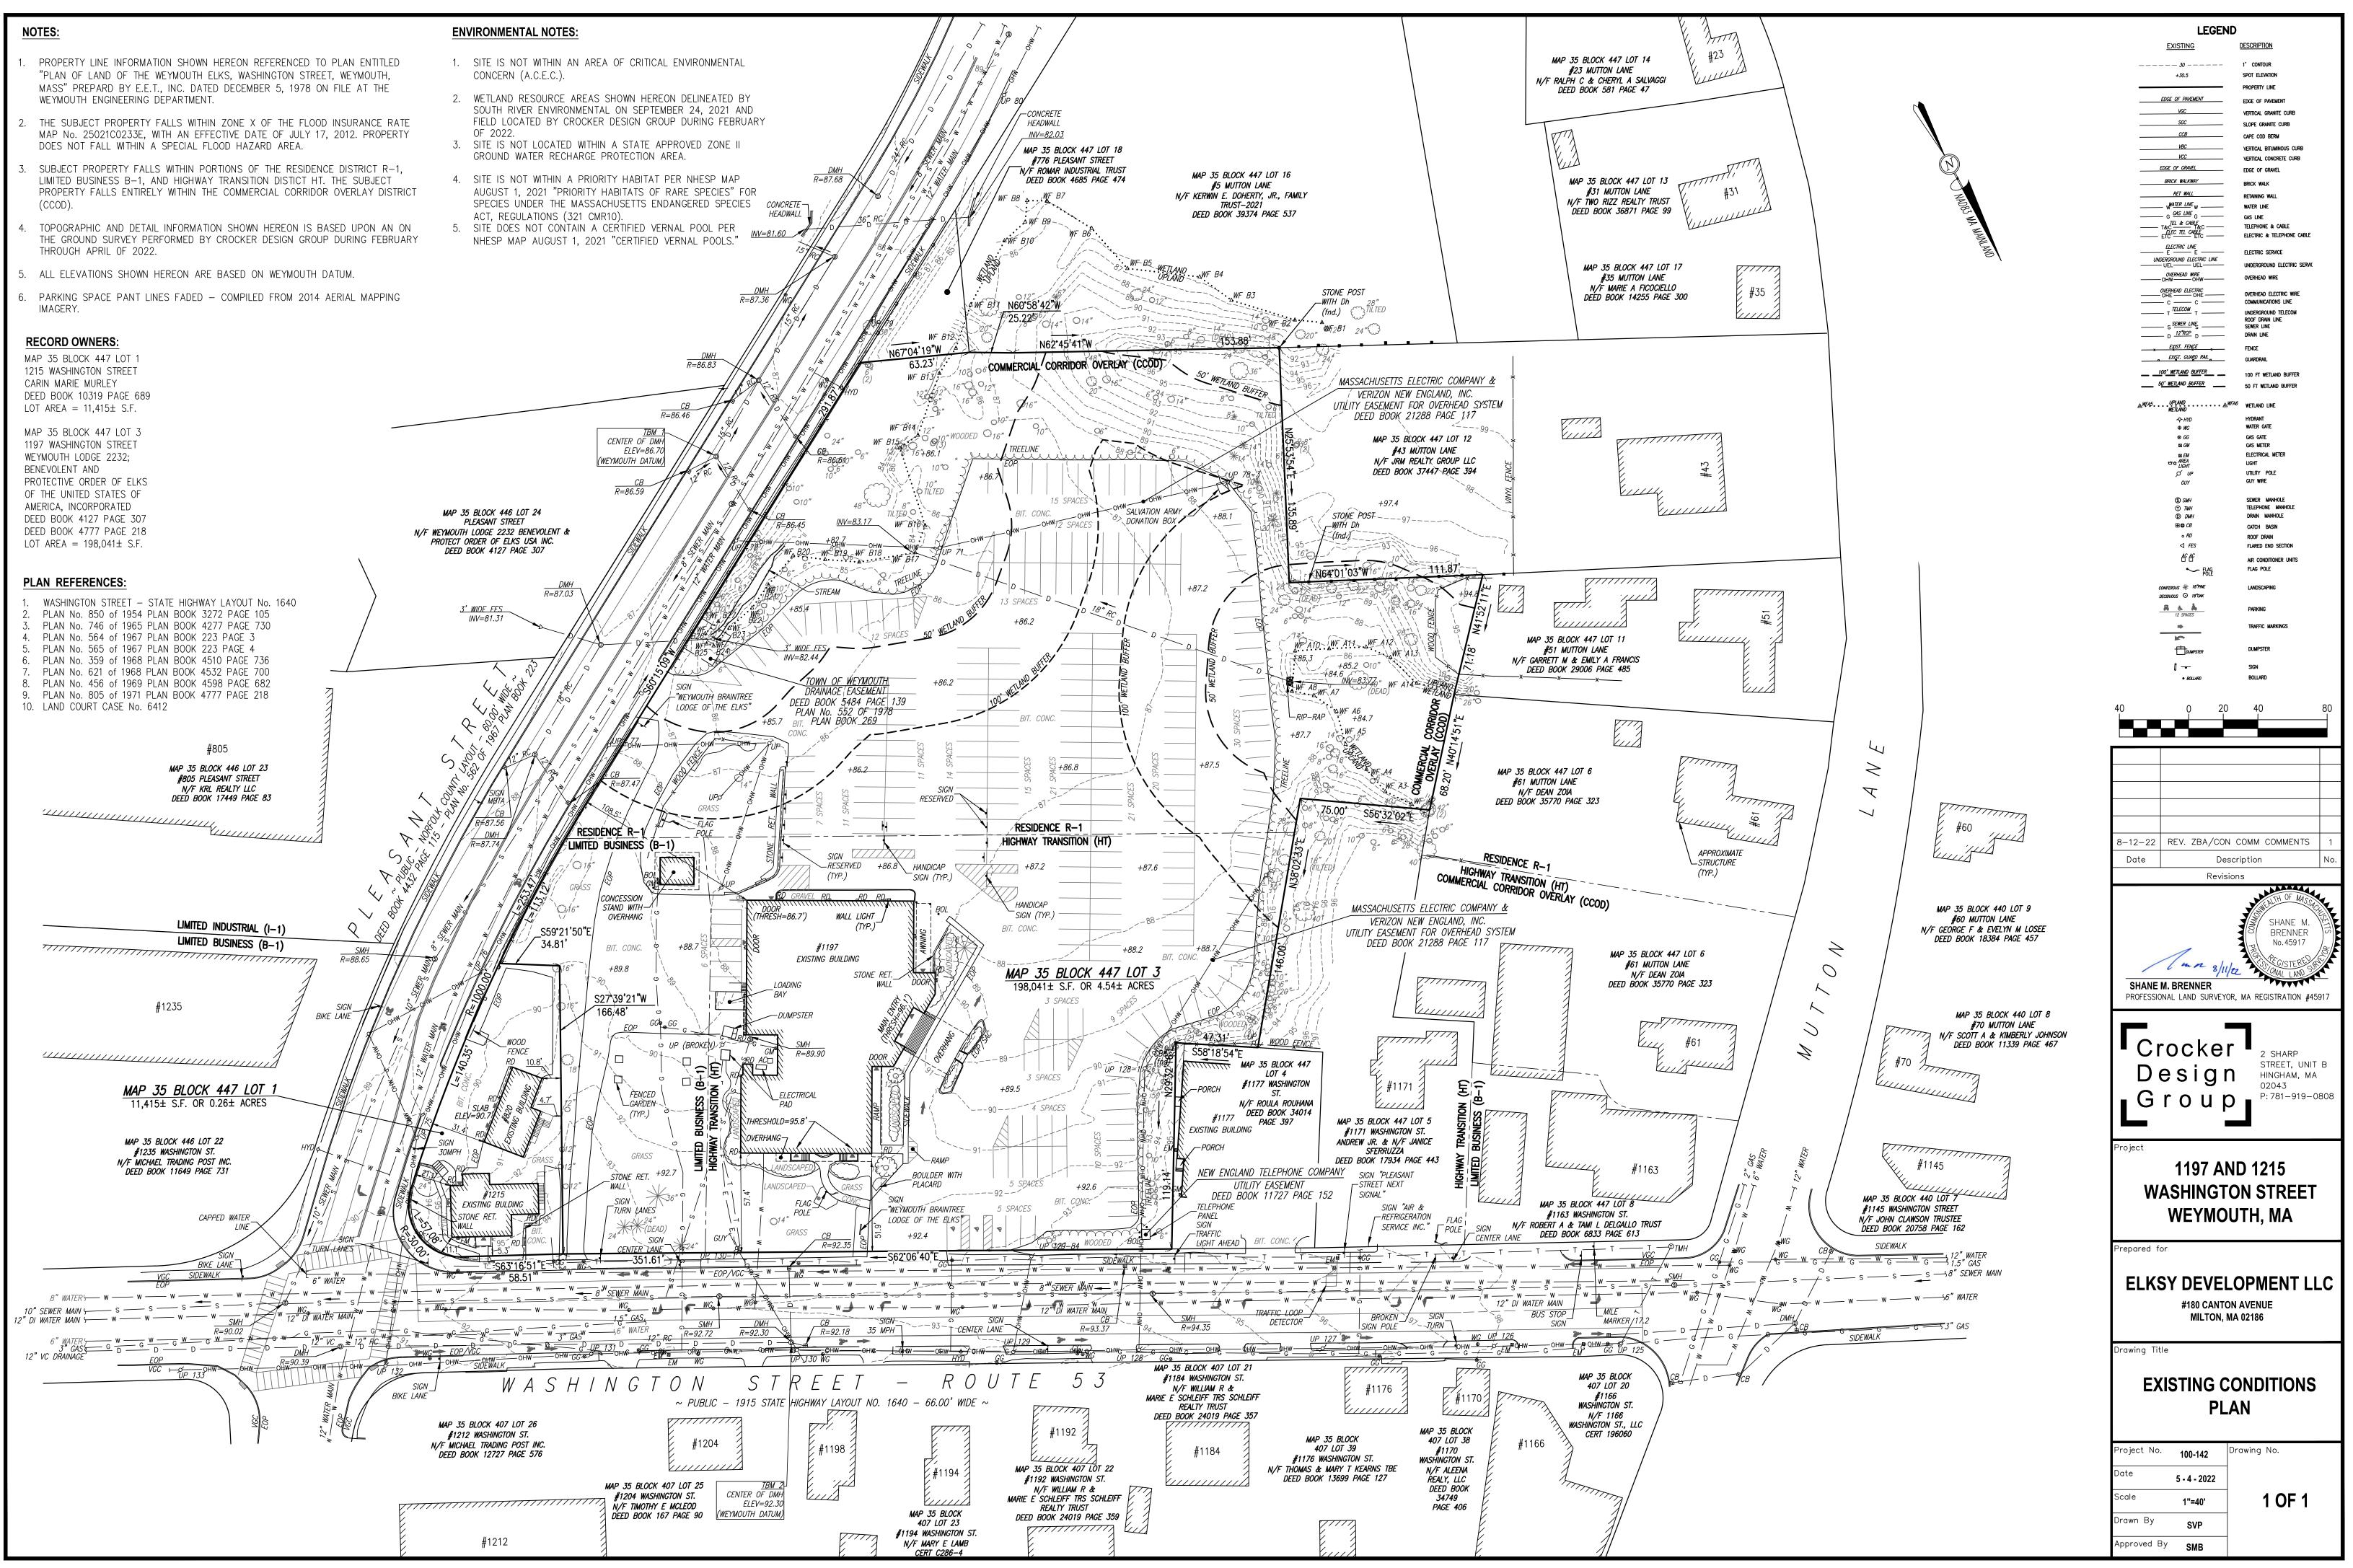

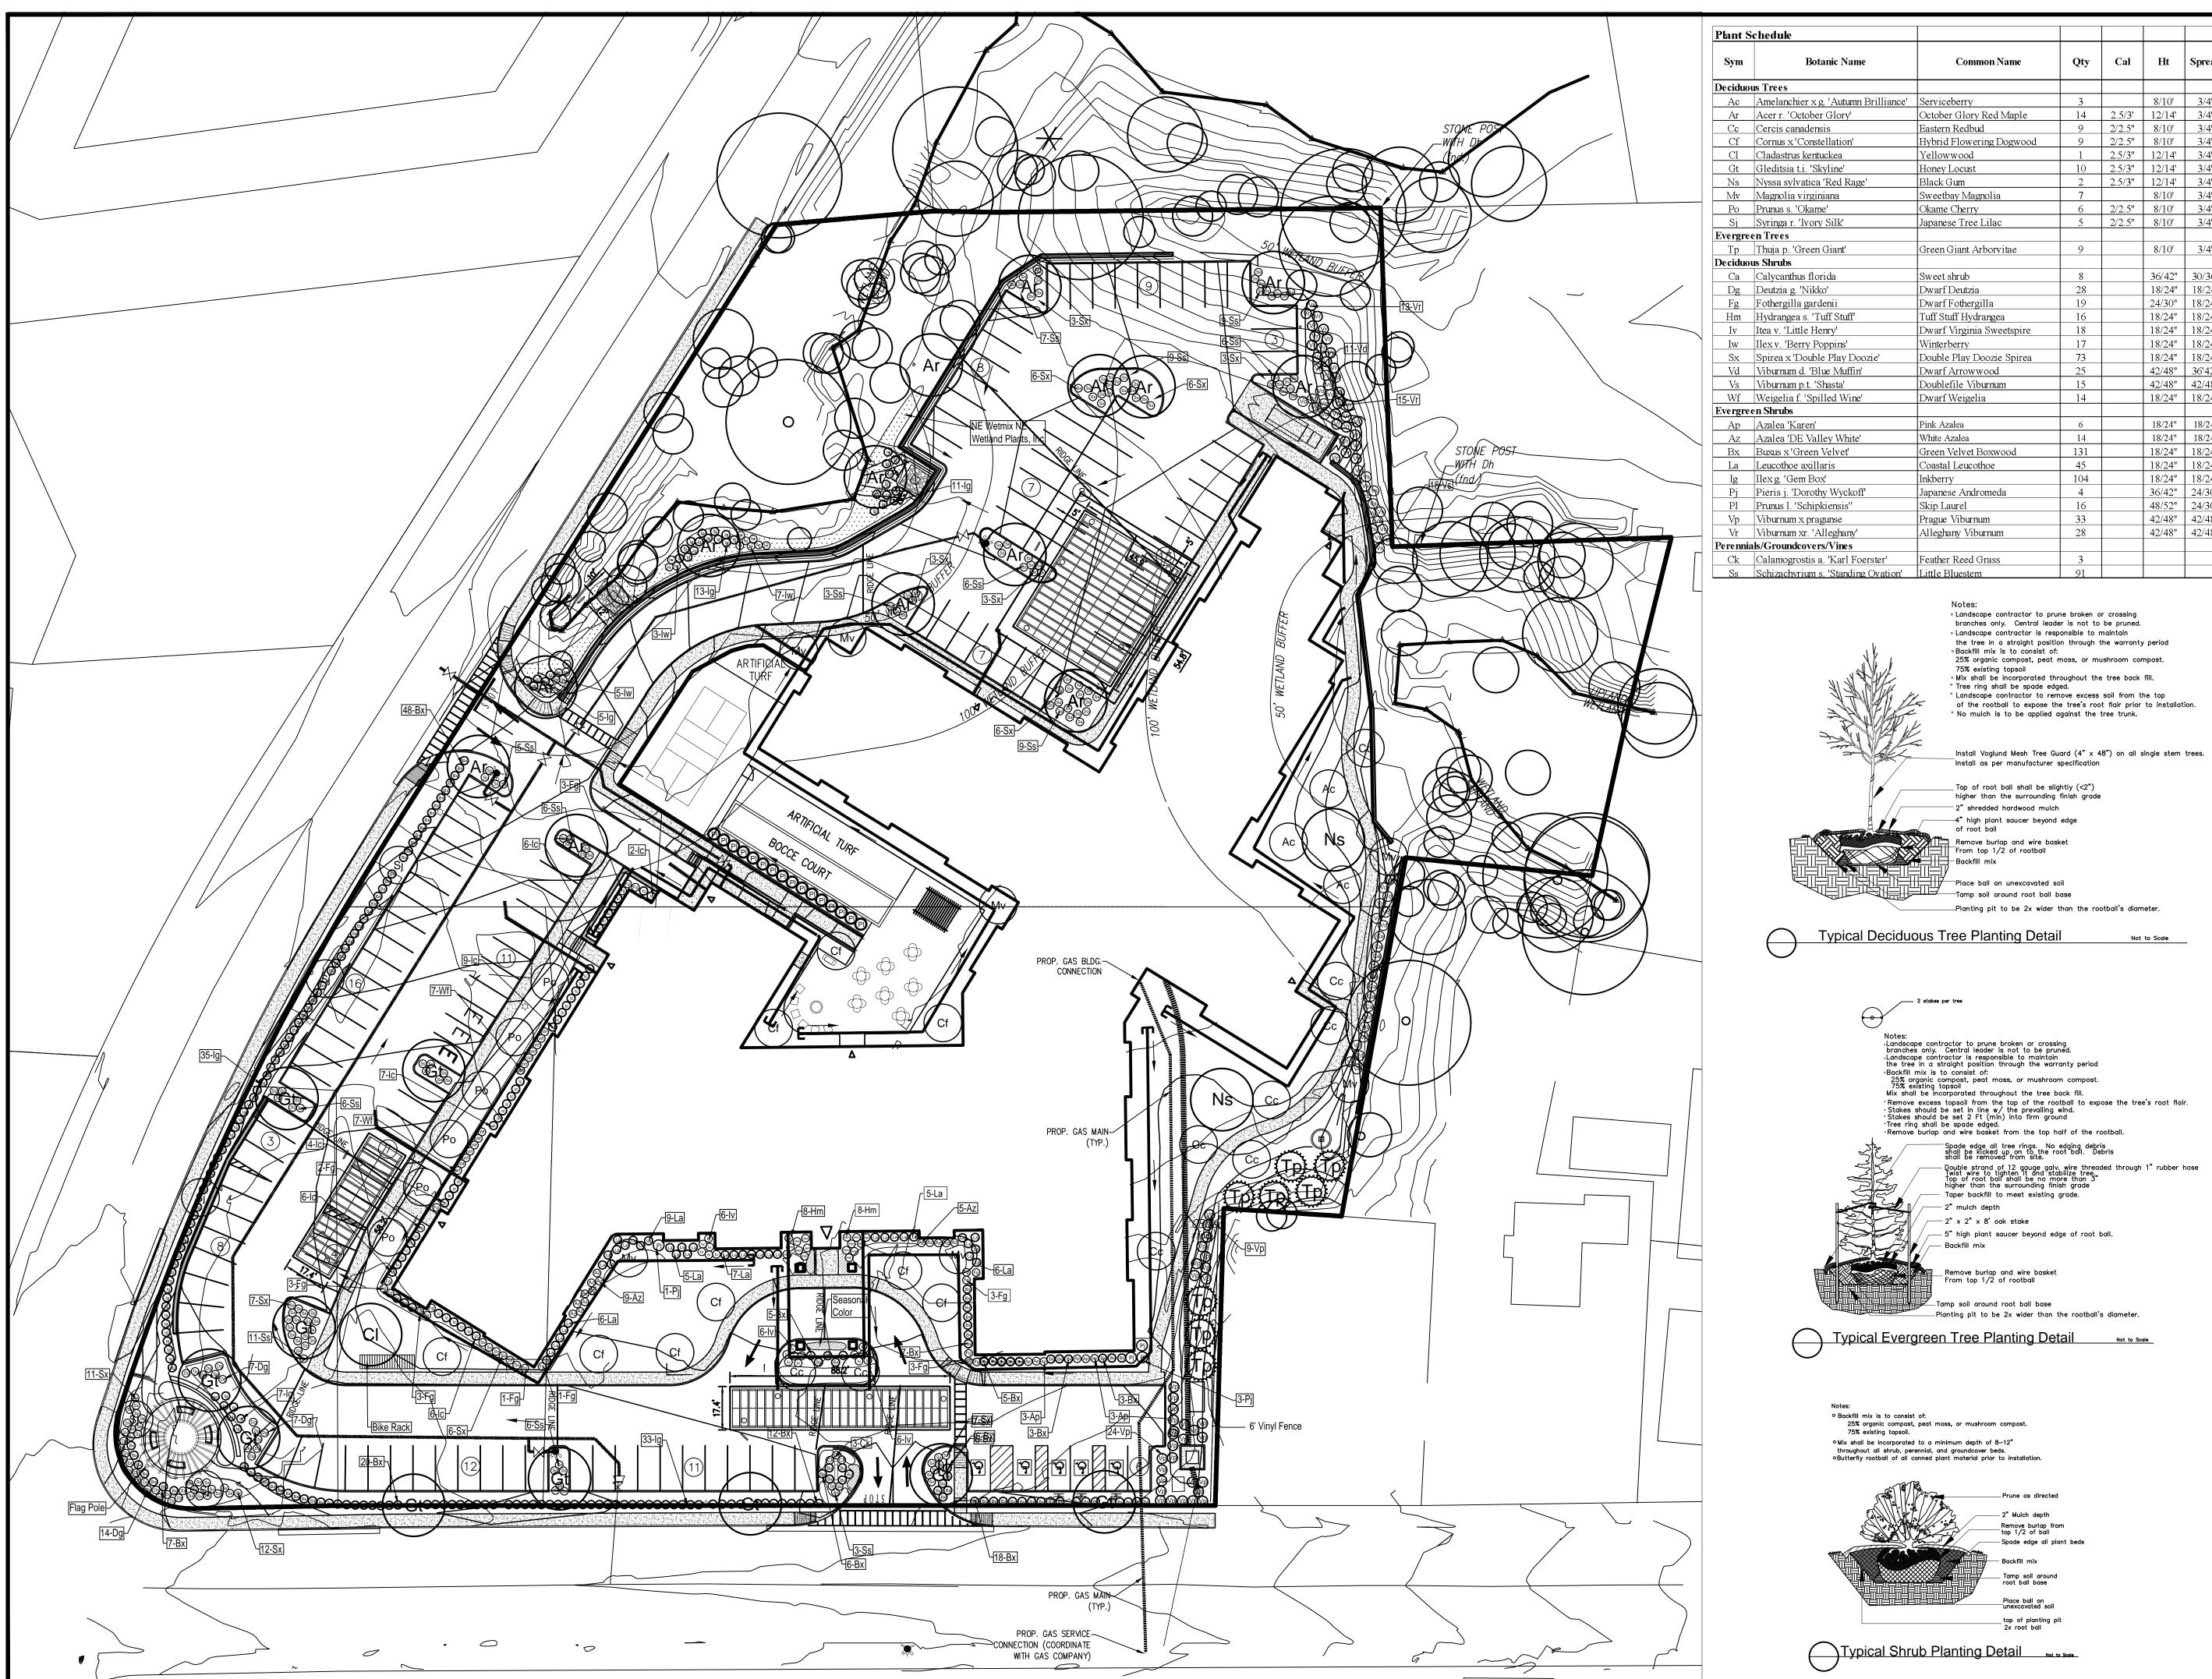

anic Name	Common Name	Qty	Cal	Ht	Spread	Root Condition	Spacing	Mature Size (H x W)	Comments
g. 'Autumn Brilliance'	Serviceberry	3		8/10'	3/4'	B&B	12' min	20' x 15'	Multi-stem (3 stems)
r Glory'	October Glory Red Maple	14	2.5/3'	12/14'	3/4'	B&B	25' min	45' x 30'	ividiti stem (5 stems)
sis	Eastern Redbud	9	2/2.5"	8/10'	3/4'	B&B	12' min	25' x 25'	Single stem
ellation'	Hybrid Flowering Dogwood	9	2/2.5"	8/10'	3/4'	B&B	12' min	20' x '20	Single stem
ıckea	Yellowwood	1	2.5/3"	12/14'	3/4'	B&B	25' min	45' x 30'	Shiple sam
zyline'	Honey Locust	10	2.5/3"	12/14'	3/4'	B&B	25' min	40' x 30'	
'Red Rage'	Black Gum	2	2.5/3"	12/14'	3/4'	B&B	25' min	40' x 30'	male variety only
iiana	Sweetbay Magnolia	7		8/10'	3/4'	B&B	12' min	30' x 20'	Multi-stem (3 stems)
e'	Okame Cherry	6	2/2.5"	8/10'	3/4'	B&B	12' min	20' x15'	
v Silk'	Japanese Tree Lilac	5	2/2.5"	8/10'	3/4'	B&B	12' min	20' x 15'	Single Stem
Giant'	Green Giant Arborvitae	9		8/10'	3/4'	B&B	12' min	35' x 20'	Semi-Sheared
rida	Sweet shrub	8		36/42"	30/36"	Cont.	4'	8'x6'	
ю'	Dwarf Deutzia	28		18/24"	18/24"	Cont.	3'	3'x3'	
lenii	Dwarf Fothergilla	19		24/30"	18/24"	Cont	3'	5'x3'	
uff Stuff	Tuff Stuff Hydrangea	16		18/24"	18/24"	Cont	3'	3'x3'	
enry'	Dwarf Virginia Sweetspire	18		18/24"	18/24"	Cont	3'	4'x4'	
oppins'	Winterberry	17		18/24"	18/24"	Cont	3'	4'x4'	Install 1-Mr. Poppins
e Play Doozie'	Double Play Doozie Spirea	73		18/24"	18/24"	Cont	3'	3'x3'	
ue Muffin'	Dwarf Arrowwood	25		42/48"	36'42"	B&B/Cont	4'	8'x6'	
'hasta'	Doublefile Viburnum	15		42/48"	42/48"	B&B/Cont	4'	8'x8'	
lled Wine'	Dwarf Weigelia	14		18/24"	18/24"	Cont	3'	3'x3'	
	Pink Azalea	6		18/24"	18/24"	Cont	3'	3'x3'	
ley White'	White Azalea	14		18/24"	18/24"	Cont	3'	3'x3'	
Velveť	Green Velvet Boxwood	131		18/24"	18/24"	B&B/Cont	3'	3'x3'	
aris	Coastal Leucothoe	45		18/24"	18/24"	Cont.	3'	3'x3'	
x'	Inkberry	104		18/24"	18/24"	Cont.	3'	3'x3'	
iy Wyckoff	Japanese Andromeda	4		36/42"	24/30"	B&B	4'	8'x8'	
kiensis"	Skip Laurel	16		48/52"	24/30"	Cont.	4'	10'x8'	
gunse	Prague Viburnum	33		42/48"	42/48"	Cont	4'	8'x8'	
lleghany'	Alleghany Viburnum	28		42/48"	42/48"	Cont	4'	8'x8'	
s/Vine s									
ı. 'Karl Foerster'	Feather Reed Grass	3				#3	3'	5'x3'	
s. 'Standing Ovation'	Little Bluestem	91				#2	3'	3'x3'	

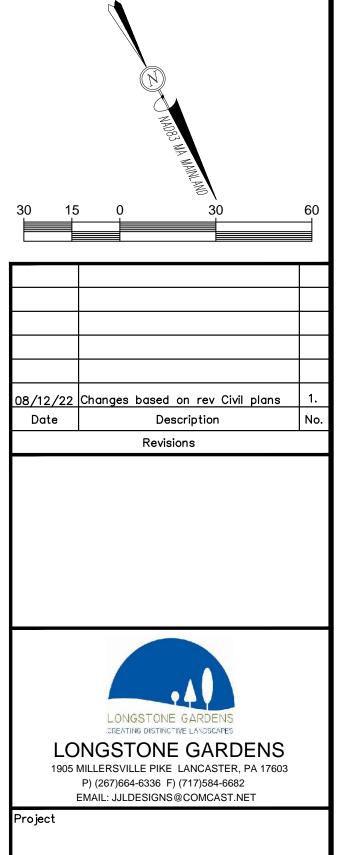

#### **CORNERSTONE AT** WEYMOUTH

Prepared for

**ELKSY DEVELOPMENT LLC** #180 CANTON AVENUE MILTON, MA 02186

Drawing Title

#### LANDSCAPE PLAN

Project No.

Drawn By

Approved By


07 - 01 - 2022 Scale 1" = 30'

JJL

JJL



Drawing No.

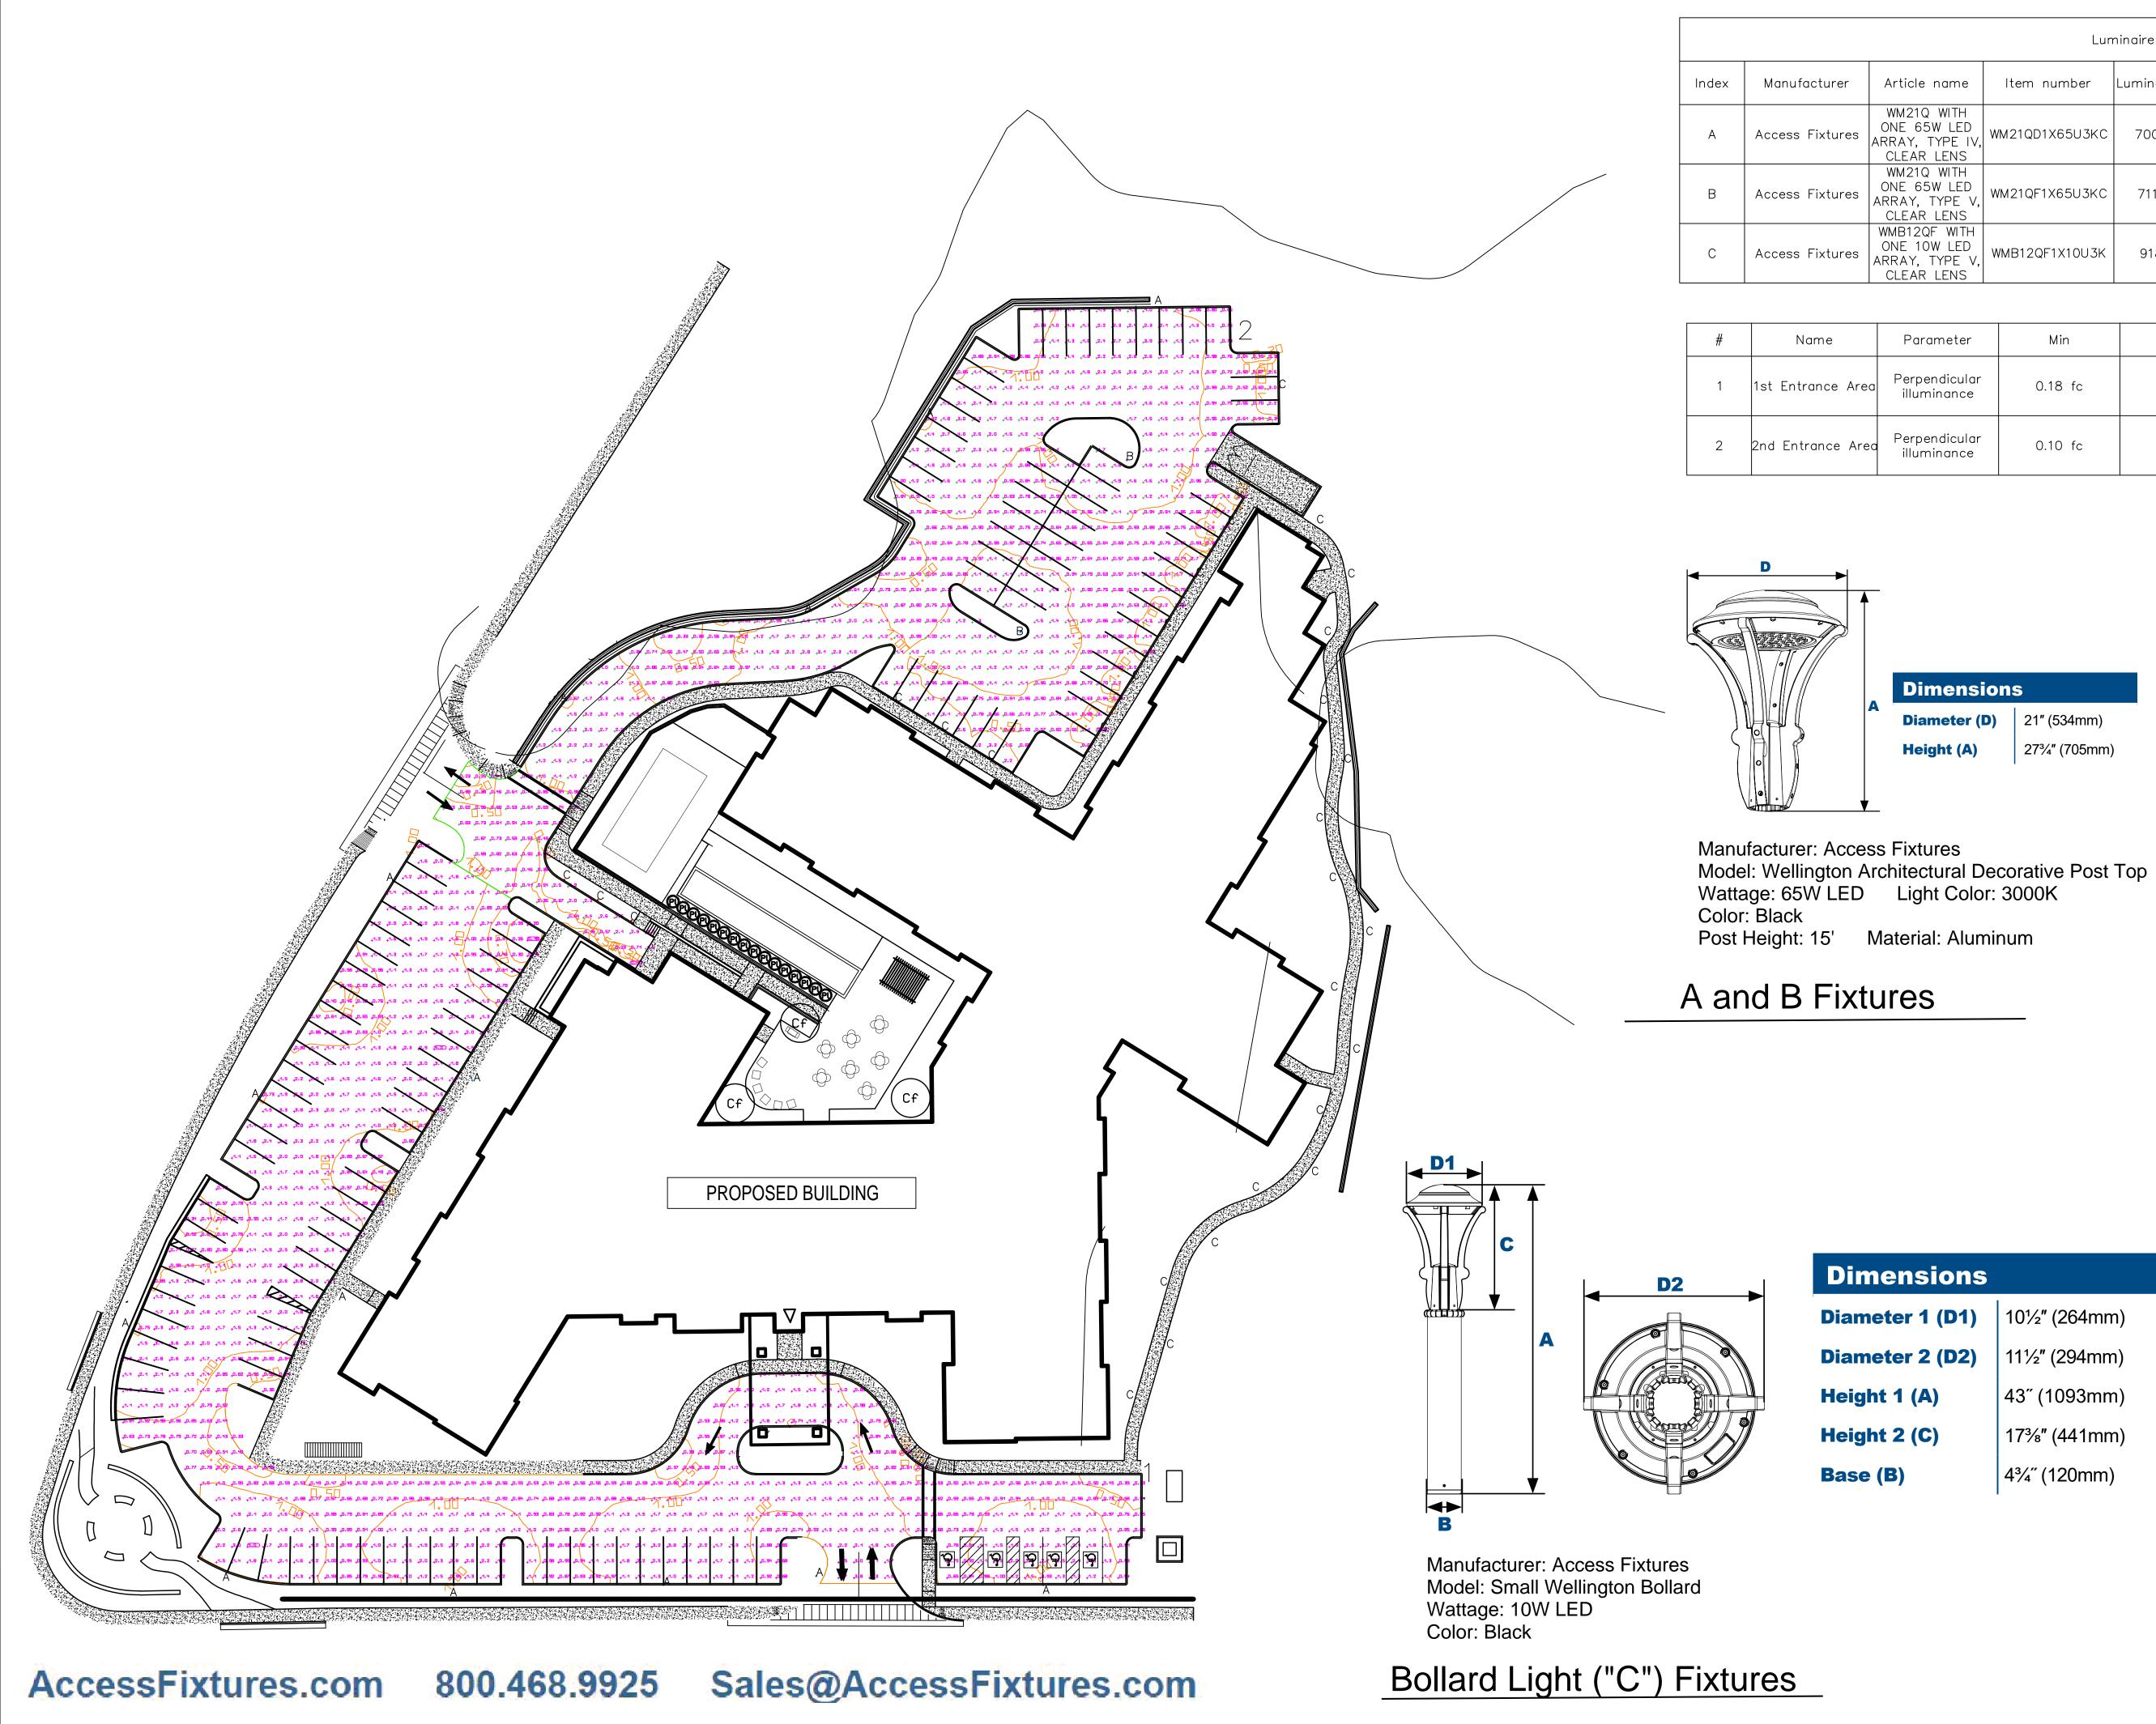

		Lun	ninaire List				
-	Article name	ltem number	Luminous flux	Light loss factor	Connected load	Quantity	Mounting Height
es	WM21Q WITH ONE 65W LED ARRAY, TYPE IV, CLEAR LENS	WM21QD1X65U3KC	7005 lm	0.80	71.3 W	14	15'-0"
es	WM21Q WITH ONE 65W LED ARRAY, TYPE V, CLEAR LENS	WM21QF1X65U3KC	7111 lm	0.80	71.3 W	3	15'-0"
es	WMB12QF WITH ONE 10W LED ARRAY, TYPE V, CLEAR LENS	WMB12QF1X10U3K	918 lm	0.80	10.3 W	28	3'-6"

	Parameter	Min	Max	Average	Mean/Min	Max/Min
Area	Perpendicular illuminance	0.18 fc	3.99 fc	1.34 fc	7.46	22.23
Area	Perpendicular illuminance	0.10 fc	5.35 fc	1.22 fc	11.63	50.95

10½″ (264mm)
11½″ (294mm)
43″ (1093mm)
17³∕₃″ (441mm)
4¾″ (120mm)

