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ANY DEVIATION FROM THESE PLANS
REQUIRING ROCKWOOD DESIGN INC.
TO ACQUIRE STRUCTURAL REDESIGN FOR
BUILDING DEPARTMENT SIGN-OFFS WILL BE
BILLED TO CLIENT ON AN HOURLY BASIS.

SEE SHEET AI FOR DRAWING INDEX

IF PRINTED ON 11X17, ALL SCALE IS HALF.

CONTRACTOR TO VERIFY ALL DIMENSIONS
AND SETBACKS PRIOR TO CONSTRUCTION

OWNER:

BRUCE & DIANE POMPEO-MALTBY
126 WESSAGUSSETT ROAD
WEYMOUTH, MA 02191
CELL: (781)-953-7142
EMAIL: DEEDEE384@COMCAST.NET

DESIGNER:

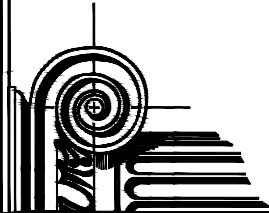
ROCKWOOD DESIGN, INC.
1020 PLAIN STREET - SUITE 320
MARSHFIELD, MA 02050
PHONE: (781)-837-3140
FAX: (781)-837-3126
EMAIL: PHIL@ROCKWOODDESIGN.COM
WEBSITE: WWW.ROCKWOODDESIGN.COM

STRUCTURAL
ENGINEER:

PROGRESS SET - 3/23/2020

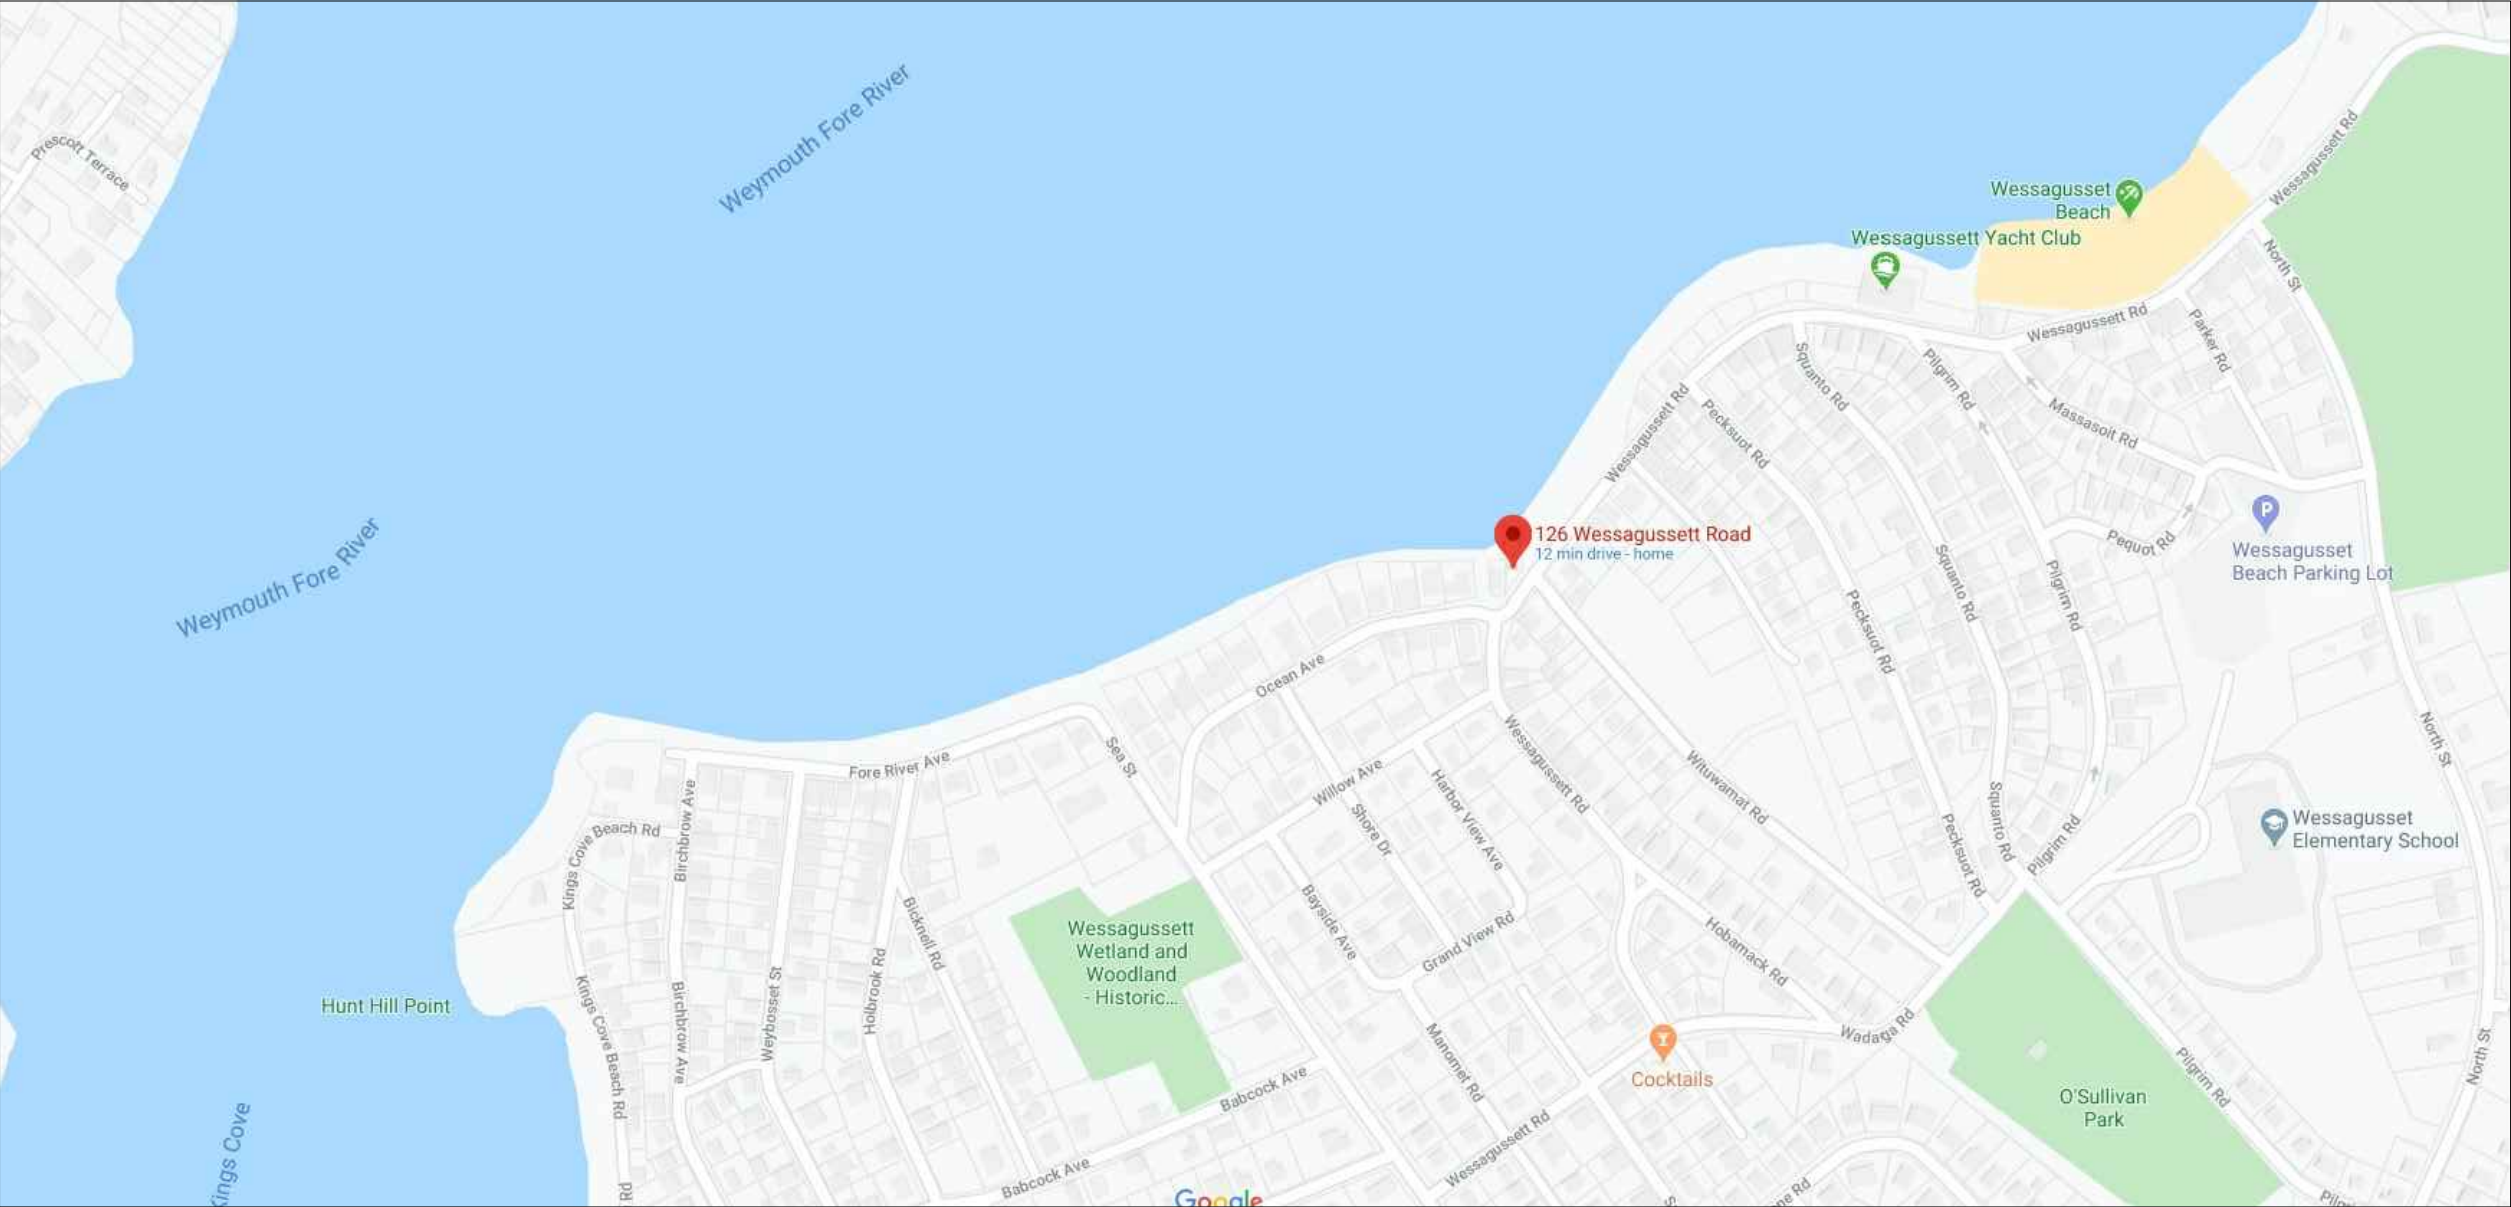
Rockwood
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Website: www.rockwooddesign.com



POMPEO-MALTBY RESIDENCE

126 WESSAGUSSETT ROAD
WEYMOUTH, MA 02191



LOCUS MAP

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GENERAL NOTES:

1. GENERAL CONTRACTOR TO CONFORM TO ALL LOCAL AND STATE BUILDING CODE REQUIREMENTS.
2. GENERAL CONTRACTOR TO VERIFY ALL CONDITIONS AND DIMENSIONS SHOWN ON THE DRAWINGS AND NOTIFY THE ENGINEER OF ANY DISCREPANCIES.
3. THE ENGINEER IS RESPONSIBLE ONLY FOR INFORMATION SHOWN ON THE CERTIFIED ENGINEER'S DRAWINGS. THE DESIGN AND LAYOUT OF ALL OTHER INFORMATION IS THE RESPONSIBILITY OF OTHERS AND MUST CONFORM TO THE MASSACHUSETTS BUILDING CODE REQUIREMENTS. REFER TO STRUCTURAL ENGINEERING BY OTHERS FOR CERTIFIED BEAM CALCULATIONS AND CERTIFIED WIND DESIGN DETAILS.
4. ALL HEATING, PIPING, INSULATION, ELECTRICAL, FIREPROOFING AND OTHER REQUIREMENTS ARE THE RESPONSIBILITIES OF OTHERS.
5. NOTIFY THE ENGINEER OF ANY ARCHITECTURAL MODIFICATIONS OR DIMENSION CHANGES THAT MAY AFFECT THE STRUCTURAL DESIGN.

STRUCTURAL STEEL NOTES:

3. ALL STEEL BEAMS SHALL BE NEW STEEL CONFORMING TO THE A.I.S.C. SPECIFICATIONS FOR DESIGN, FABRICATION AND ERECTION OF STRUCTURAL STEEL FOR BUILDINGS AND A.S.T.M. - GRADE 50. ALL CAP AND BASE PLATES AND OTHER MISCELLANEOUS STEEL MAY BE A.S.T.M. GRADE A36.
2. ALL SCHEDULE 40 PIPE SHALL BE NEW STEEL CONFORMING TO THE A.I.S.C. SPECIFICATIONS FOR DESIGN, FABRICATION AND ERECTION OF STRUCTURAL STEEL FOR BUILDINGS AND A.S.T.M. SPECIFICATION A53, TYPE "E" OR "S", GRADE "B", WITH A MINIMUM YIELD STRESS OF 35 K.S.I.
3. ALL SHOP AND FIELD WELDS SHOWN SHALL BE MADE BY APPROVED CERTIFIED WELDERS AND SHALL CONFORM TO THE A.W.S. CODE FOR BUILDINGS. ALL WELDS SHALL DEVELOP THE FULL STRENGTH OF THE MATERIAL BEING WELDED. USE EXX 10 ELECTRODES.
4. NO PERMANENT CONNECTIONS SHOULD BE MADE UP UNTIL THE STRUCTURE HAS BEEN PROPERLY ALIGNED. PROVIDE TEMPORARY BRACING AS REQUIRED.
5. STEEL FABRICATOR IS RESPONSIBLE FOR FINAL LENGTHS, CONNECTION DETAILS AND DESIGN IN ACCORDANCE WITH THE MINIMUM REQUIREMENTS OF THE LATEST EDITION OF THE A.I.S.C. DETAILING MANUAL. SUBMIT SHOP DRAWINGS WITH ALL DETAILS TO THE GENERAL CONTRACTOR PRIOR TO FABRICATION.
6. USE 1/2" MINIMUM CAP PLATE AND BASE PLATES (6x6 MINIMUM) FULLY WELDED ALL AROUND AT COLUMNS WITH 3/16" FILLET WELD, OR AS OTHERWISE SPECIFIED ON THE DRAWINGS. ALL STEEL COLUMN EXTERIOR BASE PLATE SHALL BE BOLTED TO THE CONCRETE FOUNDATIONS WITH 4-5/8" DIAMETER ANCHOR BOLTS.
7. ALL STEEL SHALL HAVE TWO COATS OF RUST-INHIBITOR PRIMER PAINT. TOUCH UP ALL WELDS, SCRATCHES OR SCRAPES IN PAINT AFTER ERECTION.
8. STEEL BEAM SHALL BE SPICED AT STEEL COLUMN CAP PLATE WITH A MAXIMUM GAP BETWEEN BEAMS OF 1/4". USE 1/4" TIE PLATE WELDED TO WEBS.
9. FRAME JOISTS TO TOP OF BEAM ON A 2x8 TOP NAILER THRU-BOLTED WITH 1/2" DIAMETER BOLTS STAGGERED AT 24" O.C.. JOISTS TO BE ANCHORED TO THE TOP NAILER WITH SIFMSON H4 HURRICANE CLIPS. FLUSH FRAME JOISTS TO THE FULL DEPTH WEB BLOCKING FASTENED TO THE BEAM WITH 1/2" DIAMETER THRU-BOLTS AT 24" O.C. STAGGERED TOP AND BOTTOM.

(WINDOWS SHOWN FOR ESTIMATING AND PERMITTING ONLY
FINAL ORDER TO BE VERIFIED AND APPROVED BY OWNER)

WINDOW SCHEDULE

[illegible]






EXTERIOR DOOR SCHEDULE

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FRAMING NOTES:

1. ALL FRAMING LUMBER SHALL BE HEM-FIR GRADE NO. 2 OR S.P.F. (SPRUCE-PINE-FIR) GRADE NO. 2 OR APPROVED EQUAL (UNLESS OTHERWISE SPECIFIED) AND SHALL MEET THE REQUIREMENTS OF THE AMERICAN FOREST AND PAPER ASSOCIATION. THE MINIMUM ALLOWABLE BENDING STRESS (FB) SHALL BE 1050 P.S.I. THE MINIMUM ALLOWABLE COMPRESSION STRESS (FC) SHALL BE 450 P.S.I. THE MINIMUM ALLOWABLE MODULUS OF ELASTICITY (E) SHALL BE 1,400,000 P.S.I. OTHER FRAMING MATERIAL FOR INTERIOR NON-LOAD BEARING STUDS MAY BE SUBSTITUTED ONLY UPON APPROVAL OF THE ENGINEER.
2. ALL PRESSURE TREATED (CCA TREATED) DIMENSIONAL FRAMING LUMBER SHALL BE SOUTHERN YELLOW PINE GRADE NO. 2. THE MINIMUM ALLOWABLE BENDING STRESS (FB) SHALL BE 1,050 P.S.I. THE MINIMUM ALLOWABLE COMPRESSION STRESS (FC) SHALL BE 565 P.S.I. THE MINIMUM ALLOWABLE MODULUS OF ELASTICITY (E) SHALL BE 1,600,000 P.S.I.
3. ALL LVLs TO BE MANUFACTURED BY TRUS JOIST, GEORGIA PACIFIC OR APPROVED EQUAL. THE MINIMUM ALLOWABLE BENDING STRESS (FB) SHALL BE 2,300 P.S.I. THE MINIMUM ALLOWABLE COMPRESSION STRESS (FC) PERPENDICULAR TO THE GRAIN SHALL BE 150 P.S.I. THE MINIMUM ALLOWABLE MODULUS OF ELASTICITY (E) SHALL BE 2,000,000 P.S.I. ALL PARALAMs EXPOSED TO THE WEATHER SHALL BE PRESSURE TREATED (CCA TREATED). INSTALL MICROLAMs AND PARALAMs IN ACCORDANCE WITH THE MANUFACTURER'S INSTRUCTIONS.
4. USE 3/4" TONGUE AND GROOVE STRUCTURAL GRADE FIR PLYWOOD FLOOR SHEATHING, 5/8" EXTERIOR STRUCTURAL GRADE FIR (C.D.X.) PLYWOOD ROOF SHEATHING AND 1/2" EXTERIOR STRUCTURAL GRADE FIR (C.D.X.) AT WALLS. ALL JOINTS SHALL BE BLOCKED WITH LUMBER OR OTHER APPROVED SUPPORTS.
5. ALL EXTERIOR AND INTERIOR STUD WALLS TO BE 2x4 MINIMUM @ 16" O.C. UNLESS NOTED OTHERWISE.
6. PROVIDE ADEQUATE WALL RESISTANCE TO RAKING BY DIAGONAL CORNER WIND BRACING ANCHORED TO SILL PLATES.
7. PROVIDE SOLID BLOCKING BETWEEN FLOOR JOISTS AND/OR DOUBLE ALL JOISTS UNDER EACH PARTITION.
8. USE FULLY NAILED METAL CONNECTORS (TECO, SIMPSON OR EQUAL) JOIST OR BEAM HANGERS WHEN JOISTS OR BEAMS FRAME INTO OTHER JOISTS OR BEAMS. PROVIDE METAL FOOT CAPS AND BASES FOR ALL POSTS.
9. FOR NONBEARING ROUGH WINDOW OPENINGS AND INTERIOR DOOR OPENINGS UP TO 3 FEET, USE 2-2x6 HEADER BEAMS. FROM 3 FEET TO 5 FEET, USE 2-2x8 HEADER BEAMS AND FROM 5 FEET TO 1 FEET, USE 2-2x10 HEADER BEAMS AND USE LVLS FOR SPANS EXCEEDING 1 FEET, EXCEPT AS NOTED OTHERWISE ON THE PLANS OR SPECIFICATIONS. USE TRIFLES FOR 2x6 WALLS. IF LVLS ARE SPECIFIED ON THE PLANS, PROVIDE DOUBLE JACK STUD SUPPORTS OR AS OTHERWISE SPECIFIED ON THE PLAN.
10. ALL FRAMING TO BE INSTALLED IN ACCORDANCE WITH THE MASSACHUSETTS BUILDING CODE REQUIREMENTS AND GENERAL FRAMING PRACTICE AS DETAILED IN THE "ARCHITECTURAL GRAPHICS STANDARDS", BY RAMSEY & SLEEPER.
11. ALL PLYWOOD FLOOR SHEATHING SHALL BE GLUED TO SUPPORTING WOOD FRAMING MEMBERS USING AMERICAN PLYWOOD ASSOCIATION (A.P.A.) GLUED FLOOR SYSTEM. WOOD GLUE TO BE CONTECH, INC. PL400 SUBFLOOR CONSTRUCTION ADHESIVE, OR APPROVED EQUAL.
12. ALL WALL STUDS TO ALIGN WITH FLOOR JOISTS AND ROOF RAFTERS.
13. THE CROSS WALLS AND TIE BEAMS ARE TO PROVIDE THE LATERAL RESTRAINT FOR THE BUILDINGS AND SHOULD BE SECURELY ATTACHED AT EACH END AND/OR TO THE EXTERIOR WALLS.
14. BUILT-UP BEAMS (3 PIECES MAXIMUM) USING CONVENTIONAL FRAMING LUMBER SHALL BE FULLY SPIKED TOGETHER WITH 2-16D NAILS AT 8" O.C. AND LVLS WITH 2-16D NAILS (TOP AND BOTTOM) AT 8" O.C., OR AS OTHERWISE NOTED ON THE DRAWINGS, OR AS RECOMMENDED BY THE MANUFACTURER.
15. ALL NAILS, FASTENERS AND CONCRETE EXPOSED TO THE WEATHER SHALL BE HOT-DIP GALVANIZED.
16. ALL LUMBER THAT COMES IN CONTACT WITH CONCRETE SHALL BE PRESSURE TREATED.

FLOOR PLAN LEGEND:

WALL TO BE DEMOLISHED	
EXISTING STUD WALL	
PROPOSED STUD WALL	
OBJECT ABOVE	
OBJECT BELOW	

PROPOSED SQUARE FOOTAGE NOTE:

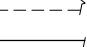
FIRST FLOOR LIVING AREA = 702 FT²
SECOND FLOOR LIVING AREA = 792 FT²
ATTIC FLOOR LIVING AREA = 529 FT²
TOTAL LIVING AREA: = 2,023 FT²

DRAWING INDEX:

A0	COVER PAGE
A1	NOTES AND LEGENDS
A2	EXTERIOR ELEVATIONS
A2.1	EXTERIOR ELEVATIONS
A3	FIRST FLOOR PLAN
A4	SECOND FLOOR PLAN
A5	ATTIC FLOOR PLAN
A6	ROOF PLAN
A7	BUILDING SECTION "A"
A8	BUILDING SECTION "B"
A9	BUILDING SECTION "C"
S1	CONCRETE PIER PLAN

FOUNDATION NOTES/LEGEND:

- 1) SEE "STRUCTURAL ENGINEERING AND WFCM ANALYSIS" BOOKLET NO. 20-____ BY _____ ENGINEERING, LLC DATED MARCH/____/2020 FOR ADDITIONAL NOTES AND DETAILS.
- 2) ALL NEW FOUNDATION WALLS SHALL BE DAMP PROOFED WITH A BITUMINOUS COATING.
- 3) 6 SQ. FT. OF VENTILATION REQUIRED FOR EVERY 1,500 SQ. FT. OF BASEMENT AREA.
- 4) OPENING FOR UNDER-FLOOR VENTILATION: 1 SQ. FT. OPENING/150 SQ. FT. OF CRAWL SPACE AREA


 DENOTES FOUNDATION WALL
TO BE DEMOLISHED
 DENOTES EXISTING
FOUNDATION WALL
 DENOTES PROPOSED
FOUNDATION WALL ATOP FOOTING
 DENOTES PROPOSED LOW
FOUNDATION WALL w/2x6 STUD WALL ATOP

DENOTES ARCHITECTURAL BUILDING SECTION

DENOTES DETAIL IN "STRUCTURAL ELEMENTS"
BOOKLET BY STRUCTURAL ENGINEER

FOUNDATION & CONCRETE NOTES:

1. SPREAD FOOTINGS SHALL BEAR LEVEL ON UNDISTURBED SOIL HAVING AN ALLOWABLE BEARING CAPACITY OF TWO TONS PER SQUARE FOOT.
2. IF BEARING MATERIALS WITH A LOWER BEARING CAPACITY THAN TWO TONS PER SQUARE FOOT ARE ENCOUNTERED AT THE SPECIFIED ELEVATIONS, THE UNDERLYING UNSUITABLE MATERIAL SHALL BE REMOVED AND REPLACED WITH SUITABLE MATERIAL TO BE APPROVED BY THE ENGINEER/ARCHITECT.
3. THE ENGINEER ASSUMES NO RESPONSIBILITY FOR THE VALIDITY OF SUBSURFACE CONDITIONS.
4. NO FOUNDATION SHALL BE PLACED IN WATER OR ON FROZEN GROUND.
5. FOOTINGS SHALL BE PROTECTED AGAINST FROST UNTIL PROJECT IS COMPLETED.
6. BACKFILL UNDER ANY PORTION OF THE FOOTINGS AND SLABS SHALL BE COMPACTED IN 6" LIFTS OF 95% COMPACTED GRAVEL AS APPROVED BY THE ENGINEER.
7. CONCRETE WORK SHALL CONFORM TO THE LATEST AMERICAN CONCRETE INSTITUTE CODE FOR "BUILDING CODE REQUIREMENTS FOR REINFORCED CONCRETE" AND "SPECIFICATIONS FOR STRUCTURAL CONCRETE FOR BUILDINGS".
8. CONCRETE FOUNDATION WALLS AND FOOTINGS SHALL HAVE A MINIMUM COMPRESSIVE STRENGTH OF 3,000 P.S.I. AT 28 DAYS AND 3,500 P.S.I. FOR SLABS, WITH A SLUMP OF NO MORE THAN 4" AND AIR ENTRAINMENT OF 4-6%. THE USE OF CALCIUM CHLORIDE IS NOT PERMITTED. PROVIDE PROPER CONCRETE PROTECTION FOR HEAT IN COLD WEATHER AND MAINTAIN PROPER CURING PROCEDURES IN ACCORDANCE WITH THE A.C.I.
9. STEEL REINFORCEMENT SHALL CONFORM TO A.S.T.M. 615, GRADE 60.
10. ALL CONCRETE SLABS ON THE GROUND SHALL BE REINFORCED WITH 6X6-10/10 (MIN.) WELDED WIRE FABRIC PLACED AT MID-DEPTH, OR AS OTHERWISE SHOWN ON THE DRAWINGS. WELDED WIRE FABRIC REINFORCEMENT SHALL CONFORM TO A.S.T.M. A185, AND SHALL LAP 6" MINIMUM OR ONE SPACE, WHICHEVER IS LARGER, AND SHALL BE WIRED TOGETHER. PROVIDE SUFFICIENT CHAIR OR SUPPORT BARS AS NECESSARY TO POSITION WELDED WIRE FABRIC.
11. WHERE CONTINUOUS BARS ARE CALLED FOR THEY SHALL BE RUN CONTINUOUSLY AROUND CORNERS AND LAPPED AT NECESSARY SPICES OR HOOKED AT DISCONTINUOUS ENDS. LAPS SHALL BE 40 BAR DIAMETERS, UNLESS OTHERWISE SHOWN.
12. NOTIFY BUILDING DEPARTMENT FOR INSPECTION OF COMPLETED INSTALLATION OF REINFORCEMENT AT LEAST 24 HOURS PRIOR TO SCHEDULED PLACEMENT OF CONCRETE.
13. PLACEMENT OF CONCRETE POURS FOR FOUNDATION WALLS SHOULD HAVE A VERTICAL 2"x4" KEY WITH CONTINUOUS REINFORCING (40 BAR DIAMETER MINIMUM) THRU THE CONSTRUCTION JOINT.
14. ALL REINFORCING BARS SHALL BE COLD BENT IN ACCORDANCE TO THE PROPER RADI ESTABLISHED BY THE AMERICAN CONCRETE INSTITUTE. UNDER NO CONDITIONS SHALL HEAT BE APPLIED TO THE BARS TO OBTAIN BENDS.
15. THE USE OF CONTROL JOINTS IN THE SLAB IS RECOMMENDED TO CONTROL CRACKING. SAW CUT TO A DEPTH ONE HALF INCH NOT-TO-EXCEED 10 FEET BY 10 FEET.
16. DAMP PROOF ALL FOUNDATION WALLS BELOW GRADE, OTHER THAN FROST WALLS.

FRAMING NOTES/LEGEND:

- 1) SEE "STRUCTURAL ENGINEERING AND WFCM ANALYSIS"
BOOKLET NO. 20-___ BY _____ ENGINEERING, LLC
DATED MARCH/___/2020 FOR ADDITIONAL NOTES AND DETAILS
- 2) ALL FRAMING MEMBERS SHALL BE FASTENED IN ACCORDANCE WITH MANUFACTURER'S
RECOMMENDATIONS AND THE COMMONWEALTH OF MASSACHUSETTS 180 CMR


LAMINATED POST
 DOUGLAS FIR
 POST SIZE
 JACK STUDS
 KING STUDS
 POST UP:
 SEE FRAMING PLAN
 OF FLOOR ABOVE
 FOR TYPE AND SIZE

METAL HANGERS
 STEEL BEAM
 LVL BEAM
 BEARING WALL
 BEARING WALL ABOVE
 FRAMING BELOW
 EXISTING FRAMING
 PROPOSED FRAMING
 SMOKE DETECTOR
 SMOKE/CO₂
 HEAT SMOKE

[illegible]

NOTES AND LEGENDS

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A1
OF A9

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[illegible]

34'-0" BUILDING HEIGHT

GRADE

18'-0"

8'-0"

GRADE

AVERAGE GRADE: 17.5

GRADE: 15.15

FRONT ELEVATION

SCALE: 1/4"=1'-0"

34'-0" BUILDING HEIGHT

GRADE

18'-0"

18'-0"

13'-6"

3'-6"

GRADE

AVERAGE GRADE: 17.5

GRADE: 15.75

RIGHT SIDE ELEVATION

SCALE: 1/4" = 1'-0"

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EXTERIOR ELEVATIONS

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42
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TITLE
EXTERIOR ELEVATIONS

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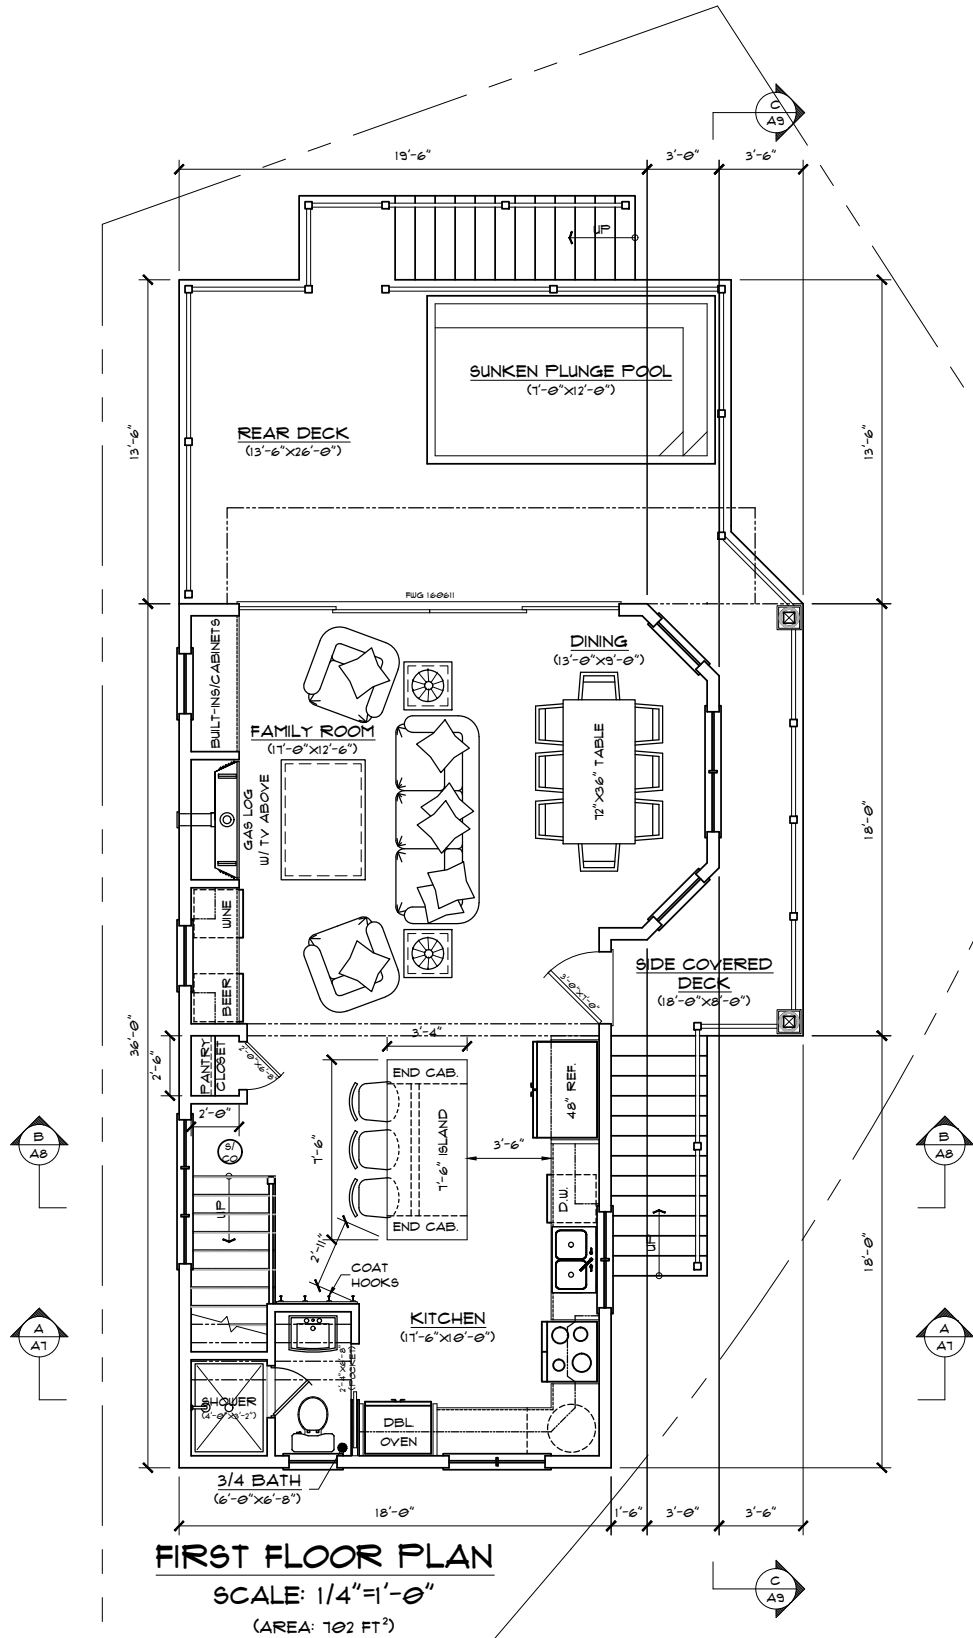
A2.1
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FIRST FLOOR PLAN
SCALE: 1/4"=1'-0"
(AREA: 102 FT²)

PROPOSED SQUARE FOOTAGE NOTE:	
FIRST FLOOR LIVING AREA	= 102 FT ²
SECOND FLOOR LIVING AREA	= 152 FT ²
ATTIC FLOOR LIVING AREA	= 529 FT ²
TOTAL LIVING AREA:	= 2,023 FT ²

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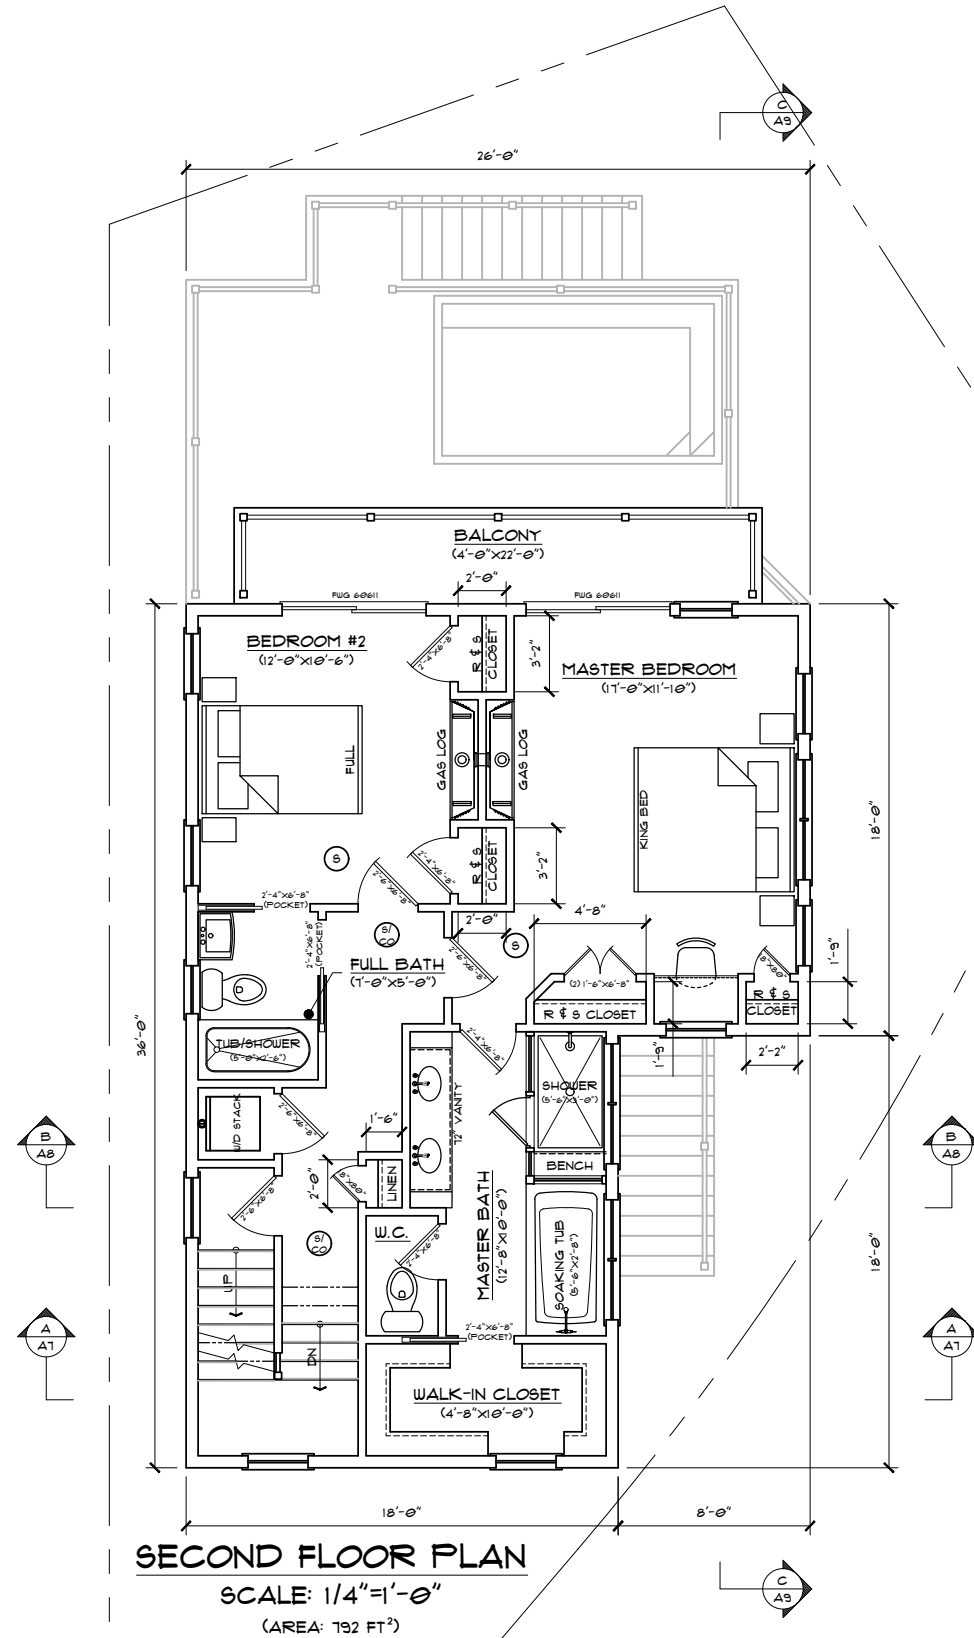
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PROPOSED SQUARE FOOTAGE NOTE

FIRST FLOOR LIVING AREA	= 102 FT ²
SECOND FLOOR LIVING AREA	= 192 FT ²
ATTIC FLOOR LIVING AREA	= 529 FT ²
TOTAL LIVING AREA:	= 2,023 FT²

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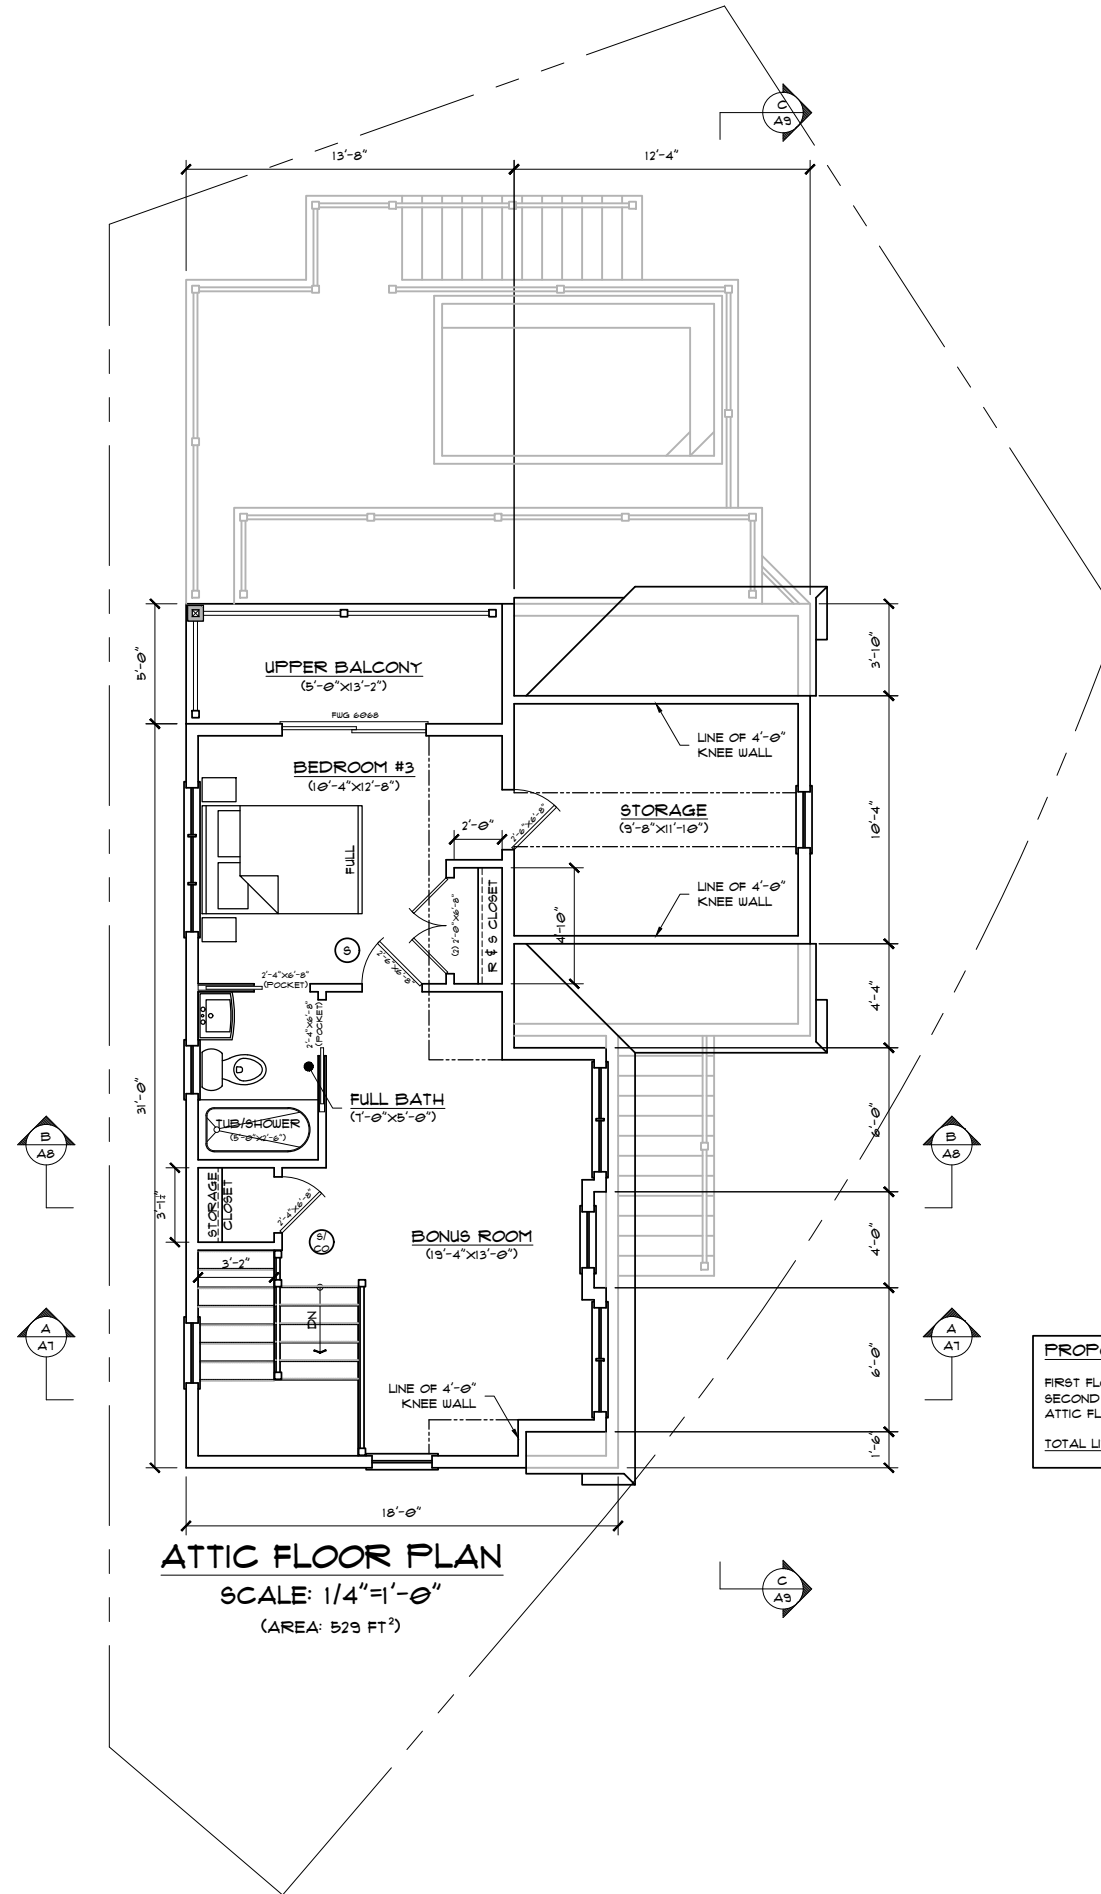
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
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PROPOSED SQUARE FOOTAGE NOTE:	
FIRST FLOOR LIVING AREA	= 102 FT ²
SECOND FLOOR LIVING AREA	= 132 FT ²
ATTIC FLOOR LIVING AREA	= 529 FT ²
TOTAL LIVING AREA:	= 2,023 FT²

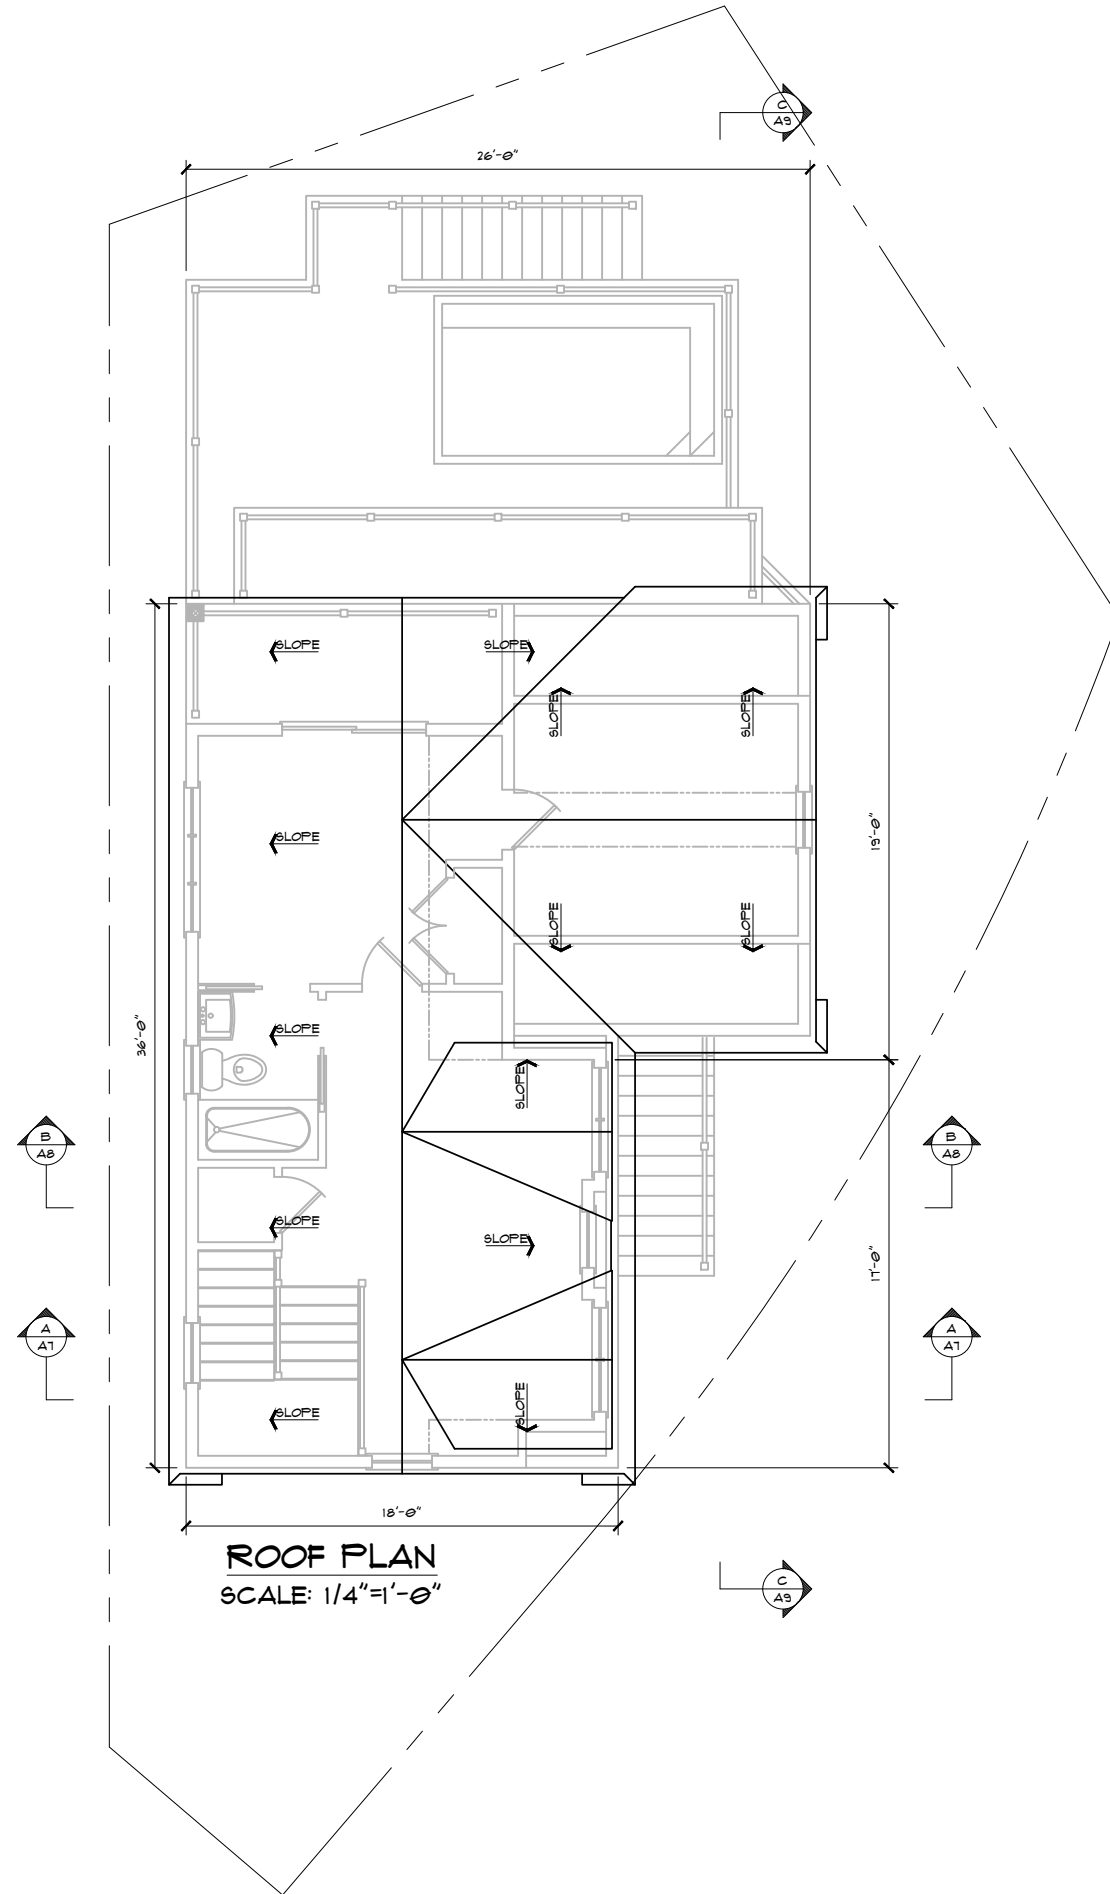
ATTIC FLOOR PLAN
SCALE: 1/4"=1'-0"
(AREA: 529 FT²)

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PROJECT: BRUCE & DIANE POMPEO-MALTEBY 126 WEISSAGUSSETT ROAD WEYMOUTH, MA 02191		
DATE 3/23/2020	REVISION	DESCRIPTION
DRAWN BY: PB		
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A5 of A9		

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TO ACQUIRE STRUCTURAL REDESIGN FOR
BUILDING DEPARTMENT SIGN-OFFS WILL BE
BILLED TO CLIENT ON AN HOURLY BASIS.

SEE SHEET AI FOR DRAWING INDEX

IF PRINTED ON 11X17, ALL SCALE IS HALF.

CONTRACTOR TO VERIFY ALL DIMENSIONS
AND SETBACKS PRIOR TO CONSTRUCTION

[illegible]

TITLE: ROOF PLAN

PROJECT: BRUCE & DIANE POMPEO-MALTBY
126 WESSAGUSSETT ROAD
WEYMOUTH, MA 02191

**Rockwood
Design, Inc.**
1020 Plain Street - Suite 320
Marshallfield, MA 02050
Phone: (781)-837-3140
Fax: (781)-837-3126
Email: phil@rockwooddesign.com
Website: www.rockwooddesign.com



DATE: 12/23/2020

RAWN BY:

HECKED BY:

SCALE:
8 NOTED

A6
OF 49

PROGRESS SET - 3/23/2020

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PROGRESS PRINT-NOT FOR CONSTRUCTION

PROGRESS SET - 3/23/2020

[illegible]

PROGRESS PRINT-NOT FOR CONSTRUCTION

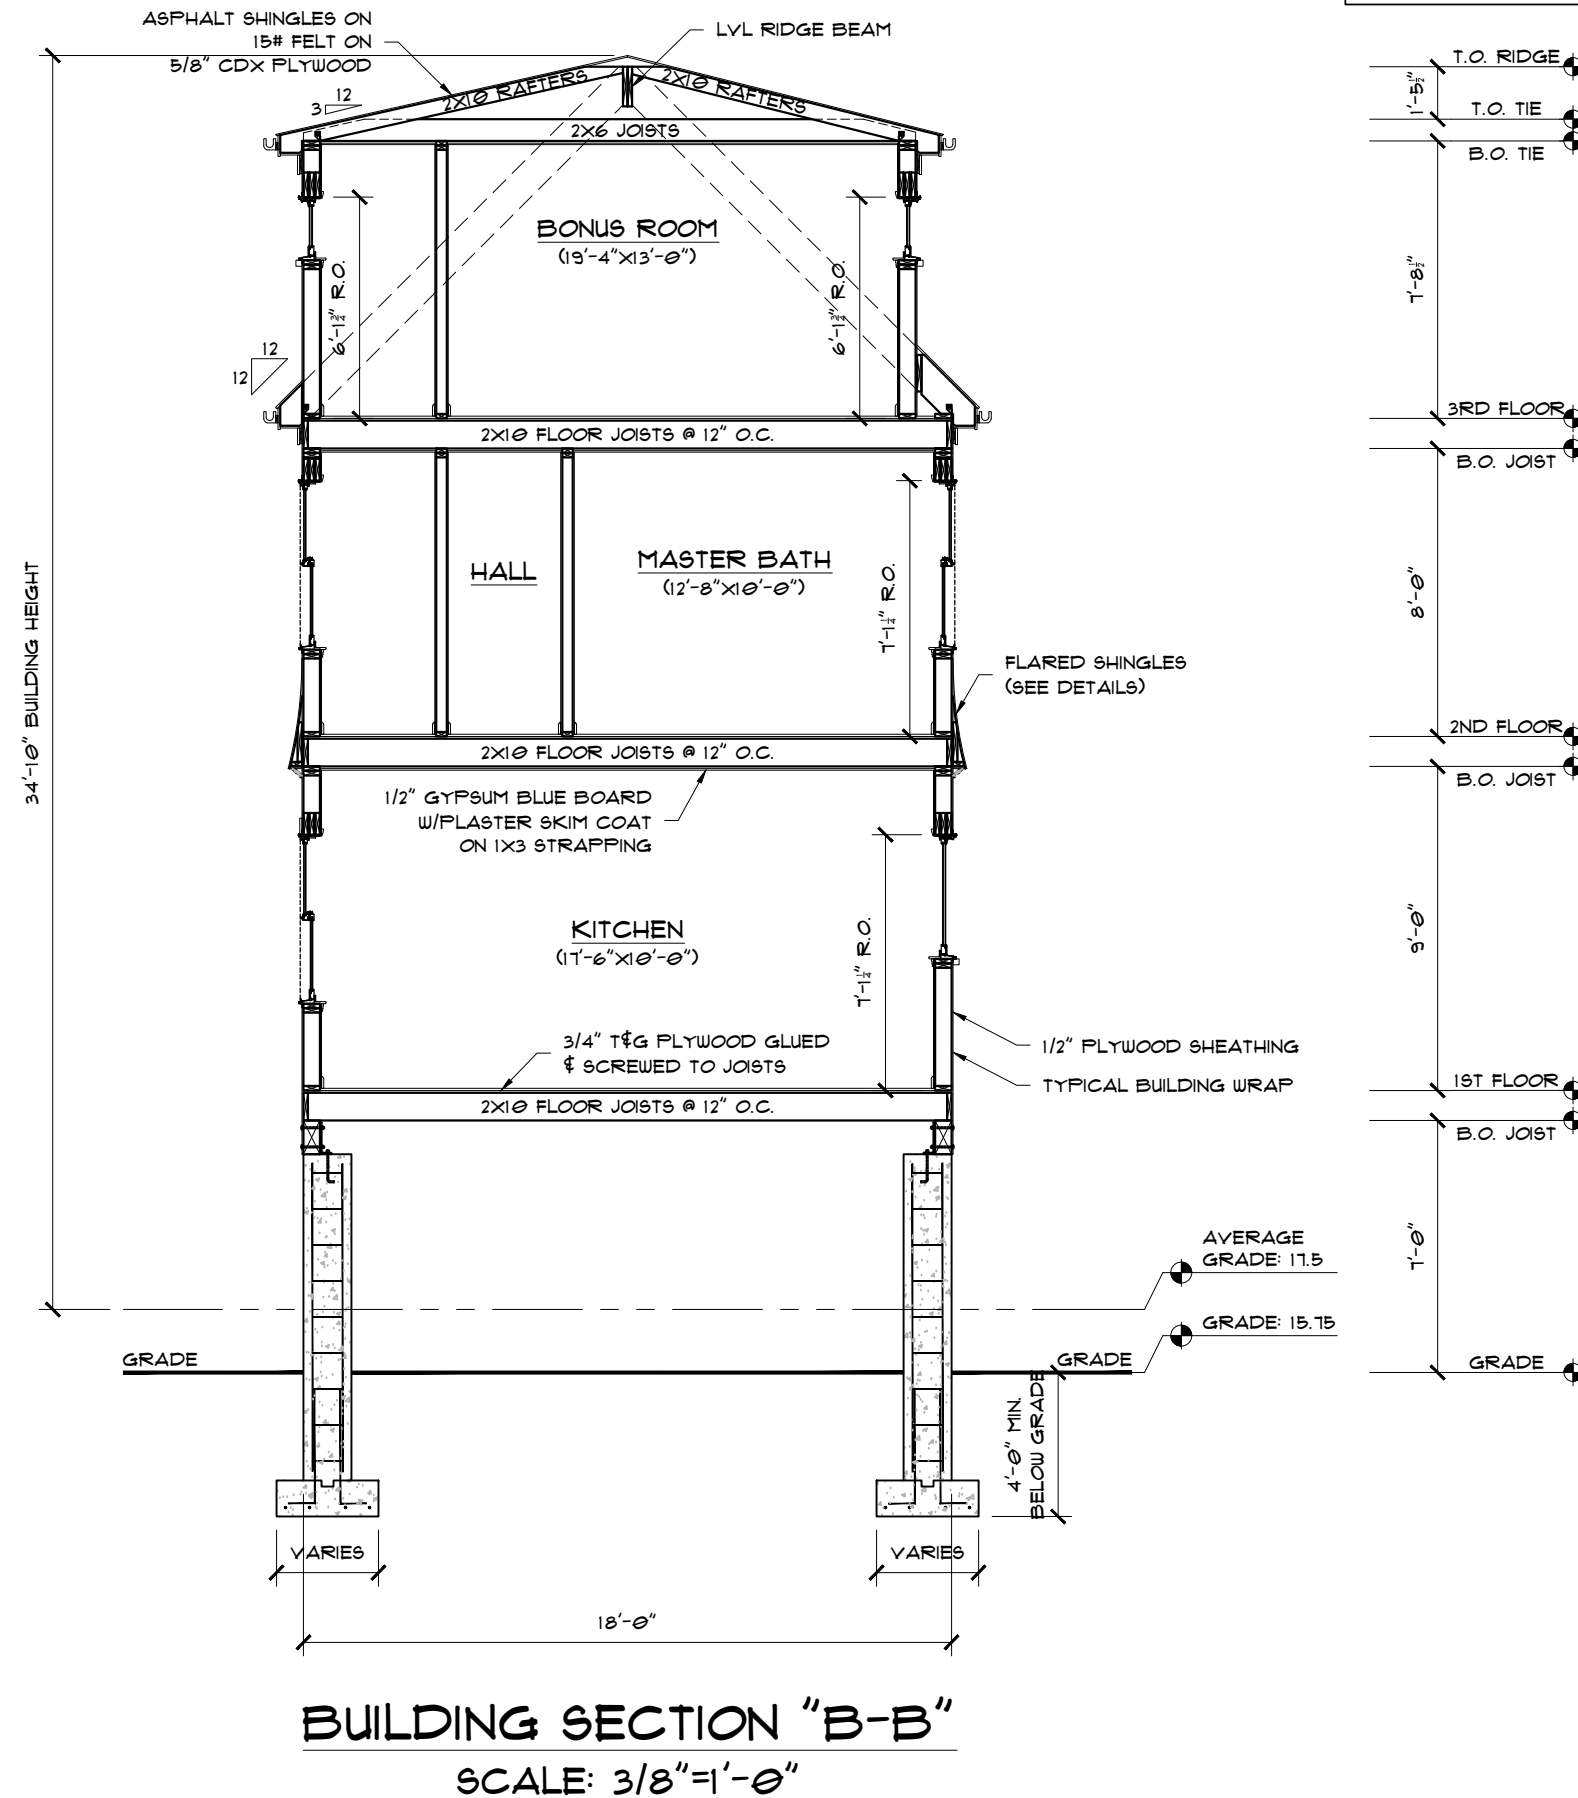
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PROGRESS SET - 3/23/2020

PROJECT:		TITLE	REVISION	DATE	DESCRIPTION
Rockwood Design, Inc. 1020 Main Street, Suite 320 Weymouth, MA 02090 Phone: (781)-837-3140 Fax: (781)-837-3126 Email: info@rockwooddesign.com Website: www.rockwooddesign.com		BRUCE & DIANE POMPEO-MALTBY 126 WESSAGUSSETT ROAD WEYMOUTH, MA 02191			
DATE 3/23/2010 DRAWN BY FB					
CHECKED BY:					
SCALE AS NOTED					

PROGRESS PRINT-NOT FOR CONSTRUCTION

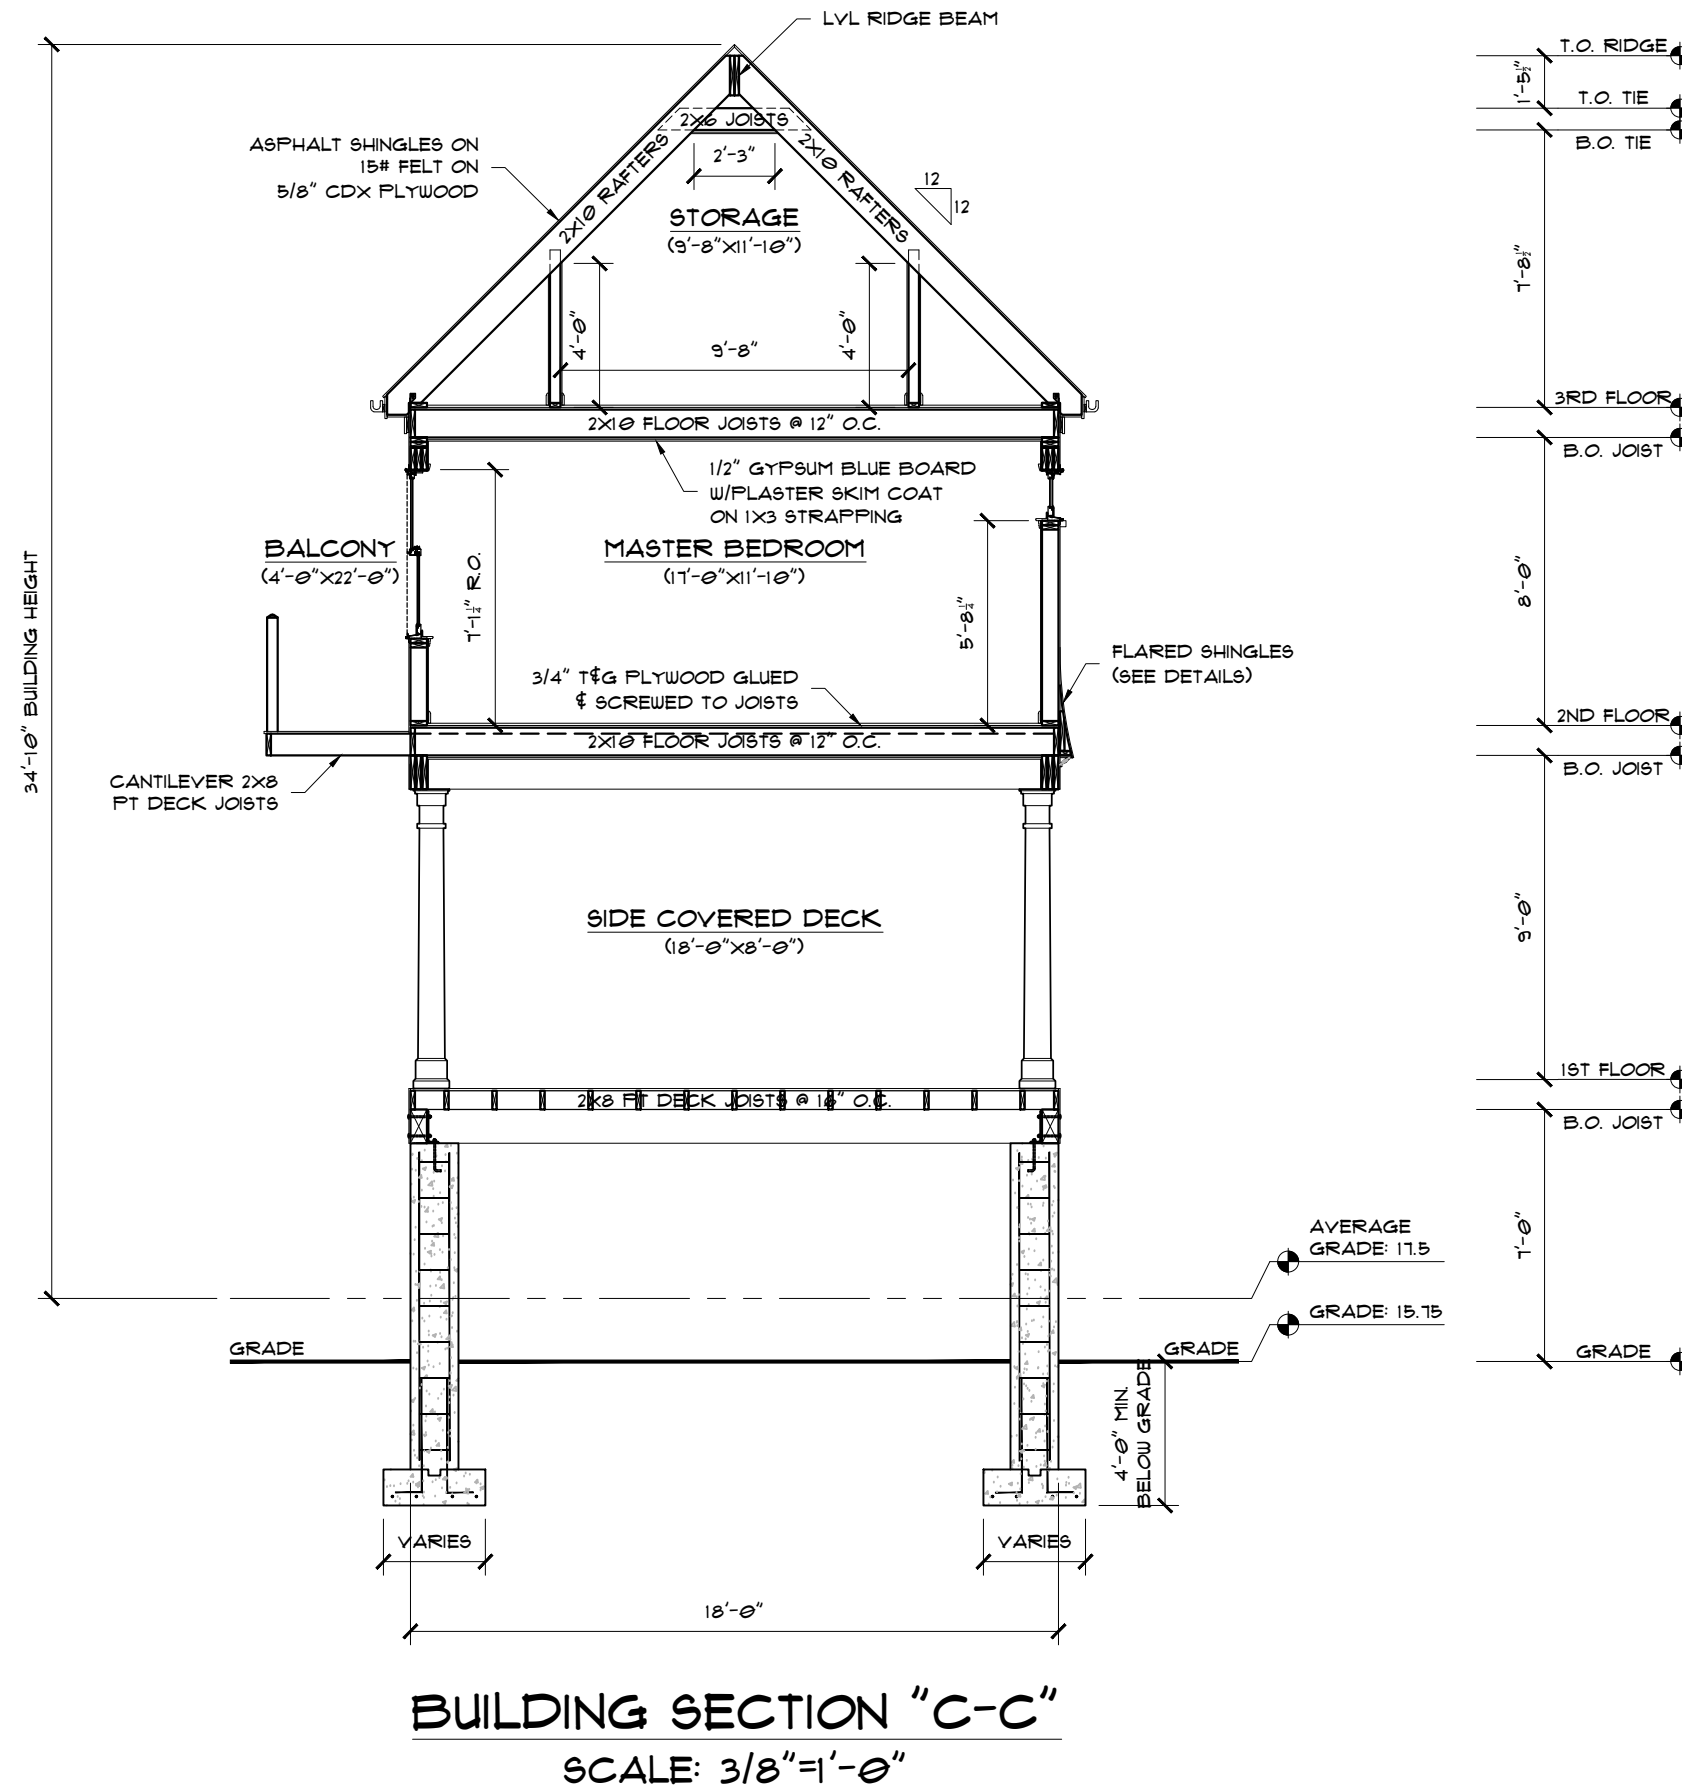
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PROGRESS SET - 3/23/2020

[illegible]

PROGRESS PRINT-NOT FOR CONSTRUCTION

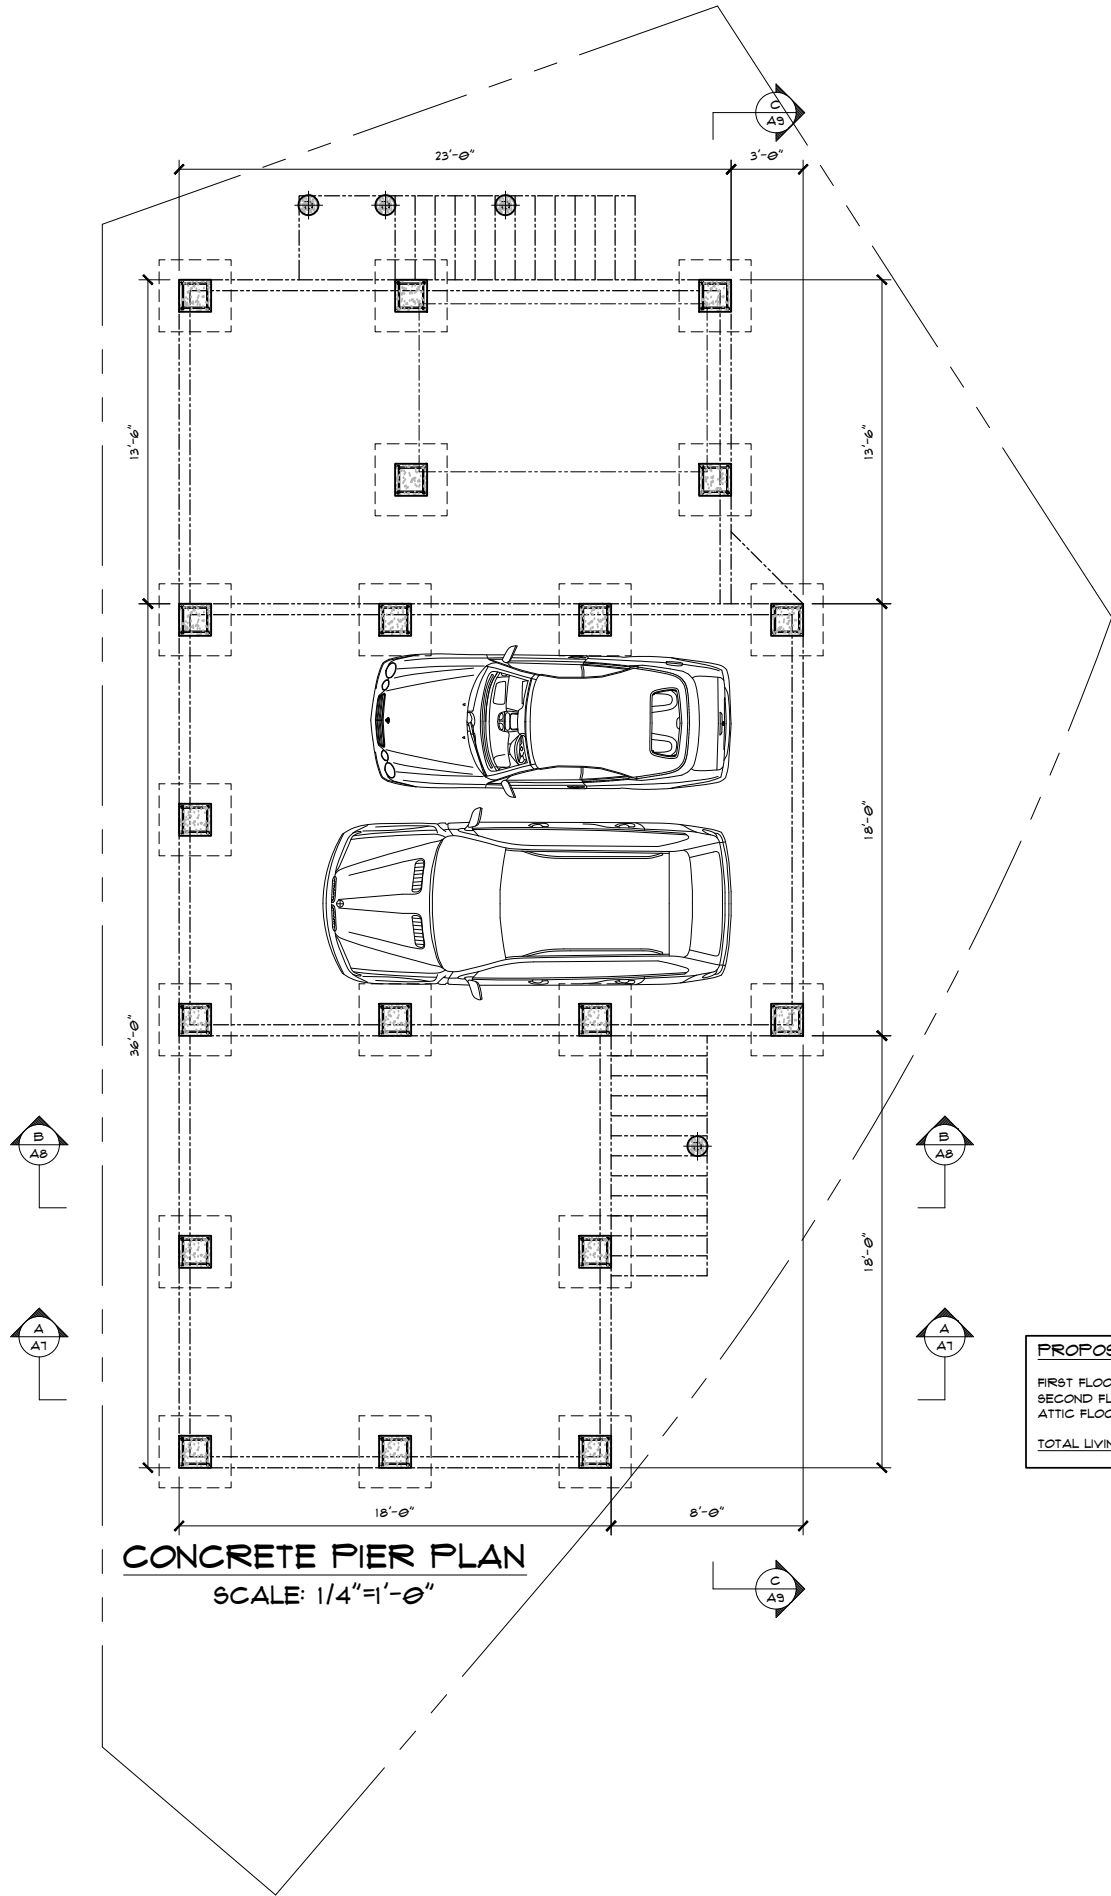
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
CONTRACTOR TO VERIFY ALL DIMENSIONS
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CONCRETE PIER PLAN
SCALE: 1/4"=1'-0"

PROPOSED SQUARE FOOTAGE NOTE:	
FIRST FLOOR LIVING AREA	= 102 FT ²
SECOND FLOOR LIVING AREA	= 152 FT ²
ATTIC FLOOR LIVING AREA	= 529 FT ²
TOTAL LIVING AREA:	= 2,023 FT ²

PROGRESS SET - 3/23/2020

REVISION	DATE	DESCRIPTION
TITLE FOUNDATION PLAN		
PROJECT: BRUCE & DIANE POMPEO-MALTBY 126 WESSAGUSSETT ROAD WEYMOUTH, MA 02191		
<div><div>Rockwood Design, Inc. 1020 Plain Street - Suite 320 Marlfield, MA 02050 Phone: (781)-837-3140 Fax: (781)-837-3126 Email: info@rockwooddesign.com Website: www.rockwooddesign.com</div></div>		
DATE 3/23/2020		
DRAWN BY: PB		
CHECKED BY:		
SCALE: AS NOTED		
S1		
OF 56		