Site Plans

Smelt Brook Daylighting Weymouth Landing, Weymouth, Massachusetts

Issued For: Notice of Intent Date Issued: May 18, 2017 Latest Issue: July 26, 2017

SHEET INDEX

		ig Drawings	
	SHEET NO.	SHEET TITLE	LATEST ISSUE
_	C-1	Title Sheet	7/26/2017
	C-2	Legend & General Notes	7/26/2017
	C-3	Overall Site Plan	7/26/2017
	C-4	Demolition and Erosion Control Plan	7/26/2017
	C 5	Layout & Materials Plan	7/26/2017

C-3	Overall Site Plan	7/26/2017
C-4	Demolition and Erosion Control Plan	7/26/2017
C-5	Layout & Materials Plan	7/26/2017
C-6	Grading & Drainage Plan	7/26/2017
C-7	Utilities Plan	7/26/2017
C-8	Plan & Profile	7/26/2017
C-9	Site Details 1	7/26/2017

7/26/2017

Landscape Architecture Drawings

C-10


Site Details 2


ERI Conculting Drawings

SHEET NO.	SHEET TITLE	LATEST ISSUE
L-1	Landscape Plan	6/26/2017
L-2	Landscape Details	6/26/2017

Reference Drawings - Survey

SHEET NO.	SHEET TITLE	LATEST ISSUE
1	Existing Conditions Plan	6/29/2016
2	Existing Conditions Plan	6/29/2016

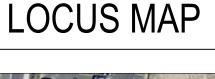

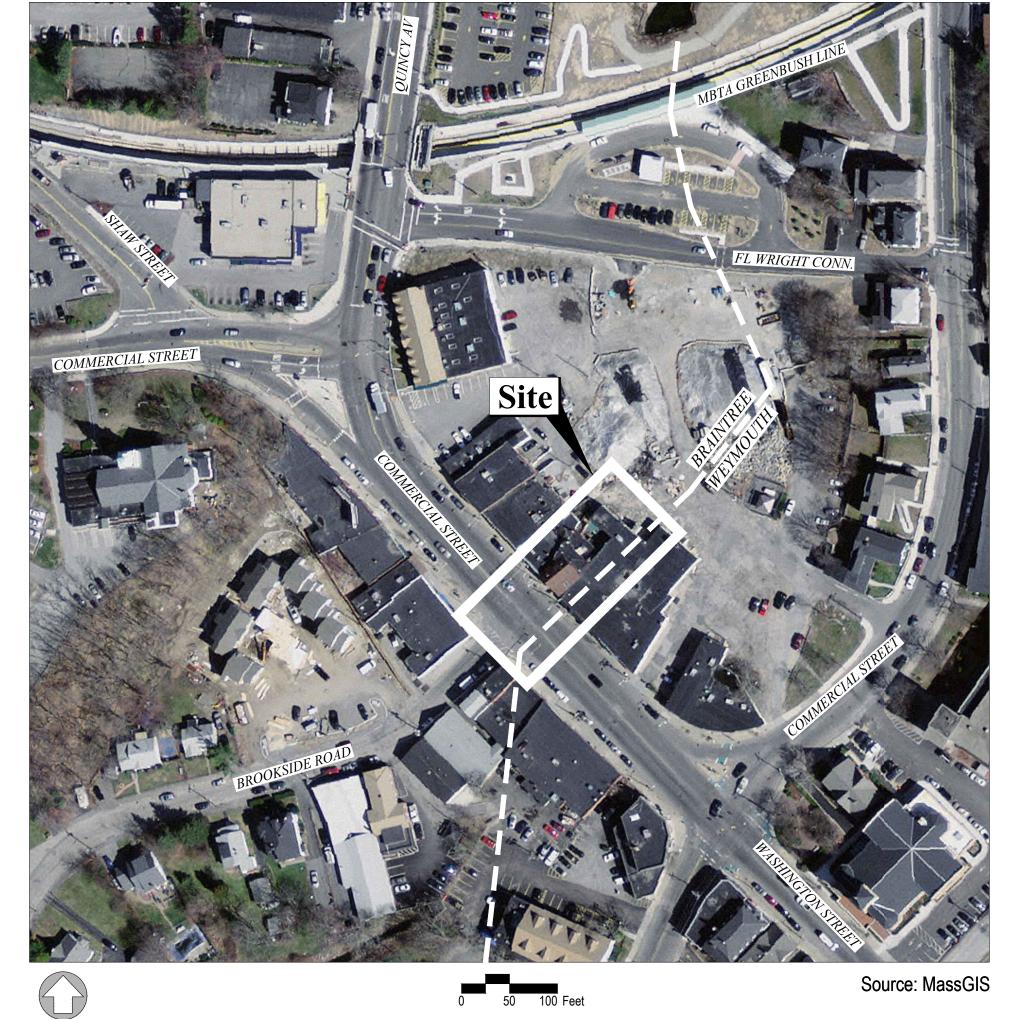

PROPERTY INFORMATION

OWNERS

Angeliki Papadopoulos 107 Buchanan Road Boston, MA 02132 Parcels 3006-0-7 & 8 (Braintree)

APPLICANT

Nicholas & George Delegas TRS 96 Ridge Street

Winchester, MA 01890 Parcel 3006-0-20 (Braintree) Parcels 20-202-19 & 20 (Weymouth)

625 Mt Auburn Street Cambridge, MA 02138
Parcel 3006-0-12 (Braintree)

Landing Apartments LLC

Town of Weymouth 75 Middle Street

Weymouth, MA Tel: (781) 335-2000 Fax: (781) 335-3283

PROJECT TEAM

CIVIL/STRUCTURAL ENGINEER



21 B Street | Burlington, MA 01803 Tel: 781.273.2500 | Fax: 781.273.3311 www.ebiconsulting.com

LANDSCAPE ARCHITECT

RBLA Design LLC Dedham, MA Tel: 781-686-4486 www.rbladesign.com

SURVEYOR


Kelly Engineering Group, Inc. 0 Campanelli Drive Braintree, MA 02184 Tel: (781) 843-4333 Fax: (781) 843-0028

ENVIRONMENTAL CONSULTANT

Lucas Environmental, LLC 67 Coddington Street, Suite 204 Quincy, MA 02169 Tel: (617) 405-4140 www.lucasenvironmental.net



Tel: 617.481.5985 www.ebiconsulting.com

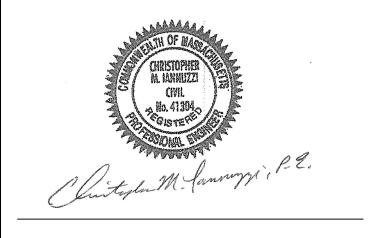

PREPARED FOR:

Town of Weymouth

75 Middle Street Weymouth, MA 021789 Tel: (781) 335-2000 Fax: (781) 335-3283

DRAWING SCALES NOTED ARE FOR 22" x 34" SIZE PRINTED MEDIA ONLY. ALL OTHER PRINTED SIZES ARE DEEMED "NOT TO SCALE"

SUBMITTALS			
NO.	DATE	DESCRIPTION	BY
1	7/26/2017	AGENCY COMMENTS	JLS

May 18, 2017 PROJECT TITLE: PROJECT NUMBER: 1616000008

Smelt Brook Daylighting

Weymouth Landing Weymouth, Massachusetts 02188 Norfolk County

ISSUED FOR: Notice of Intent (NOT FOR CONSTRUCTION)

SHEET TITLE:

Title Sheet

SCALE: N.T.S. DESIGNED BY: CHECKED BY:

CMI

C-'

SHEET NO:

1 OF 10

Dig Safe Systems, Inc. 1-888-DIG-SAFE I-888-344-7233)

LEGEND

Erosion Control

Grading

— × × × EROSION CONTROL BARRIER

STABILIZED

MAJOR CONTOUR

MINOR CONTOUR

SPOT ELEVATION

SINGLE CATCH BASIN

DOUBLE CATCH BASIN

FLARED END SECTION

DRAIN MANHOLE

CLEANOUT

HEADWALL

FORCE MAIN

SEWER MANHOLE

CURB STOP AND BOX

POST INDICATOR VALVE

SIAMESE CONNECTION

WATER VALVE AND BOX

UNDERGROUND ELECTRIC

ELECTRIC MANHOLE

TRANSFORMER PAD

UNDERGROUND TELEPHONE

TELEPHONE MANHOLE

HAND HOLE

PULL BOX

ELECTRIC METER

WATER METER

GAS GATE

GAS METER

TAPPING SLEEVE AND VALVE

SHUT-OFF VALVE

FIRE HYDRANT

REDUCER

PLUG OR CAP

RIPRAP OUTFALL

CONSTRUCTION EXIT

SILT SACK SEDIMENT TRAP

STRAW BALES

———— DETENTION BASIN

— — BIORETENTION AREA

-----6"W------ WATER

—8"W—▶—6"W—

—

———UGE—

-----UGT-----

CATV CABLE TV

_____ CONDUIT

FO—FO—FIBER OPTICS

_____2"DW______ DOMESTIC WATER

-----6"FP------- FIRE PROTECTION

 $(\widehat{\bullet})$

—— – —— — 100-YEAR FLOOD ELEVATION

------ 10-YEAR FLOOD ELEVATION

——— - **→** SWALE

<u>General</u>	
	PROPERTY LINE
	RIGHT-OF-WAY
	INTERNAL LOT LINE
	- ABUTTING PROPERTY LINE
	— EASEMENT
BLSF	BORDERING LAND SUBJECT TO FLOODING
200'RA	— 200' RIVERFRONT AREA
100'RA	— 100' RIVERFRONT AREA
100'BZ	— 100' WETLAND BUFFER ZONE
NDZ	— NO DISTURB ZONE
	 LIMIT OF DISTURBANCE
BL 10 EL=98.5	BORING LOCATION
₩W 2 EL=100.5	MONITORING WELL
TP 5 EL=112.7	TEST PIT LOCATION
	■ MATCHLINE

Layout and Materials	
100'-6"	BUILDING
EN	BUILDING ENTRANCE
	LOADING DOCK
LD	PARKING GARAGE
PG 	BUILDING SETBACK
	BASELINE LIMIT OF WORK SAWGUT LINE
	GRAVEL ROAD
EOP	EDGE OF PAVEMENT
VGC	VERTICAL GRANITE CURB
VGC PCC	LIMIT OF CURB TYPE
VGC	CONCRETE SIDEWALK
VGC	PAVER SIDEWALK
	LANDSCAPE BUFFER
	PARKING SETBACK
50	TOTAL PARKING COUNT
20)	STANDARD STALL COUNT
(C10)	COMPACT STALL COUNT
<u>گ</u>	ACCESSIBLE PARKING
VAN	VAN ACCESSIBLE PARKING
	ACCESSIBLE CURB RAMP
	CROSSWALK
	PARKING BUMPER
.	DIRECTIONAL SIGN

BOLLARD

UTILITY POLE

GUY POLE

OVERHEAD WIRE

RETAINING WALL

■ STOCKADE FENCE

STEEL GUARDRAIL
WOOD GUARDRAIL

TREE LINE

→ CONSTRUCTION FENCE

· STONE WALL

PEDESTRIAN LIGHT POLE

PARKING LOT LIGHT POLE

ABBREVIATIONS

	ADDREV	IAHO	INO
General		Utilities	
ACR	ACCESSIBLE CURB RAMP	ABAN	ABANDON
ADA	AMERICANS WITH DISABILITIES ACT	ADJ	ADJUST
APPROX	APPROXIMATE	CATV	CABLE TV
ARCH	ARCHITECTURAL	CIP	CAST IRON PIPE
ВС	BOTTOM OF CURB	CMP	CORRUGATED METAL PIPE
BCB	BITUMINOUS CONCRETE BERM	CO	CLEANOUT
BCC	BITUMINOUS CONCRETE CURB	COND	CONDUIT
BIT	BITUMINOUS	CS	CURB STOP AND BOX
BLDG	BUILDING	DIA	DIAMETER
BLSF	BORDERING LAND SUBJECT TO	DCB	DOUBLE CATCH BASIN
	FLOODING	DET	DETENTION
ВОТ	BOTTOM	DIP	DUCTILE IRON PIPE
BS	BOTTOM OF SLOPE	DMH	DRAIN MANHOLE
BW	BOTTOM OF WALL	DW	DOMESTIC WATER
BWLL	BROKEN WHITE LANE LINE	EMH	ELECTRIC MANHOLE
CCB	CAPE COD BERM	FA	FIRE ALARM
CLF	CHAIN LINK FENCE	FES	FLARED END SECTION
CONC	CONCRETE	FP	FIRE PROTECTION
DPW	DEPARTMENT OF PUBLIC WORKS	FM	FORCE MAIN
DYCL	DOUBLE YELLOW CENTER LINE	FO	FIBER OPTICS
ECC	EXTRUDED CONCRETE CURB	F&C	FRAME AND COVER
ELEV	ELEVATION	F&G	FRAME AND GRATE
EOP	EDGE OF PAVEMENT	GG	GAS GATE
EX	EXISTING	Gl	GUTTER INLET
EXIST	EXISTING	GM	GAS METER
FDN	FOUNDATION	GT	GREASE TRAP
FFE	FIRST FLOOR ELEVATION	HDPE	HIGH DENSITY POLYETHYLENE PIPE
GRAN	GRANITE	НН	HAND HOLE
GTD	GRADE TO DRAIN	HW	HEADWALL
HP	HIGH POINT	HYD	HYDRANT
LA	LANDSCAPE AREA	INF	INFILTRATION
LOD	LIMIT OF DISTURBANCE	INV	INVERT ELEVATION
LOW	LIMIT OF WORK	 =	INVERT ELEVATION
LP	LOW POINT	MES	METAL END SECTION
MAX	MAXIMUM	MW	MONITORING WELL
MCC	MONOLITHIC CONCRETE CURB	OHW	OVERHEAD WIRE
ME	MATCH EXISTING	РВ	PULL BOX
MIN	MINIMUM	PIV	POST INDICATOR VALVE
NDZ	NO DISTURB ZONE	PVC	POLYVINYLCHLORIDE PIPE
NIC	NOT IN CONTRACT	RCP	REINFORCED CONCRETE PIPE
NTS	NOT TO SCALE	RD	ROOF DRAIN
PCC	PRECAST CONCRETE CURB	R=	RIM ELEVATION
PL	PROPERTY LINE	SAS	SOIL ABSORPTION SYSTEM
PROP	PROPOSED	SCB	SINGLE CATCH BASIN
R	RADIUS	SLP	SITE LIGHT POLE
RA	RIVERFRONT AREA	SMH	SEWER MANHOLE
REM	REMOVE	SYS	SYSTEM
RET	RETAIN	TMH	TELEPHONE MANHOLE
ROW	RIGHT-OF-WAY	TSV	TAPPING SLEEVE, VALVE, AND BOX
R&D	REMOVE AND DISPOSE	UD	UNDERDRAIN
R&R	REMOVE AND RESET	UG	UNDERGROUND
SGE	SLOPED GRANITE EDGING	UP	UTILITY POLE
SWEL	SOLID WHITE EDGE LINE	WM	WATER METER
SWLL	SOLID WHITE LANE LINE	WQI	WATER QUALITY INLET
TC	TOP OF CURB	WQS	WATER QUALITY STRUCTURE
TR	TRASH BAY	WV	WATER VALVE AND BOX

TOP OF SLOPE

TOP OF WALL

VERTICAL GRANITE CURB

TYPICAL

GENERAL NOTES

General Information:

- 1. CONTRACTOR SHALL NOTIFY "DIG-SAFE" (1-888-344-7233) AT LEAST 72 HOURS BEFORE EXCAVATING.
- 2. CONTRACTOR SHALL BE RESPONSIBLE FOR SITE SECURITY AND JOB SAFETY, CONSTRUCTION ACTIVITIES SHALL BE IN ACCORDANCE WITH OSHA STANDARDS AND LOCAL REQUIREMENTS.
- 3. ACCESSIBLE ROUTES, PARKING SPACES, RAMPS, SIDEWALKS, AND WALKWAYS SHALL BE CONSTRUCTED IN CONFORMANCE WITH THE FEDERAL AMERICANS WITH DISABILITIES ACT AND WITH STATE AND LOCAL LAWS AND REGULATIONS (WHICHEVER ARE MORE STRINGENT).
- 4. AREAS DISTURBED DURING CONSTRUCTION AND NOT RESTORED WITH IMPERVIOUS SURFACES (BUILDINGS, PAVEMENTS, WALKS, ETC.) SHALL RECEIVE 6 INCHES LOAM AND SEED.
- 5. WITHIN THE LIMITS OF THE BUILDING FOOTPRINT, THE SITE CONTRACTOR SHALL PERFORM EARTHWORK OPERATIONS REQUIRED TO SUBGRADE ELEVATIONS.
- 6. WORK WITHIN THE LOCAL RIGHTS-OF-WAY SHALL CONFORM TO LOCAL MUNICIPAL STANDARDS. WORK WITHIN STATE RIGHTS-OF-WAY SHALL CONFORM TO THE LATEST EDITION OF THE STATE HIGHWAY DEPARTMENTS STANDARD SPECIFICATIONS FOR HIGHWAYS AND BRIDGES.
- 7. UPON AWARD OF CONTRACT, CONTRACTOR SHALL MAKE NECESSARY CONSTRUCTION NOTIFICATIONS AND APPLY FOR AND OBTAIN NECESSARY PERMITS, PAY FEES, AND POST BONDS ASSOCIATED WITH THE WORK INDICATED ON THE DRAWINGS, IN THE SPECIFICATIONS, AND IN THE CONTRACT DOCUMENTS. DO NOT CLOSE OR OBSTRUCT ROADWAYS, SIDEWALKS, AND FIRE HYDRANTS, WITHOUT APPROPRIATE PERMITS.
- 8. TRAFFIC SIGNAGE AND PAVEMENT MARKINGS SHALL CONFORM TO THE MANUAL OF UNIFORM TRAFFIC CONTROL DEVICES (M.U.T.C.D.).
- 9. AREAS OUTSIDE THE LIMITS OF PROPOSED WORK DISTURBED BY THE CONTRACTOR'S OPERATIONS SHALL BE RESTORED BY THE CONTRACTOR TO THEIR ORIGINAL CONDITION AT THE CONTRACTOR'S EXPENSE.
- 10. IN THE EVENT THAT SUSPECTED CONTAMINATED SOIL, GROUNDWATER, AND OTHER MEDIA ARE ENCOUNTERED DURING EXCAVATION AND CONSTRUCTION ACTIVITIES BASED ON VISUAL, OLFACTORY, OR OTHER EVIDENCE, THE CONTRACTOR SHALL STOP WORK IN THE VICINITY OF THE SUSPECT MATERIAL TO AVOID FURTHER SPREADING OF THE MATERIAL, AND SHALL NOTIFY THE OWNER IMMEDIATELY SO THAT THE APPROPRIATE TESTING AND SUBSEQUENT ACTION CAN BE TAKEN.
- 11. CONTRACTOR SHALL PREVENT DUST, SEDIMENT, AND DEBRIS FROM EXITING THE SITE AND SHALL BE RESPONSIBLE FOR CLEANUP, REPAIRS, AND CORRECTIVE ACTION IF SUCH OCCURS.
- 12. DAMAGE RESULTING FROM CONSTRUCTION LOADS SHALL BE REPAIRED BY THE CONTRACTOR AT NO ADDITIONAL COST TO THE OWNER.
- 13. CONTRACTOR SHALL CONTROL STORMWATER RUNOFF DURING CONSTRUCTION TO PREVENT ADVERSE IMPACTS TO OFF SITE AREAS, AND SHALL BE RESPONSIBLE TO REPAIR RESULTING DAMAGES, IF ANY, AT NO COST TO OWNER.

Existing Conditions:

- 1. THE EXISTING CONDITIONS SHOWN ARE BASED ON THE EXISTING CONDITIONS PLAN PREPARED BY KELLY ENGINEERING GROUP, INC. DATED JUNE 29, 2016.
- 2. THE LOCATION OF ALL UNDERGROUND UTILITIES SHOWN HEREON ARE APPROXIMATE AND ARE BASED ON THE FIELD LOCATION OF ALL VISIBLE STRUCTURES SUCH AS CATCH BASINS, MANHOLES, WATER GATES, ETC. AND COMPILED FROM PLANS SUPPLIED BY VARIOUS UTILITY COMPANIES AND GOVERNMENT AGENCIES.
- 3. ELEVATIONS ARE BASED ON THE NORTH AMERICAN VERTICAL DATUM OF 1988 (NAVD 88). TOWN OF WEYMOUTH DATUM IS 6.63 FEET BELOW NAVD 88 DATUM.

Erosion Control:

- 1. PRIOR TO STARTING ANY OTHER WORK ON THE SITE, THE CONTRACTOR SHALL NOTIFY APPROPRIATE AGENCIES AND SHALL INSTALL EROSION CONTROL MEASURES AS SHOWN ON THE PLANS AND AS IDENTIFIED IN FEDERAL, STATE, AND LOCAL APPROVAL DOCUMENTS PERTAINING TO THIS PROJECT.
- 2. CONTRACTOR SHALL INSPECT AND MAINTAIN EROSION CONTROL MEASURES, AND REMOVE SEDIMENT THEREFROM ON A WEEKLY BASIS AND WITHIN TWELVE HOURS AFTER EACH STORM EVENT AND DISPOSE OF SEDIMENTS IN AN UPLAND AREA SUCH THAT THEY DO NOT ENCUMBER OTHER DRAINAGE STRUCTURES AND PROTECTED AREAS.
- 3. CONTRACTOR SHALL BE FULLY RESPONSIBLE TO CONTROL CONSTRUCTION SUCH THAT SEDIMENTATION SHALL NOT AFFECT REGULATORY PROTECTED AREAS, WHETHER SUCH SEDIMENTATION IS CAUSED BY WATER, WIND, OR DIRECT DEPOSIT.
- 4. CONTRACTOR SHALL PERFORM CONSTRUCTION SEQUENCING SUCH THAT EARTH MATERIALS ARE EXPOSED FOR A MINIMUM OF TIME BEFORE THEY ARE COVERED, SEEDED, OR OTHERWISE STABILIZED TO PREVENT EROSION.
- 5. UPON COMPLETION OF CONSTRUCTION AND ESTABLISHMENT OF PERMANENT GROUND COVER, CONTRACTOR SHALL REMOVE AND DISPOSE OF EROSION CONTROL MEASURES AND CLEAN SEDIMENT AND DEBRIS FROM ENTIRE DRAINAGE AND SEWER SYSTEMS.

Demolition:

- 1. CONTRACTOR SHALL REMOVE AND DISPOSE OF EXISTING MANMADE SURFACE FEATURES WITHIN THE LIMIT OF WORK INCLUDING BUILDINGS, STRUCTURES, PAVEMENTS, SLABS, CURBING, FENCES, UTILITY POLES, SIGNS ETC. UNLESS INDICATED OTHERWISE ON THE DRAWINGS, REMOVE AND DISPOSE OF EXISTING UTILITIES, FOUNDATIONS AND UNSUITABLE MATERIAL BENEATH AND FOR A DISTANCE OF 10 FEET BEYOND THE PROPOSED BUILDING FOOTPRINT INCLUDING EXTERIOR COLUMNS.
- EXISTING UTILITIES SHALL BE TERMINATED, UNLESS OTHERWISE NOTED, IN CONFORMANCE WITH LOCAL, STATE, AND INDIVIDUAL UTILITY COMPANY STANDARD SPECIFICATIONS AND DETAILS. THE CONTRACTOR SHALL COORDINATE UTILITY SERVICE DISCONNECTS WITH THE UTILITY REPRESENTATIVES.
- 3. CONTRACTOR SHALL DISPOSE OF DEMOLITION DEBRIS IN ACCORDANCE WITH APPLICABLE FEDERAL, STATE AND LOCAL REGULATIONS, ORDINANCES AND STATUTES.

Layout and Materials:

- 1. DIMENSIONS ARE FROM THE FACE OF CURB, FACE OF BUILDING, FACE OF WALL, AND CENTER LINE OF PAVEMENT MARKINGS, UNLESS OTHERWISE NOTED.
- 2. CURBING SHALL BE PRECAST CONCRETE CURB (PCC) AND CURB RADII SHALL BE THREE FEET (3') WITHIN THE SITE, UNLESS OTHERWISE INDICATED ON THE SITE PLANS.
- SEE ARCHITECTURAL DRAWINGS FOR EXACT BUILDING DIMENSIONS AND DETAILS CONTIGUOUS
 TO THE BUILDING, INCLUDING SIDEWALKS, RAMPS, BUILDING ENTRANCES, STAIRWAYS, UTILITY
- 4. PROPOSED BOUNDS AND ANY EXISTING PROPERTY LINE MONUMENTATION DISTURBED DURING CONSTRUCTION SHALL BE SET OR RESET BY A PROFESSIONAL LICENSED SURVEYOR.

PENETRATIONS, CONCRETE DOOR PADS, COMPACTOR PAD, LOADING DOCKS, BOLLARDS, ETC.


- 5. SYMBOLS AND LEGENDS OF PROJECT FEATURES ARE GRAPHIC REPRESENTATIONS AND ARE NOT NECESSARILY SCALED TO THEIR ACTUAL DIMENSIONS OR LOCATIONS ON THE DRAWINGS. THE CONTRACTOR SHALL REFER TO THE DETAIL SHEET DIMENSIONS, MANUFACTURER'S LITERATURE, SHOP DRAWINGS AND FIELD MEASUREMENTS OF SUPPLIED PRODUCTS FOR LAYOUT OF THE PROJECT FEATURES.
- 6. CONTRACTOR SHALL NOT RELY SOLELY ON ELECTRONIC VERSIONS OF PLANS, SPECIFICATIONS, AND DATA FILES THAT ARE OBTAINED FROM THE DESIGNERS, BUT SHALL VERIFY LOCATION OF PROJECT FEATURES IN ACCORDANCE WITH THE PAPER COPIES OF THE PLANS AND SPECIFICATIONS THAT ARE SUPPLIED AS PART OF THE CONTRACT DOCUMENTS.

Utilities:

- 1. THE LOCATIONS, SIZES, AND TYPES OF EXISTING UTILITIES ARE SHOWN AS AN APPROXIMATE REPRESENTATION ONLY. THE OWNER OR IT'S REPRESENTATIVES HAVE NOT INDEPENDENTLY VERIFIED THIS INFORMATION AS SHOWN ON THE PLANS. THE UTILITY INFORMATION SHOWN DOES NOT GUARANTEE THE ACTUAL EXISTENCE, SERVICEABILITY, OR OTHER DATA CONCERNING THE UTILITIES, NOR DOES IT GUARANTEE AGAINST THE POSSIBILITY THAT ADDITIONAL UTILITIES MAY BE PRESENT THAT ARE NOT SHOWN ON THE PLANS. PRIOR TO ORDERING MATERIALS AND BEGINNING CONSTRUCTION, THE CONTRACTOR SHALL VERIFY AND DETERMINE THE EXACT LOCATIONS, SIZES, AND ELEVATIONS OF THE POINTS OF ALL CONNECTIONS TO EXISTING UTILITIES AND, SHALL CONFIRM THAT THERE ARE NO INTERFERENCES WITH EXISTING UTILITIES AND THE PROPOSED UTILITY ROUTES, INCLUDING ROUTES WITHIN THE PUBLIC RIGHTS OF WAY.
- WHERE AN EXISTING UTILITY IS FOUND TO CONFLICT WITH THE PROPOSED WORK, OR EXISTING CONDITIONS DIFFER FORM THOSE SHOWN SUCH THAT THE WORK CANNOT BE COMPLETED AS INTENDED, THE LOCATION, ELEVATION, AND SIZE OF THE UTILITY SHALL BE ACCURATELY DETERMINED WITHOUT DELAY BY THE CONTRACTOR, AND THE INFORMATION FURNISHED IN WRITING TO THE OWNER'S REPRESENTATIVE FOR THE RESOLUTION OF THE CONFLICT AND CONTRACTOR'S FAILURE TO NOTIFY PRIOR TO PERFORMING ADDITIONAL WORK RELEASES OWNER FROM OBLIGATIONS FOR ADDITIONAL PAYMENTS WHICH OTHERWISE MAY BE WARRANTED TO RESOLVE THE CONFLICT.
- 3. CONTRACTOR SHALL MAKE ARRANGEMENTS FOR AND SHALL BE RESPONSIBLE FOR PAYING FEES FOR POLE RELOCATION AND FOR THE ALTERATION AND ADJUSTMENT OF GAS, ELECTRIC, TELEPHONE, FIRE ALARM, AND ANY OTHER PRIVATE UTILITIES, WHETHER WORK IS PERFORMED BY CONTRACTOR OR BY UTILITIES COMPANY.
- 4. UTILITY PIPE MATERIALS SHALL BE AS FOLLOWS, UNLESS OTHERWISE NOTED ON THE PLAN:
- A. STORM DRAINAGE PIPES SHALL BE HIGH DENSITY POLYETHYLENE (HDPE)
- B. SANITARY SEWER PIPES SHALL BE POLYVINYL CHLORIDE (PVC), SDR 35 SEWER PIPE
- C. WATER PIPES SHALL BE CEMENT LINED DUCTILE IRON, CLASS 52



1400 Hancock Street, 4th Floor Quincy, MA 02169 Tel: 617.481.5985 www.ebiconsulting.com

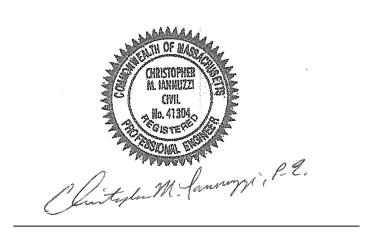

PREPARED FOR:

Town of Weymouth

75 Middle Street Weymouth, MA 021789 Tel: (781) 335-2000 Fax: (781) 335-3283

THIS DOCUMENT IS THE DESIGN PROPERTY AND COPYRIGHT OF EBI CONSULTING, INC. AND FOR THE EXCLUSIVE USE BY THE TITLE CLIENT. ANY DUPLICATION OR USE WITHOUT EXPRESS WRITTEN CONSENT OF THE CREATOR IS STRICTLY PROHIBITED.

DRAWING SCALES NOTED ARE FOR 22" x 34" SIZE PRINTED MEDIA ONLY. ALL OTHER PRINTED SIZES ARE DEEMED "NOT TO SCALE".

	SUBMITTALS				
NO.	DATE	DESCRIPTION	BY		
1	7/26/2017	AGENCY COMMENTS	JLS		

DATE: May 18, 2017 PROJECT NUMBER: 1616000008

Smelt Brook Daylighting

Weymouth Landing
Weymouth, Massachusetts 02188
Norfolk County

ISSUED FOR:
Notice of Intent
(NOT FOR CONSTRUCTION)

SHEET TITLE:

CMI

Legend & General Notes

SCALE:

N.T.S.


DESIGNED BY:


JLS


CHECKED BY:


C-2


2 OF 10

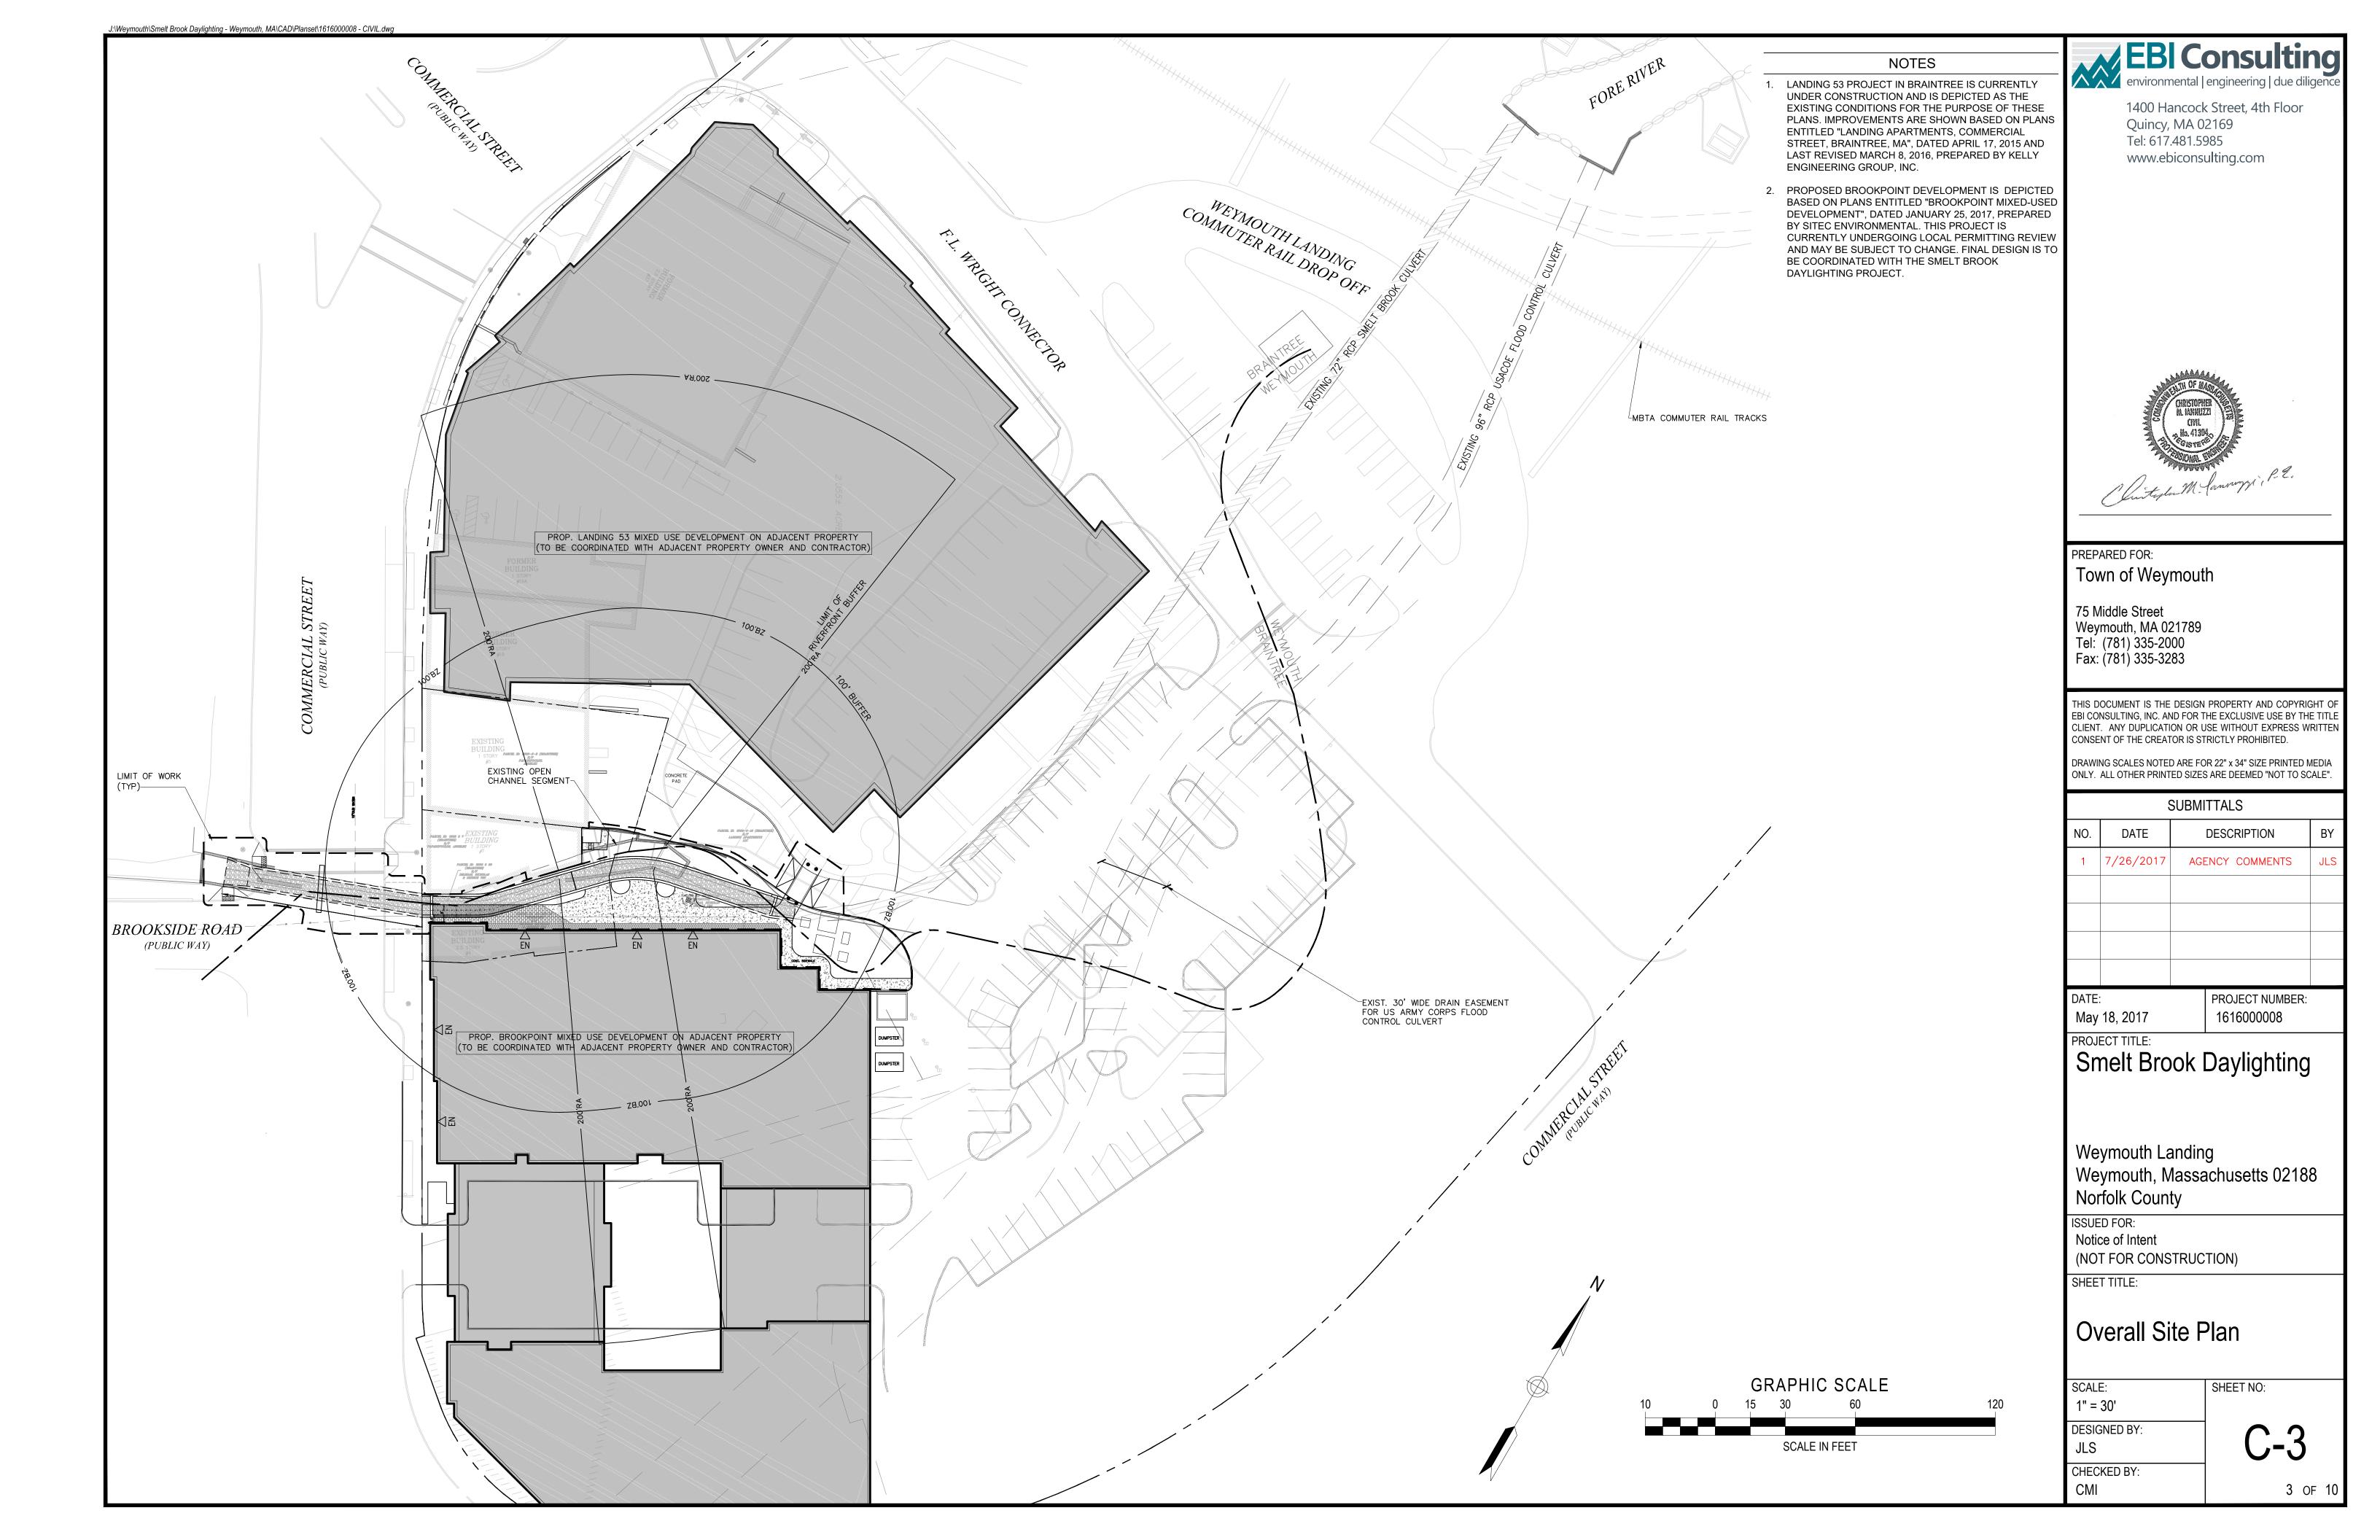


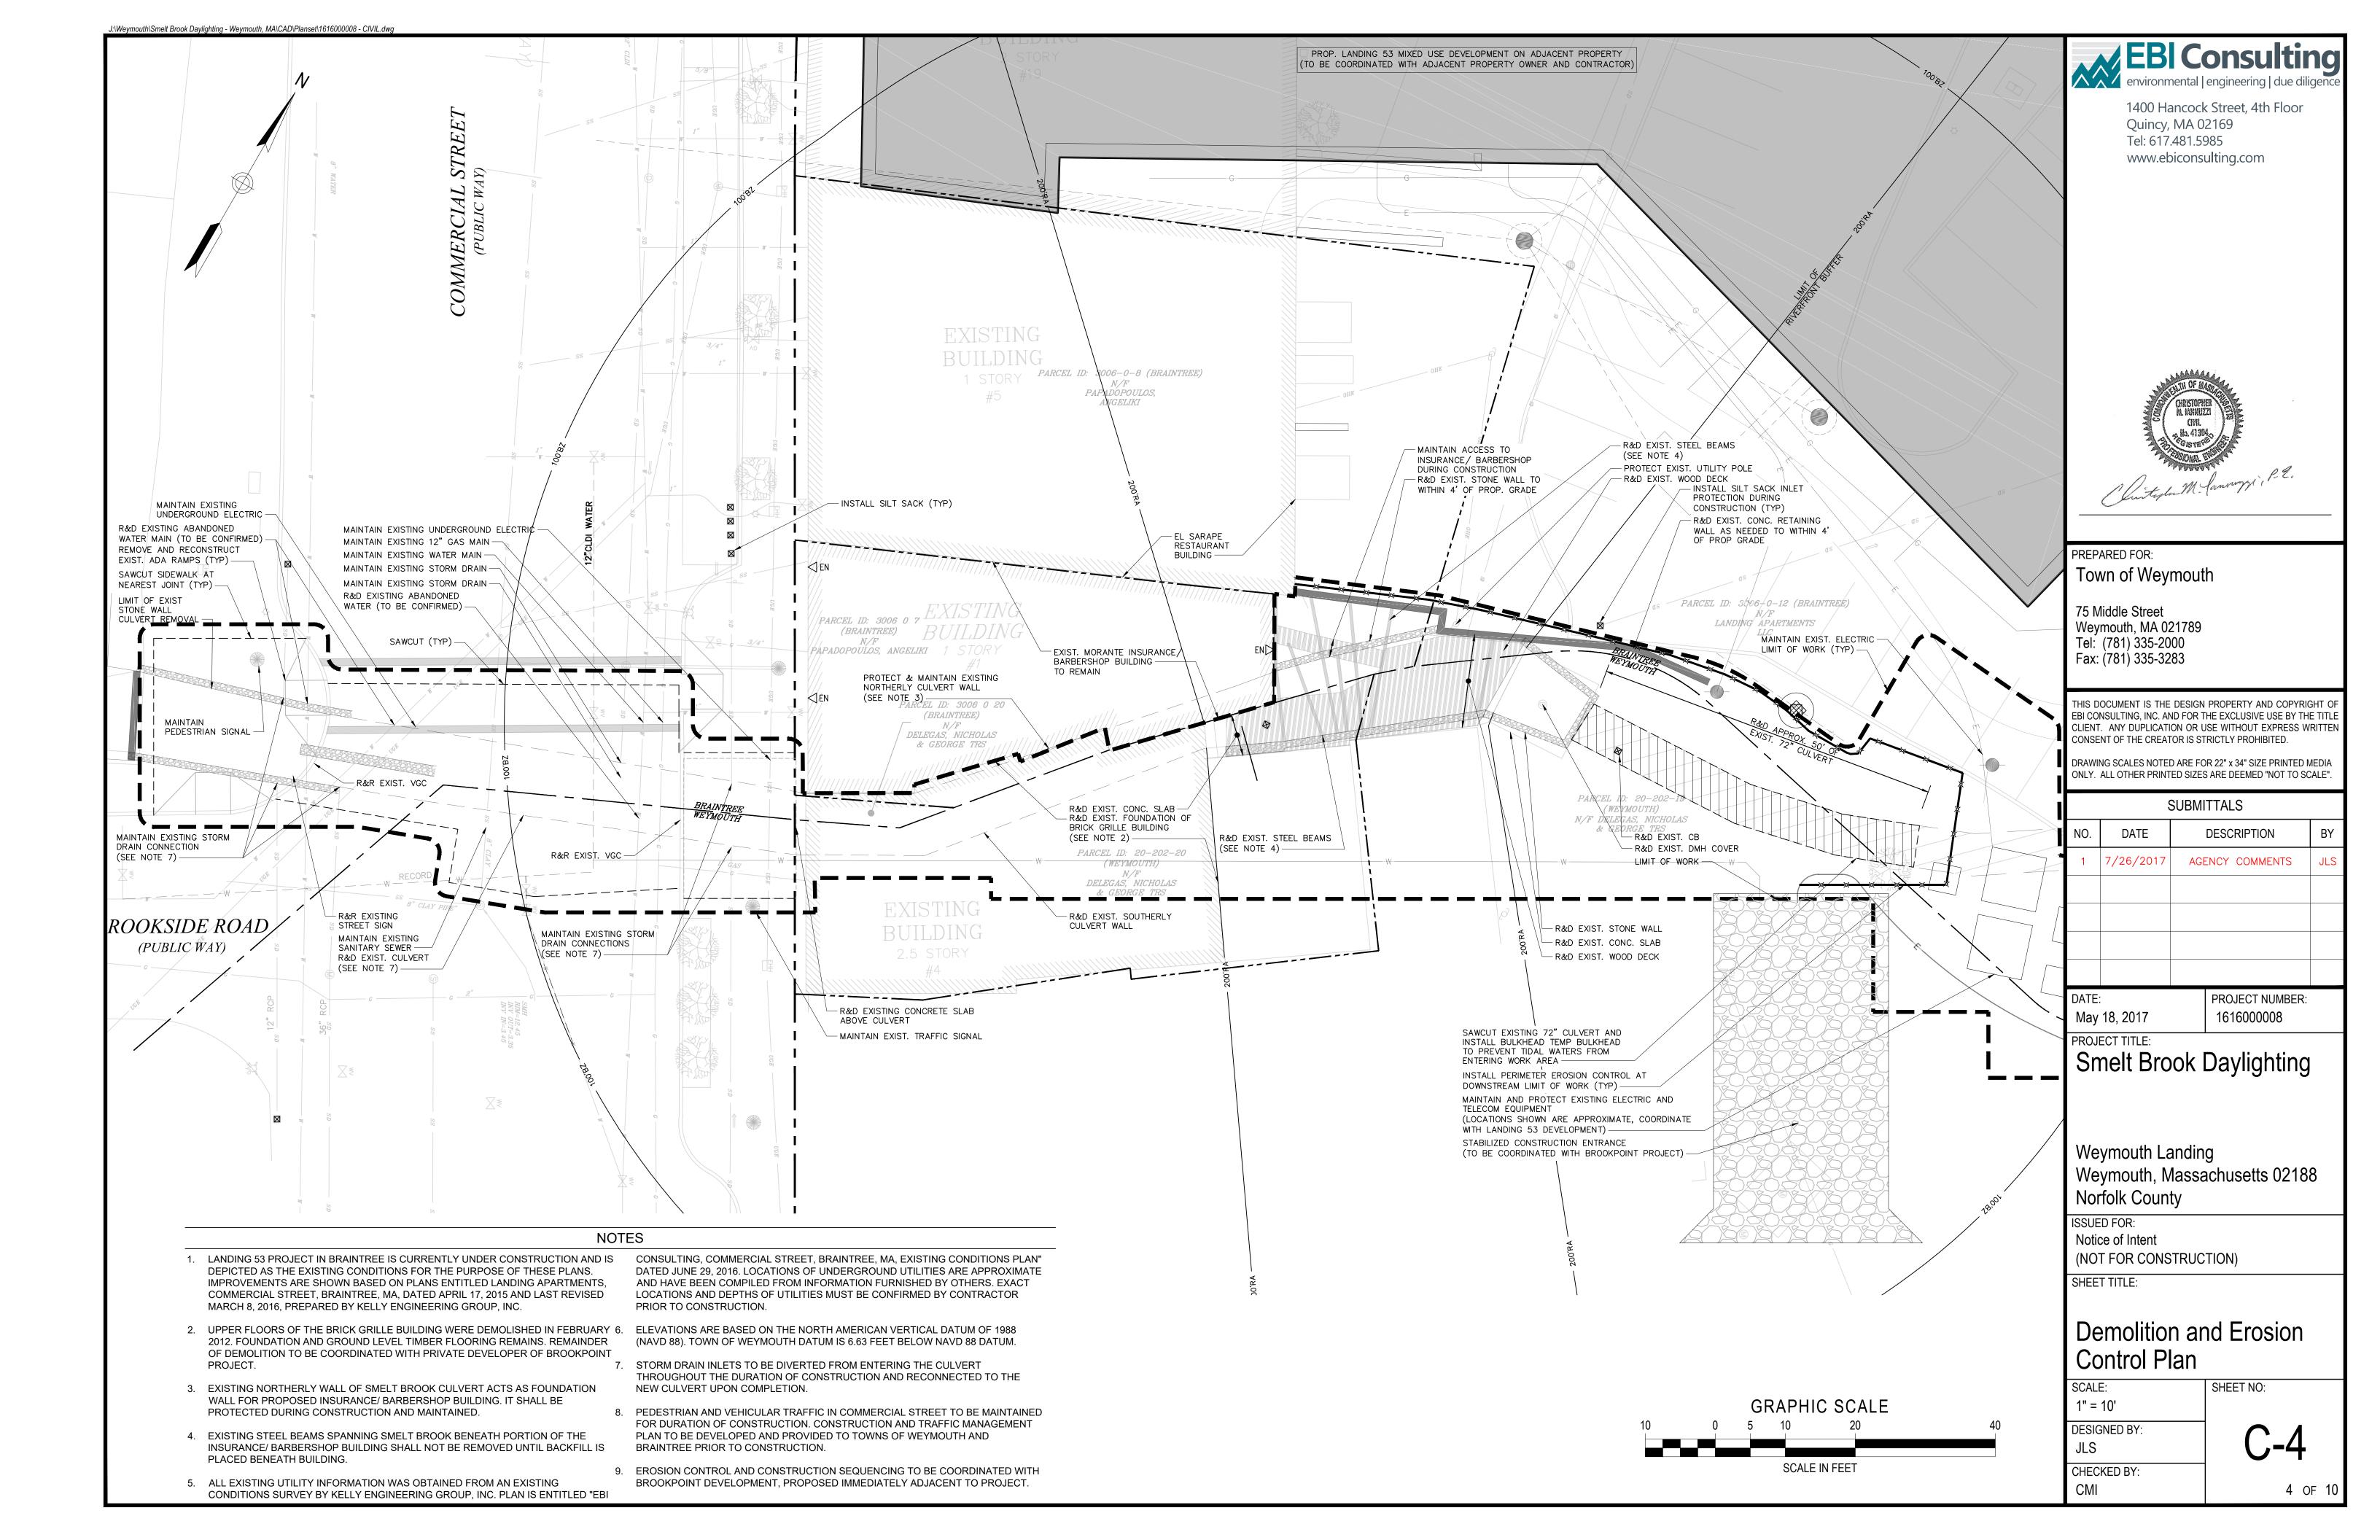

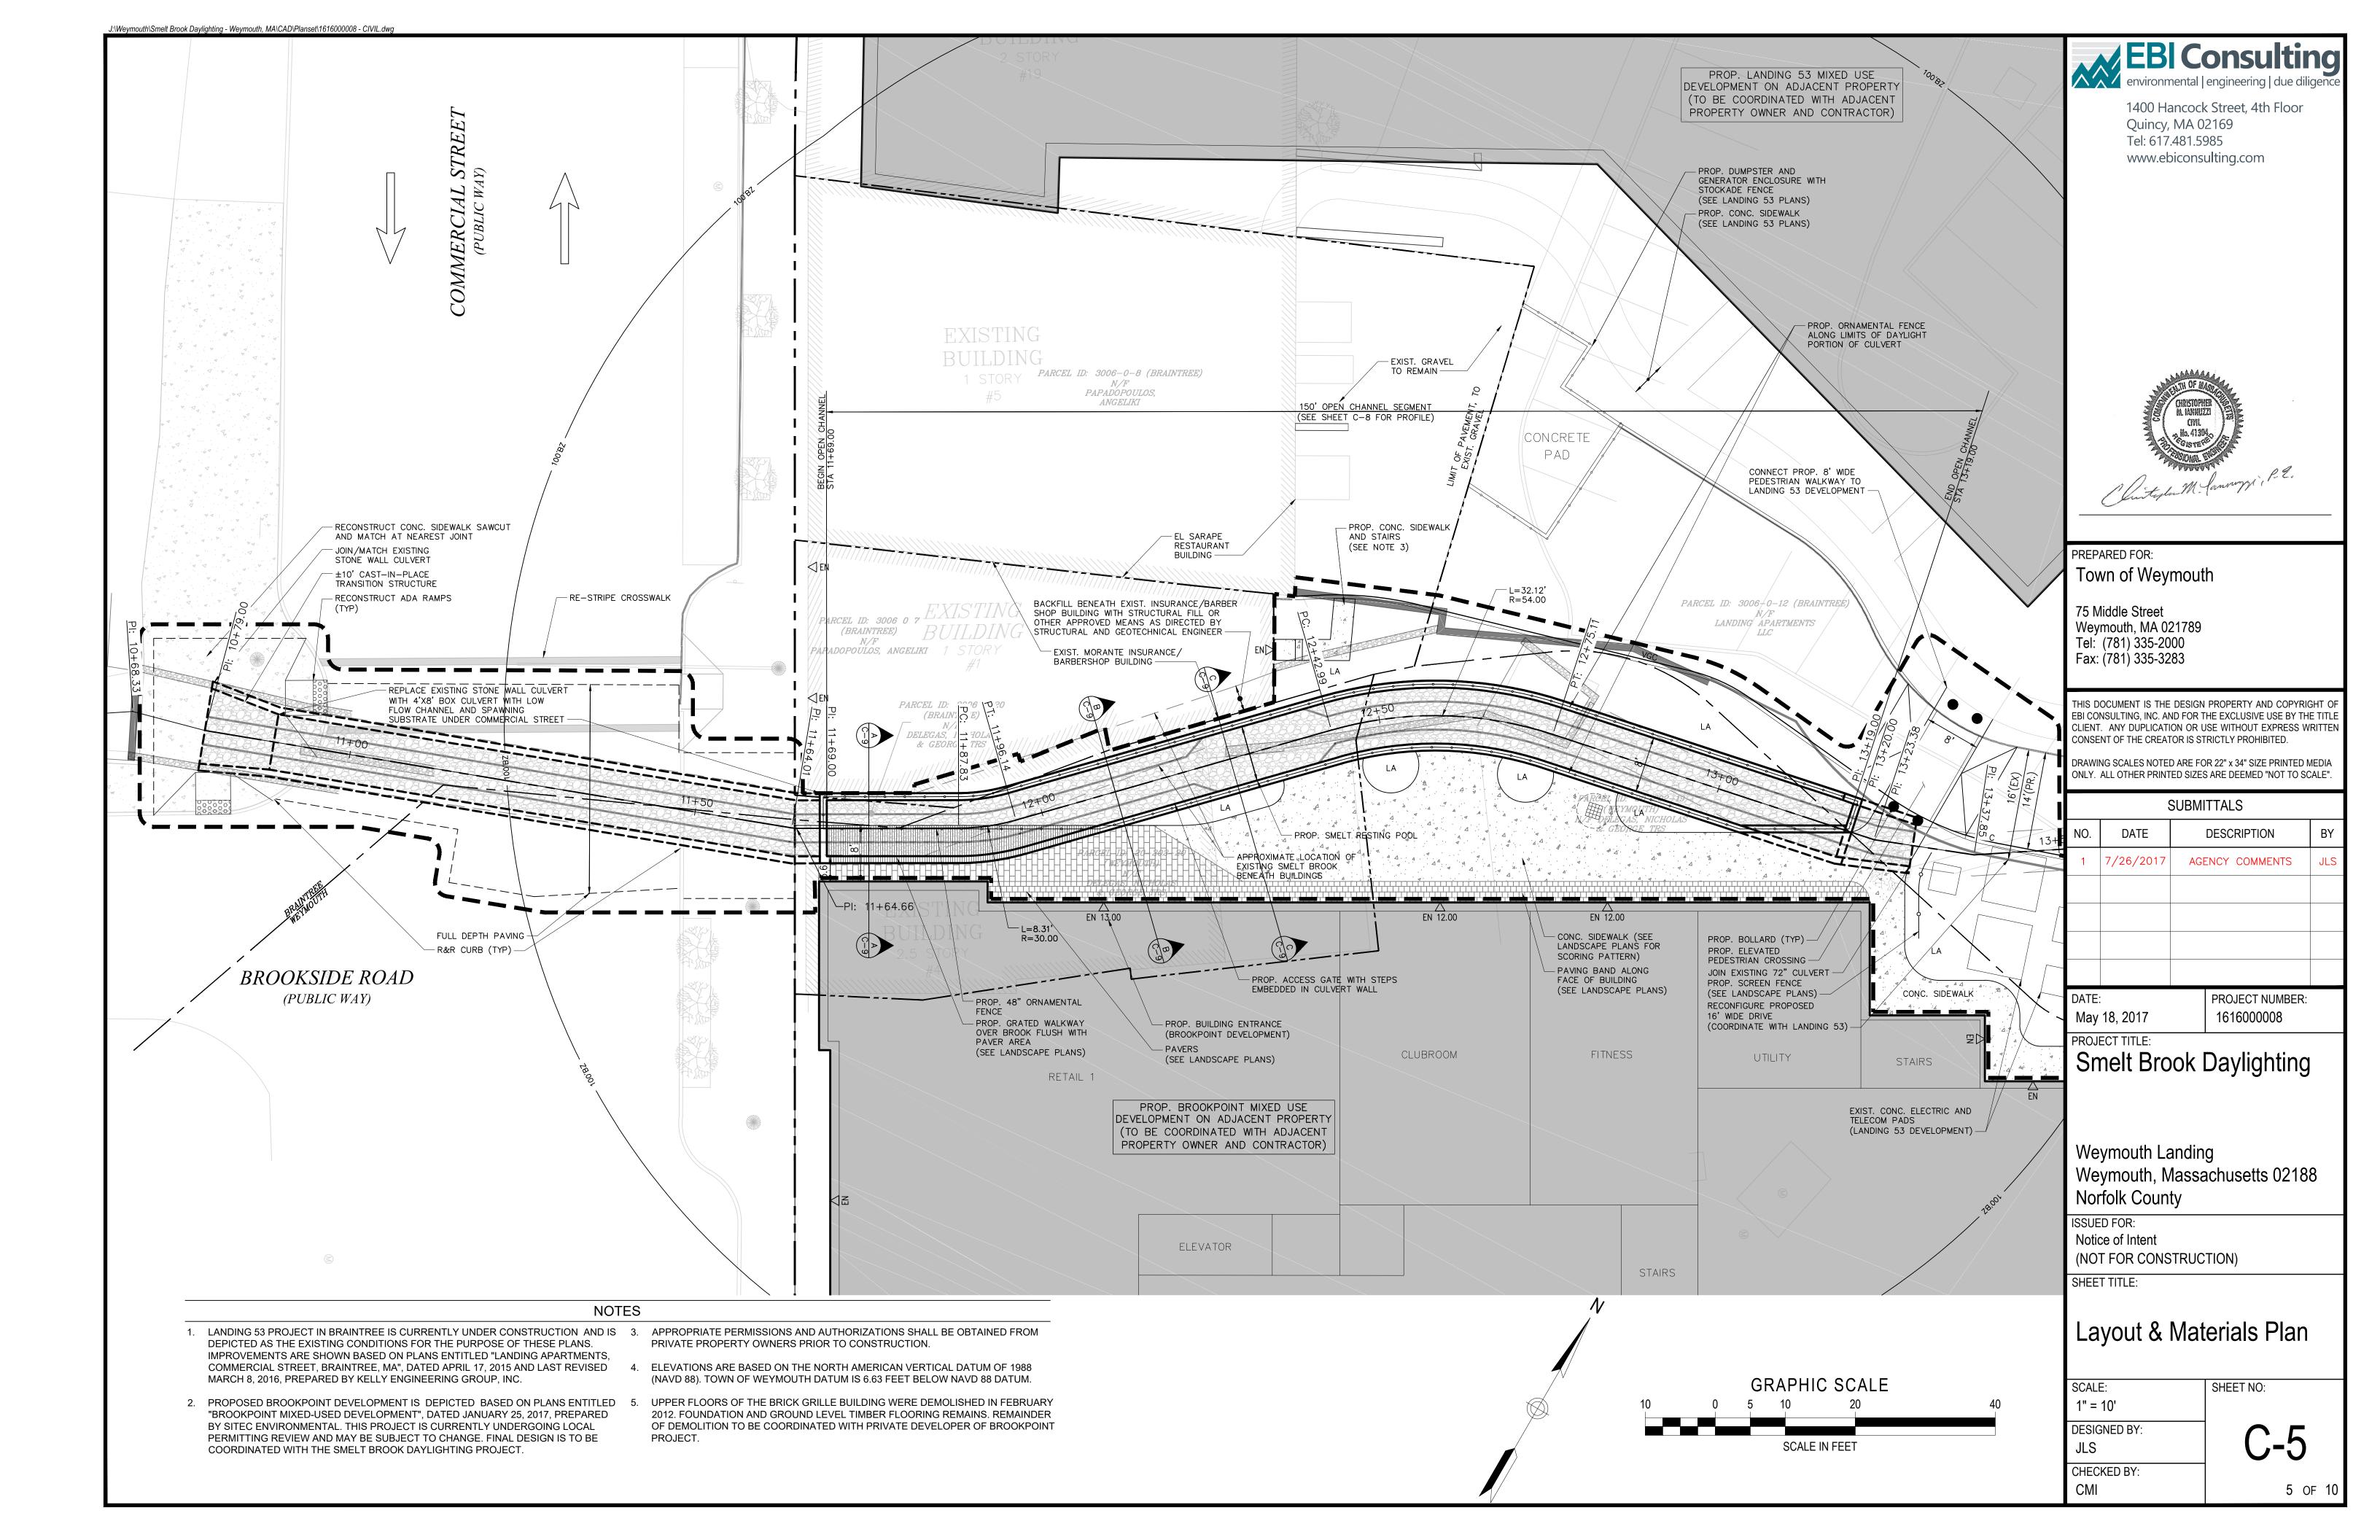

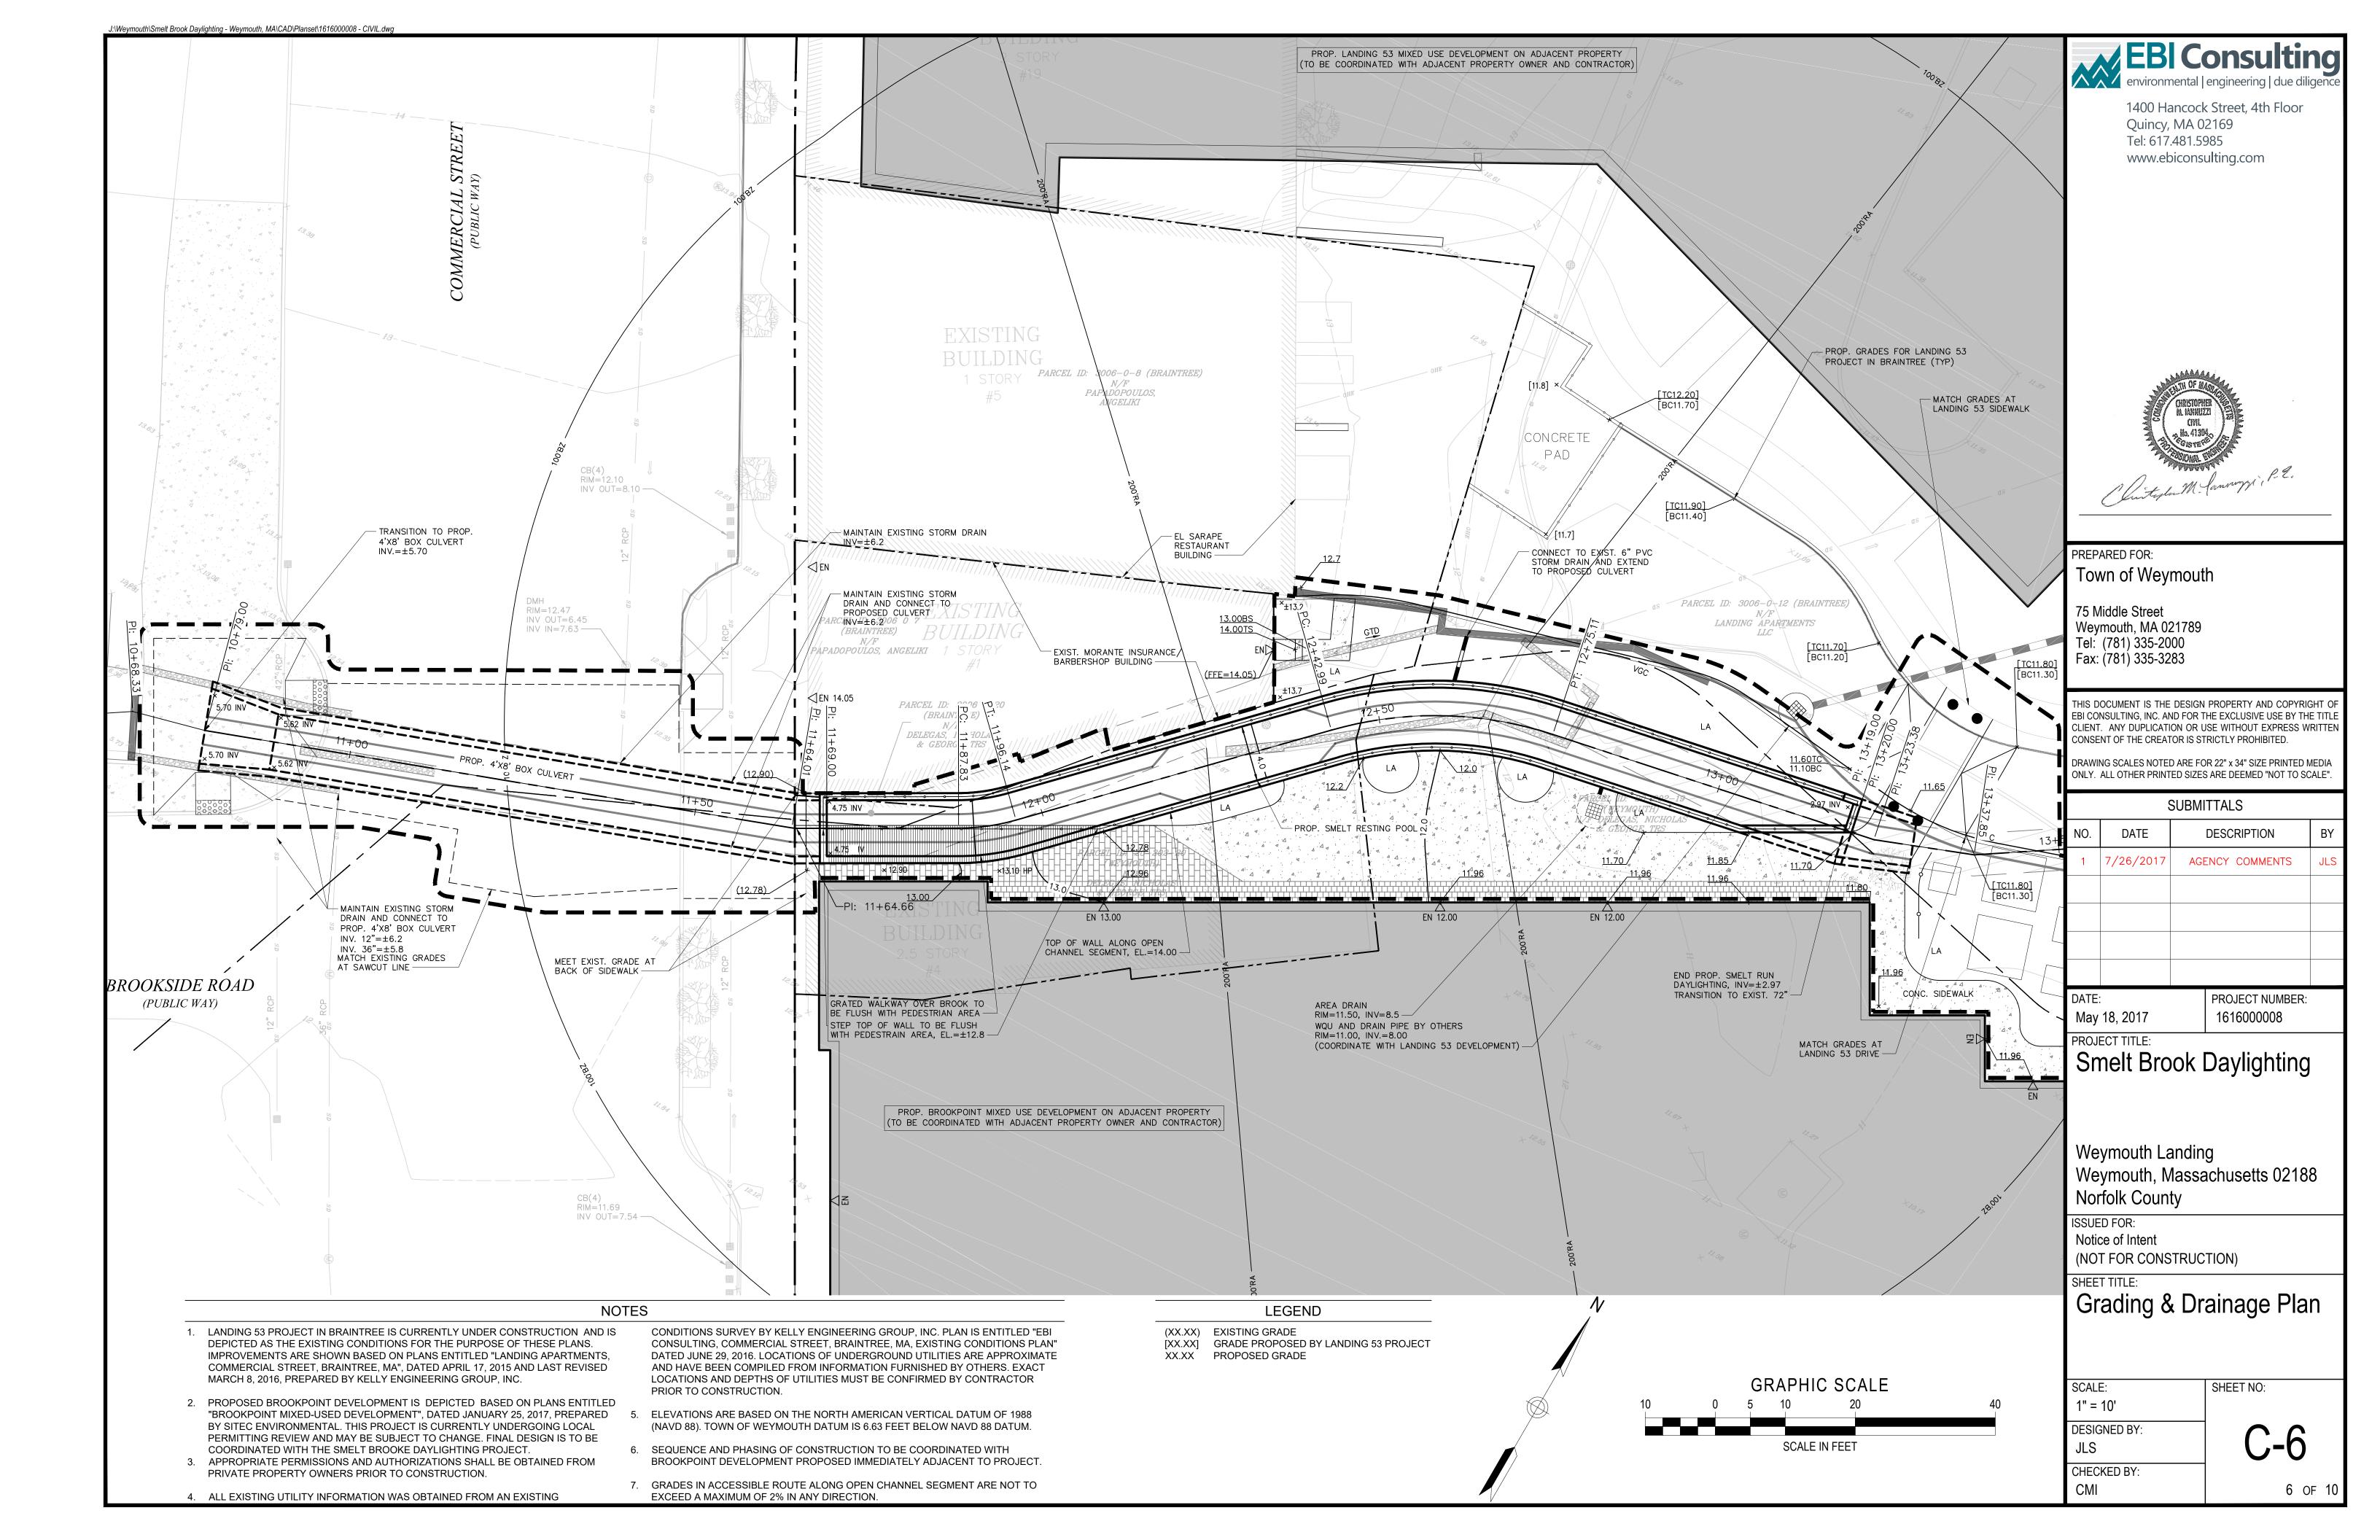

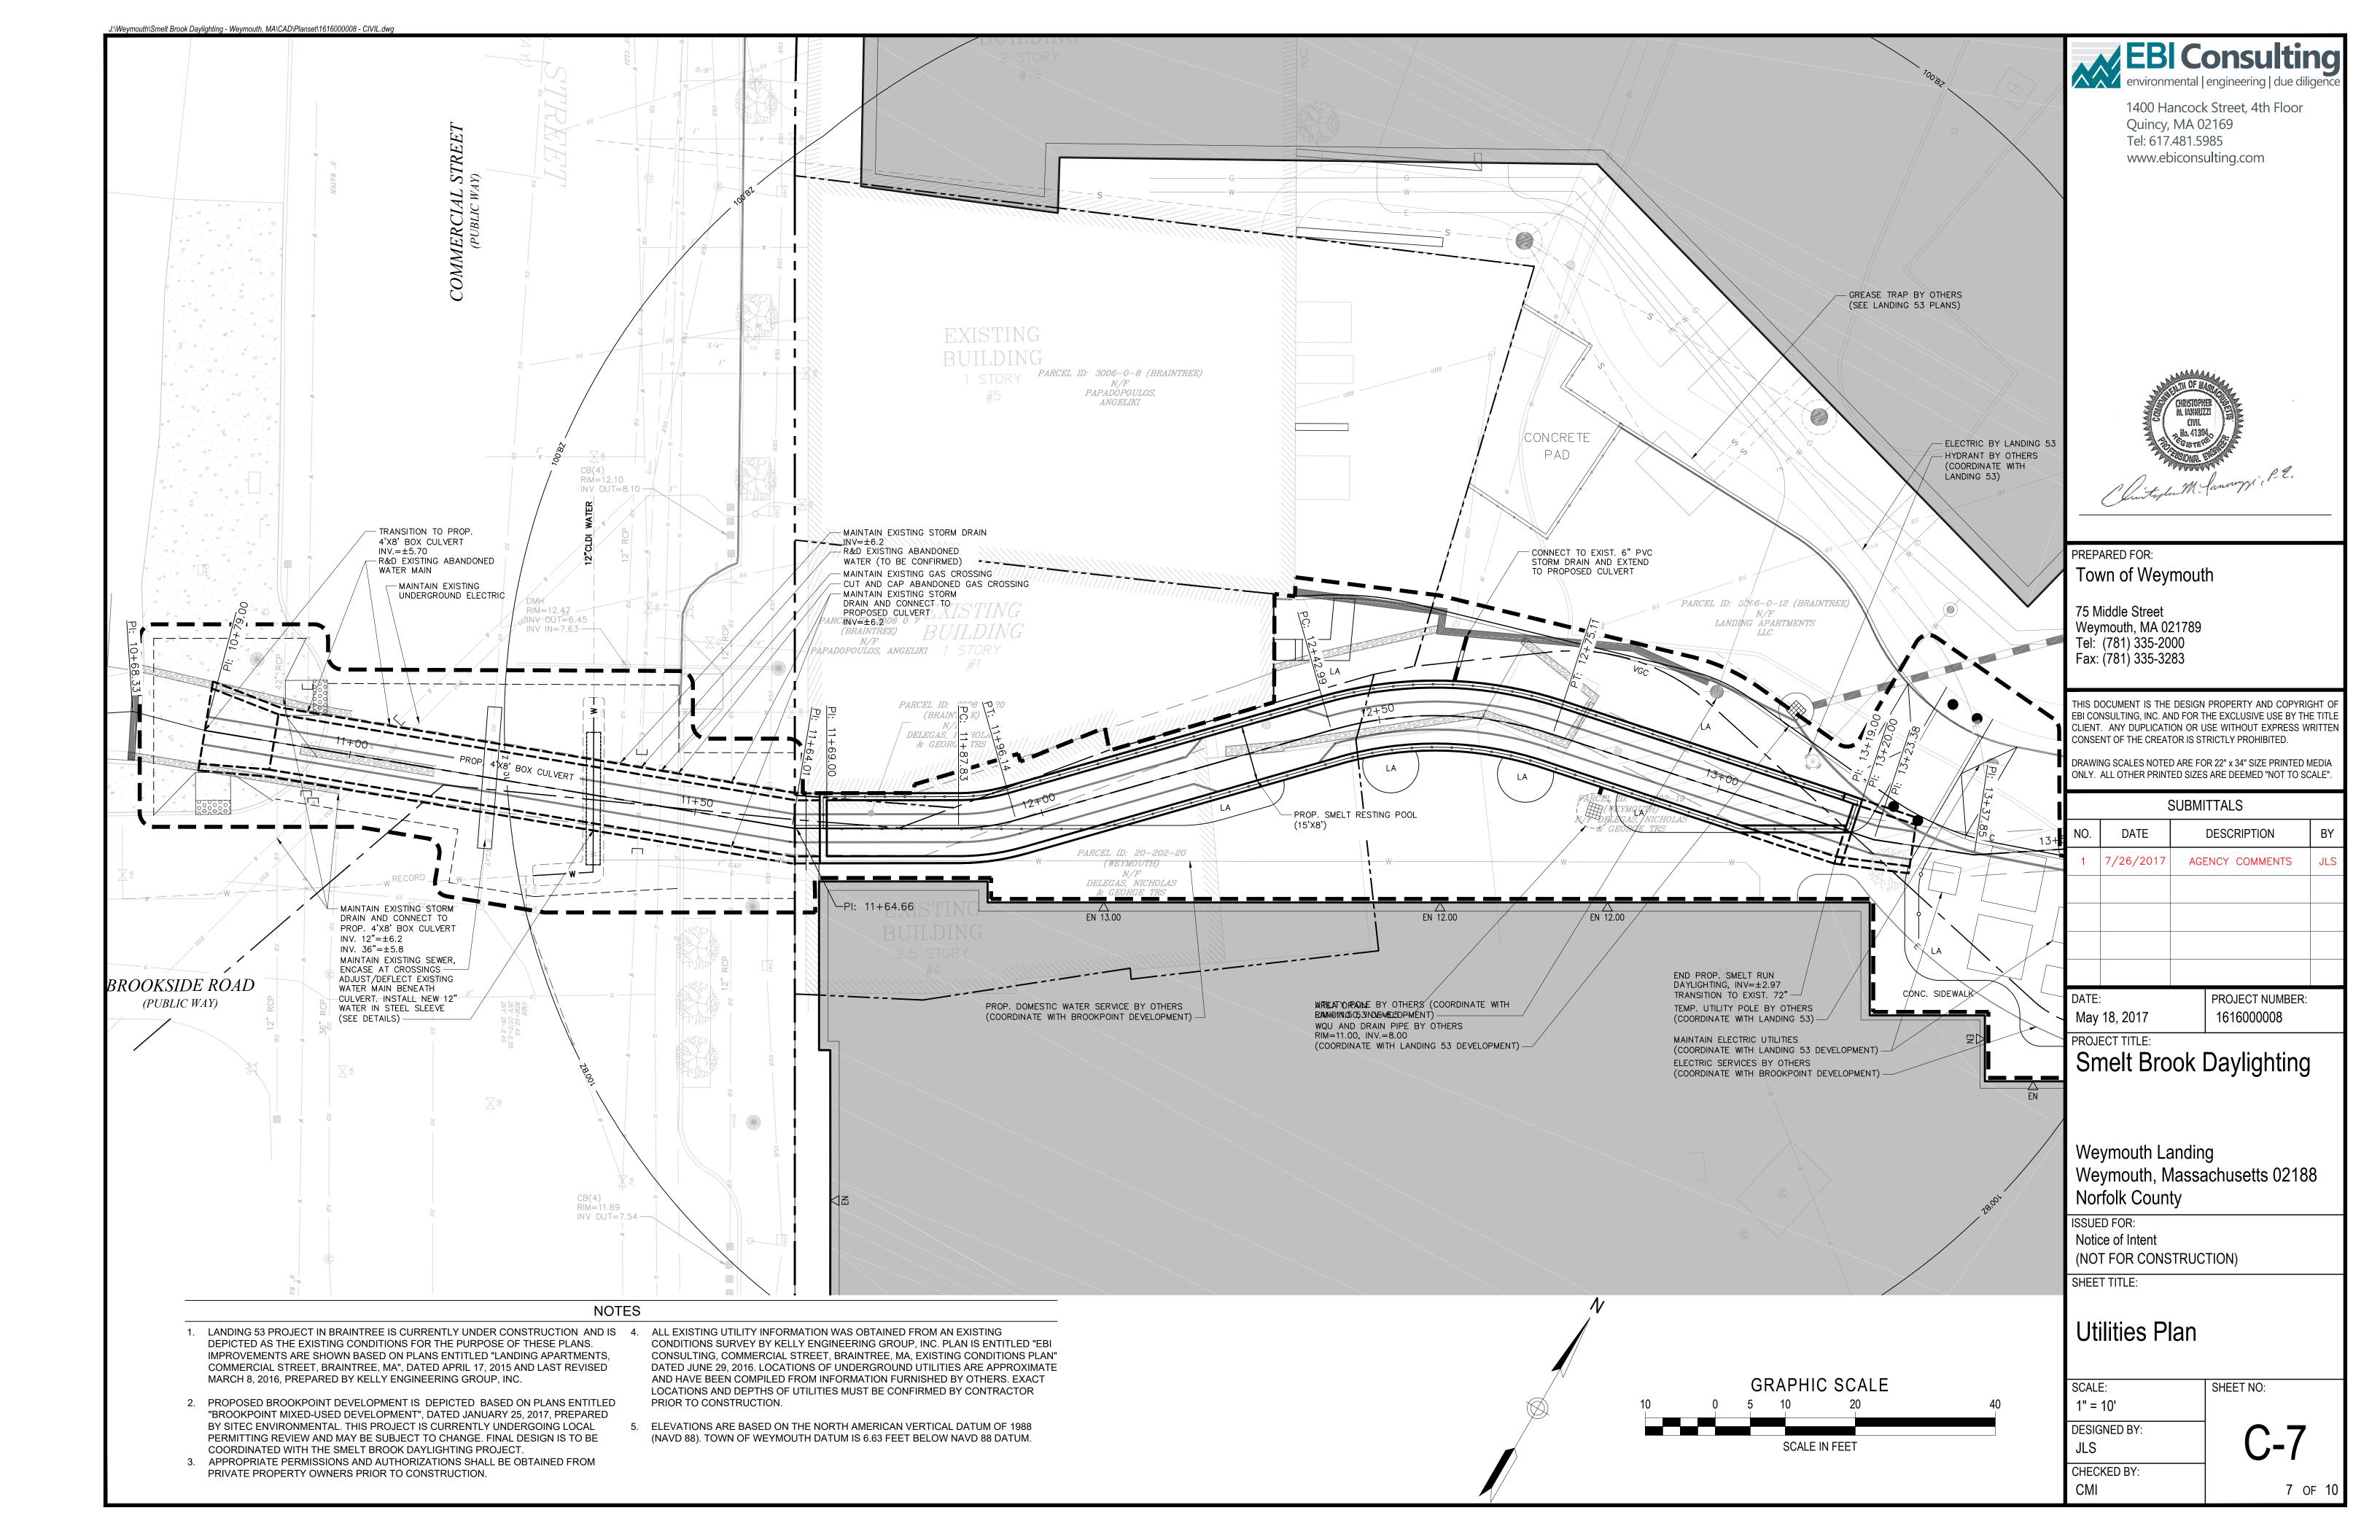

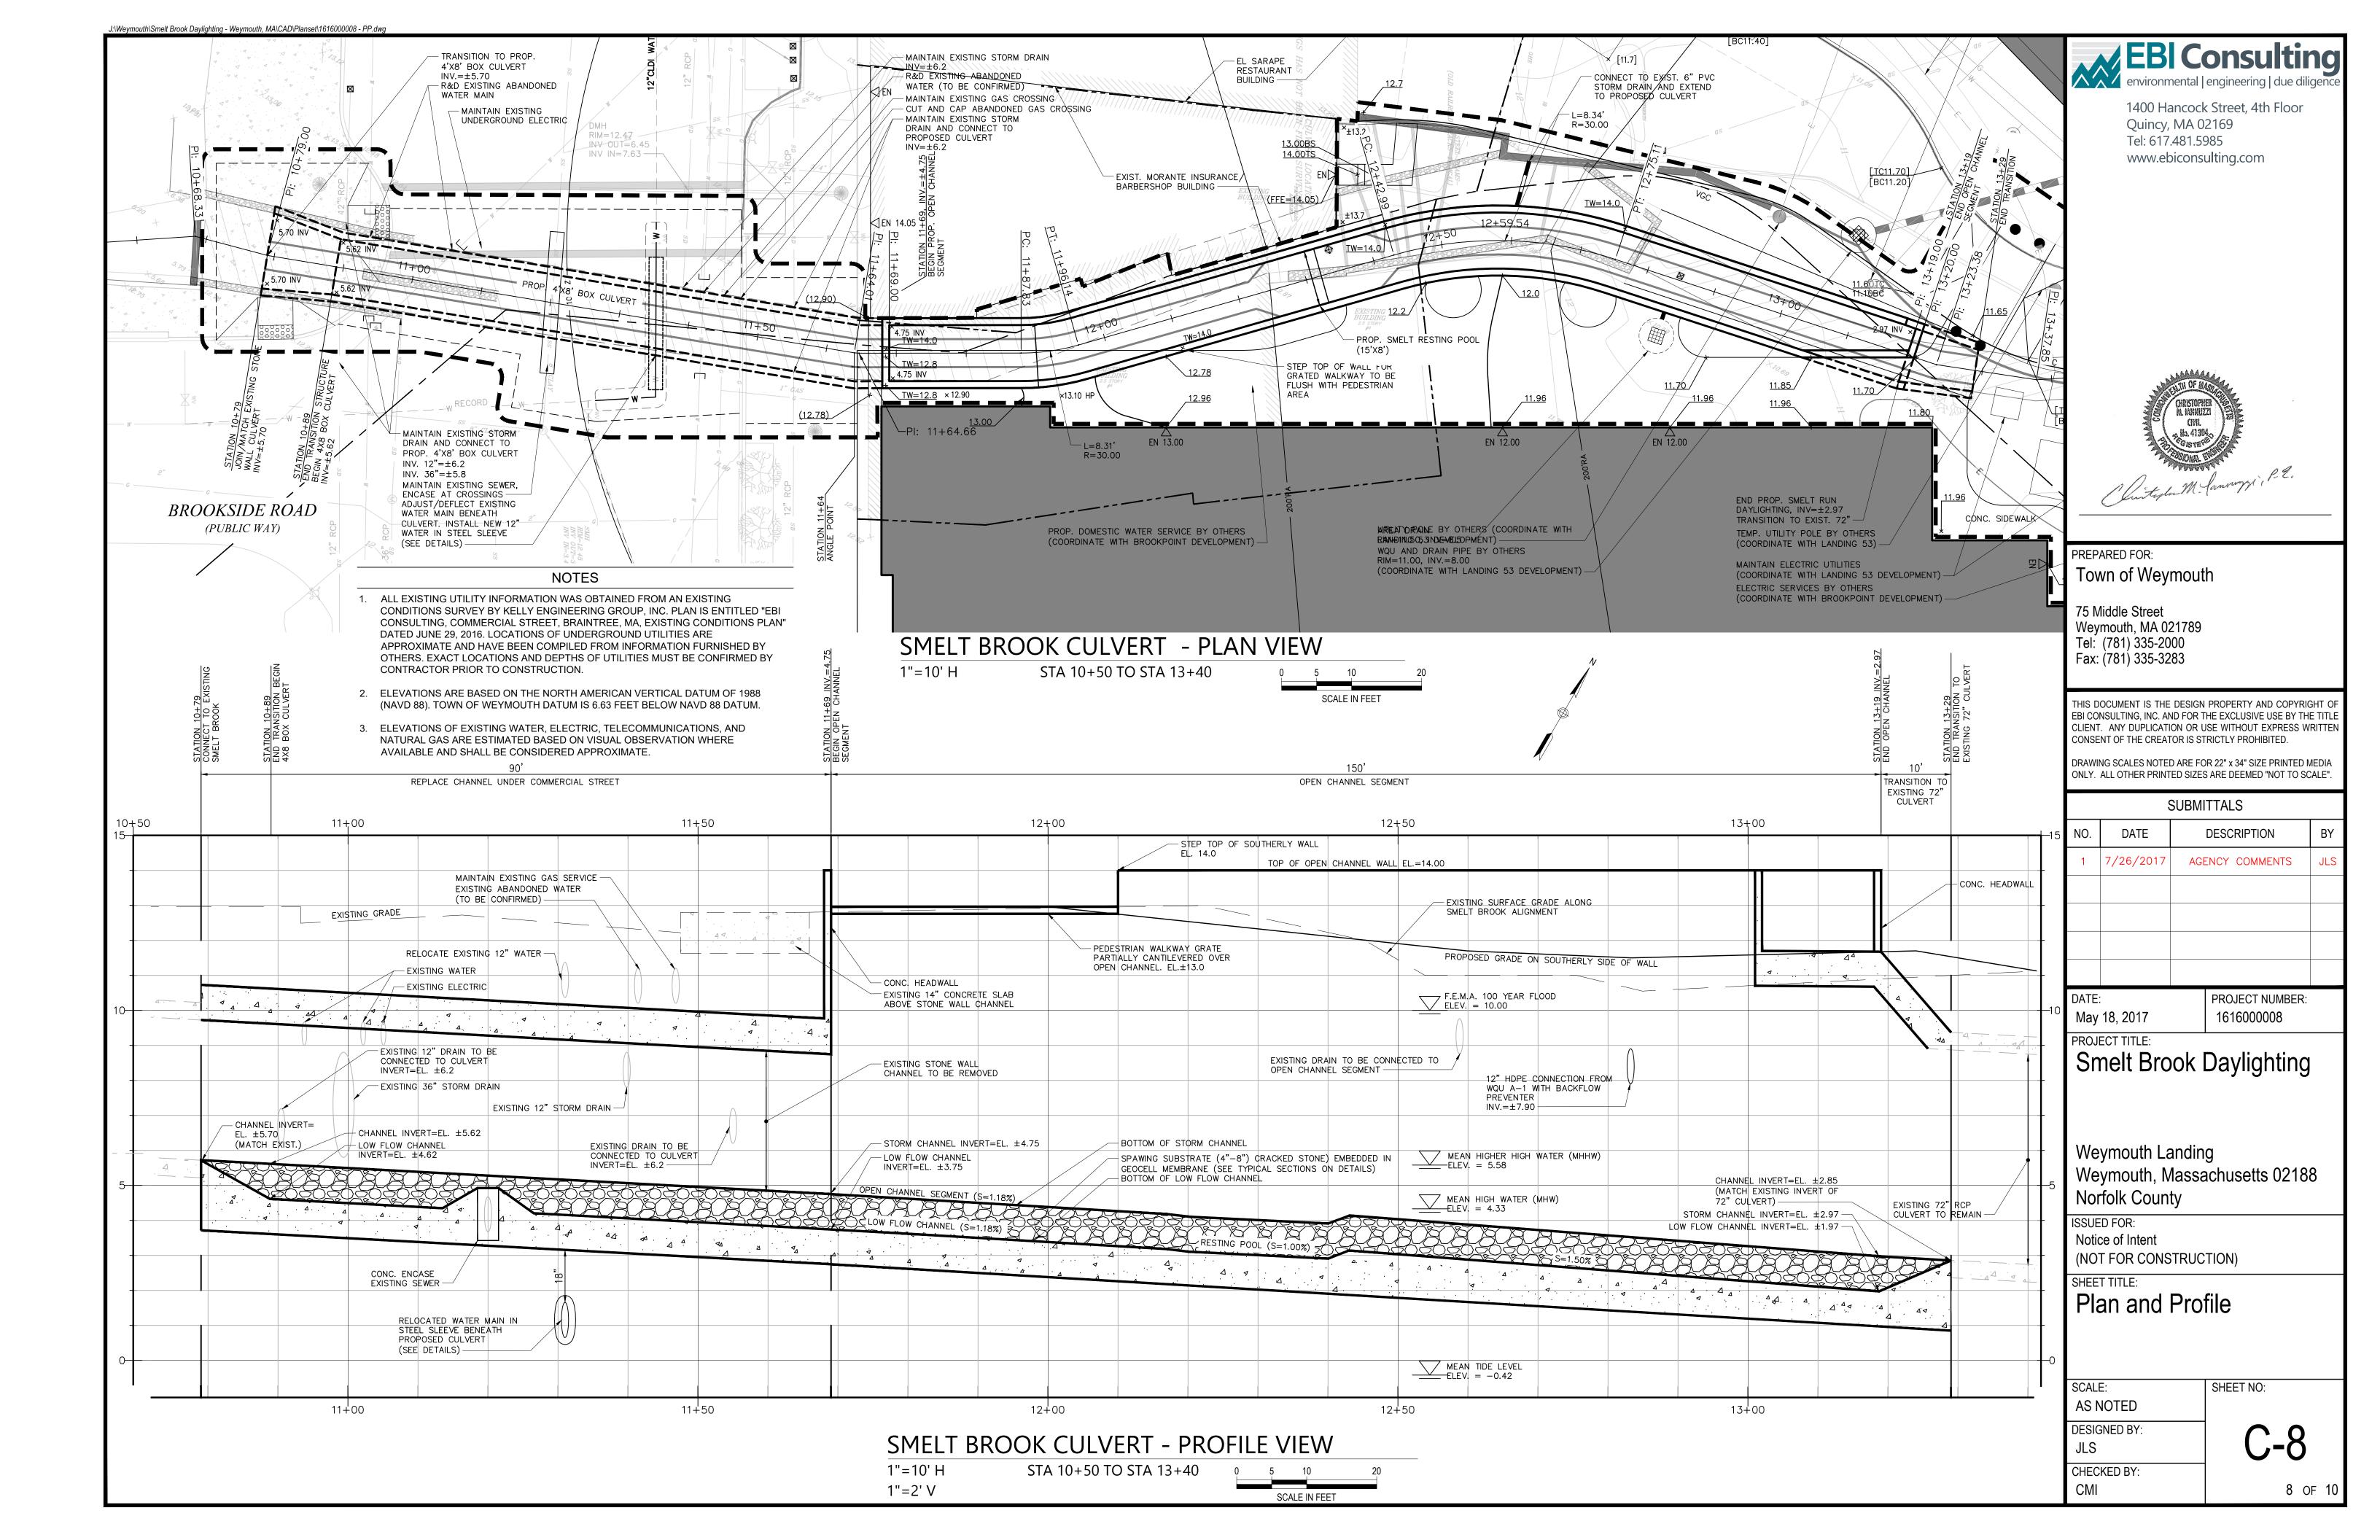

2. REFER TO THE BRICK GRILLE DEMOLITION CONSIDERATIONS MEMORANDUM PREPARED BY EBI CONSULTING

DATED OCTOBER 18, 2016 FOR ADDITIONAL DETAIL.

SCALE: N.T.S.

2,500 PSI CEMENT CONCRETE IF CURB

IS PLACED AFTER

SEE BIT CONC PAVEMENT DETAIL-

VERTICAL GRANITE CURB (VGC)

5" CEMENT CONCRETE

(8" IN VEHICULAR AREAS) -

SLOPE: 1:50 (MAX), 1:100 (MIN)

PROVIDE 2" MIN CLEAR

B" COMPACTED GRAVEL

(12" IN VEHICULAR AREAS)—

11 MAX STONE SIZE

-COMPACTED SUBGRADE

FXPANSION

CONCRETE

JOINT SEALANT

½" PREFORMED EXPANSION JOINT

Expansion Joint Detail

x6-W2.9xW2.9\WF

WIDTH VARIES

(SEE SITE PLANS)

SCALE: N.T.S.

SEE VERTICAL CURB DETAIL -

PAVEMENT DETAIL-

CONSTRUCTION NOTES

AND SEALER.

FEET ON-CENTER.

1. CEMENT CONCRETE SHALL BE 4,000 PSI-TYPE II.

2. PROVIDE EXPANSION JOINTS AT A MINIMUM 30 FEET

ON-CENTER WITH PRE-FORMED EXPANSION JOINT FILLER

3. PROVIDE TOOLED CONTROL JOINTS AT A MINIMUM SIX (6)

4. PROVIDE BROOM FINISH IN DIRECTION PERPENDICULAR TO

DISABILITIES ACT (ADA) STANDARDS FOR ACCESSIBLE


DESIGN AND THE MASSACHUSETTS ARCHITECTURAL

THE REQUIREMENTS SET FORTH IN THE AMERICANS WITH


ACCESS BOARD (AAB) RULES AND REGULATIONS (521 CMR).

TACK COAT -

SECTION A - GRATING OVER SMELT BROOK

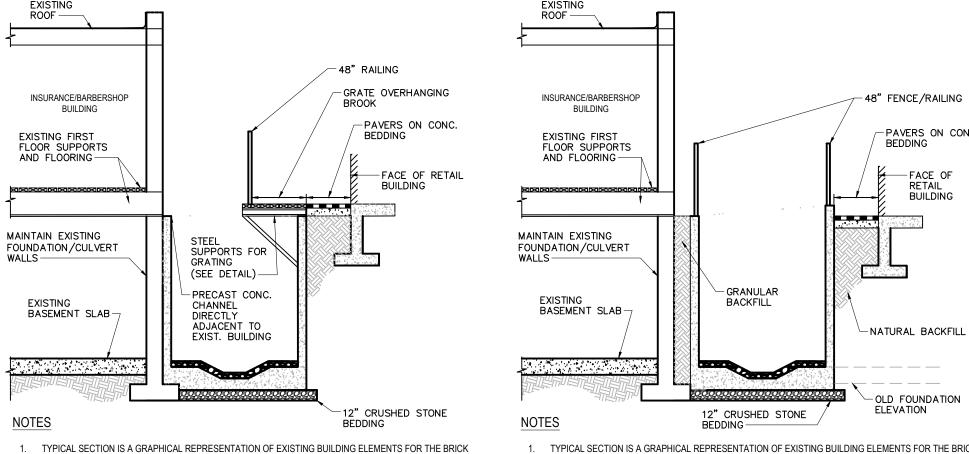

- 1. TYPICAL SECTION IS A GRAPHICAL REPRESENTATION OF EXISTING BUILDING ELEMENTS FOR THE BRICK GRILLE BUILDING, INSURANCE/BARBERSHOP BUILDING AND THE SMELT BROOK CULVERT BASED ON VISUAL GRILLE BUILDING, INSURANCE/BARBERSHOP BUILDING AND THE SMELT BROOK CULVERT BASED ON VISUAL OBSERVATION. DEMOLITION ACTIVITY AS DEPICTED ON THIS PLAN IS A GENERAL REPRESENTATION OF OBSERVATION. DEMOLITION ACTIVITY AS DEPICTED ON THIS PLAN IS A GENERAL REPRESENTATION OF PROPOSED WORK AND IS NOT INTENDED TO INCLUDE AND DETAIL ALL ASPECTS OF THE DEMOLITION PROPOSED WORK AND IS NOT INTENDED TO INCLUDE AND DETAIL ALL ASPECTS OF THE DEMOLITION
 - REFER TO THE BRICK GRILLE DEMOLITION CONSIDERATIONS MEMORANDUM PREPARED BY EBI CONSULTING

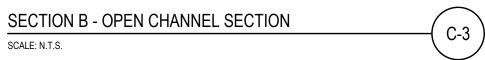

PAVERS ON CONC.

FACE OF BUILDING

(OPTIONS VARY) U-CHANNEL

-3/4" SQUARE

-FINISHED GRADE

FOOTING (3,000

PSI-TYPE I)

- COMPACTED

GRAVEL

INSURANCE/BARBERSHOR FENCE/RAILING EXISTING FIRST FLOOR SUPPORTS -PAVERS ON CONC. AND FLOORING-FACE OF BUILDING MAINTAIN EXISTING FOUNDATION/CULVERT FI.OW FILL BENEATH BUILDING TO REMAIN BASEMENT SLAB--NATURAL BACKFILL OLD FOUNDATION 12" CRUSHED STONE

1. TYPICAL SECTION IS A GRAPHICAL REPRESENTATION OF EXISTING BUILDING ELEMENTS FOR THE BRICK GRILLE BUILDING, INSURANCE/BARBERSHOP BUILDING AND THE SMELT BROOK CULVERT BASED ON VISUAL OBSERVATION. DEMOLITION ACTIVITY AS DEPICTED ON THIS PLAN IS A GENERAL REPRESENTATION OF PROPOSED WORK AND IS NOT INTENDED TO INCLUDE AND DETAIL ALL ASPECTS OF THE DEMOLITION

2. REFER TO THE BRICK GRILLE DEMOLITION CONSIDERATIONS MEMORANDUM PREPARED BY EBI CONSULTING DATED OCTOBER 18, 2016 FOR ADDITIONAL DETAIL.

ROUNDED CONCRETE CAP

SEE LANDSCAPE PLAN FOR

PAINT COLOR SELECTED BY OWNER

PAINT PRIME AND FINISH COATS

FINISHED GRADE; SURFACE

24" DIAMETER CONCRETE

6" COMPACTED GRAVEL

COMPACTED SUBGRADE

ENCASEMENT

BOLLARD TYPE


OR ARCHITECT

METAL SURFACES

TREATMENT VARIES

(SEE SITE PLANS)

CONCRETE FILL

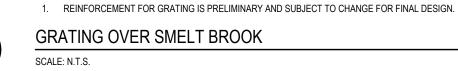

±5.0' (VARIES)

- SEE LANDSCAPE PLANS FOR GRATING


- WHITE PAINT


-WHITE PAINTED

2'-0" 3'-0"

-4" WHITE PAINT (TYP)

L4X4X3/8-

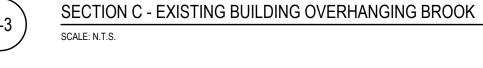

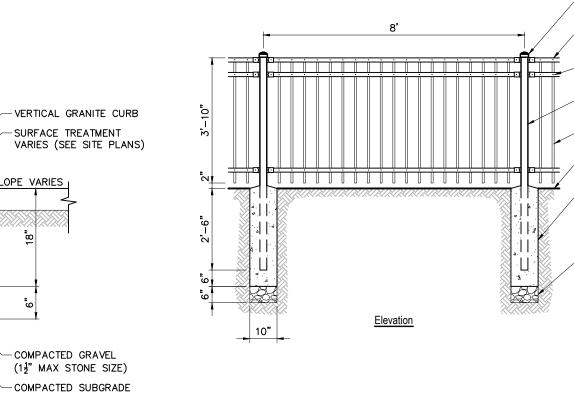



STEEL EDGING; 4" X 18"; FINISH BLACK; TOP OF EDGING

TO BE FLUSH WITH GRADE.
INSTALL PER MANUFACTURER-

LANDSCAPED AREA (SEE

LANDSCAPE PLANS) -

COMPACTED GRAVEL

(1½" MAX STONE SIZE) —

COMPACTED SUBGRADE -

CONSTRUCTION NOTES

1. CEMENT CONCRETE SHALL BE 4,000 PSI-TYPE II.

FOR ACCESSIBLE ROUTES, SIDEWALKS SHALL CONFORM TO

THE REQUIREMENTS SET FORTH IN THE AMERICANS WITH

ACCESS BOARD (AAB) RULES AND REGULATIONS (521 CMR).

WALKING SURFACES SHALL NOT BE GREATER THAN 1:20.

THE CROSS SLOPE OF WALKING SURFACES SHALL NOT BE

PERMANENT OBSTACLE; HYDRANTS, UTILITY POLES, SIGN POSTS, ET

DISABILITIES ACT (ADA) STANDARDS FOR ACCESSIBLE


DESIGN AND THE MASSACHUSETTS ARCHITECTURAL

FOR ACCESSIBLE ROUTES, THE RUNNING SLOPE OF

GREATER THAN 1:50 OR LESS THAN 1:100.

1. FENCE TO BE INSTALLED PER MANUFACTURERS RECOMMENDATIONS.

- 2. POSTS SHALL MAINTAIN A MINIMUM DEPTH OF 2'-6" IN GROUND AND SHALL NOT BE RACKED TO ACCOMMODATE CHANGES IN GRADE
- 3. LINE OF FENCE TOP AND BOTTOM SHALL BE INSTALLED STRAIGHT AND TRUE. POSTS AND PICKETS SHALL BE INSTALLED PARALLEL AND PLUMB. RAILS SHALL BE INSTALLED PARALLEL TO GROUND SURFACE AND

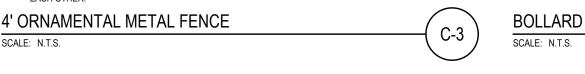

CROSS SLOPE:

1:50 (MAX), 1:100 (MIN)

23" CONCRETE PAVERS WITH

-1" BITUMINOUS SETTING BED

1" (MAX) SWEPT JOINTS

- NEOPRENE TACK COAT

TYPICAL EXPANSION

JOINT WHERE ABUTTING FIXED EDGE OR BUILDING -

-CONCRETE BASE

WITH W.W. MESH

(6x6x6W1.4xW1.4)

FLAT SHEETS -

JOINT SEALANT-

½" PREFORMED


EXPANSION JOINT


FIXED OBJECT, OR


Expansion Joint Detai


CONC SIDEWALK -


EXPANSION

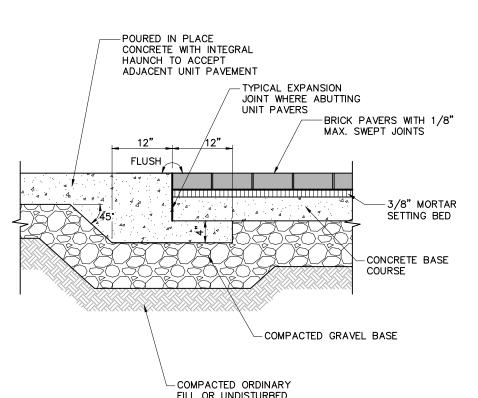

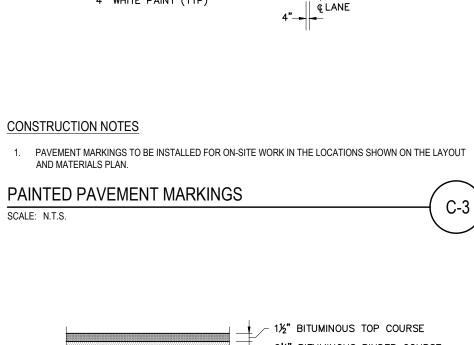

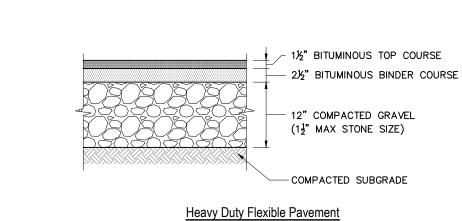

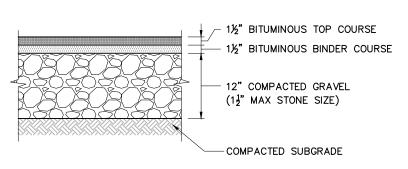

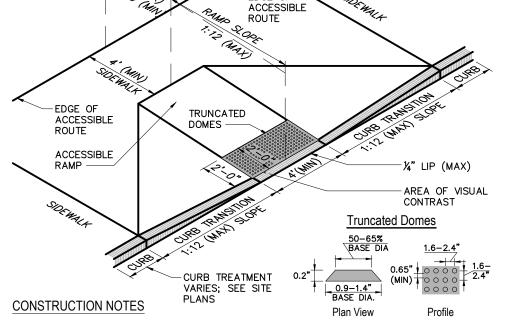

- 1. CURB RAMPS SHALL CONFORM TO THE REQUIREMENTS SET FORTH IN THE AMERICANS WITH DISABILITIES ACT (ADA) STANDARDS FOR ACCESSIBLE DESIGN AND THE MASSACHUSETTS ARCHITECTURAL ACCESS BOARD (AAB) RULES AND REGULATIONS (521 CMR).
- 2. THE RUNNING SLOPE OF CURB RAMPS SHALL NOT BE GREATER THAN 1:12. THE RUNNING SLOPE OF WALKING SURFACES SHALL NOT BE GREATER THAN 1:20. THE CROSS SLOPE OF CURB RAMPS AND WALKING SURFACES SHALL NOT BE GREATER THAN 1:50 OR LESS THAN 1:100.
- INCHES (3 FEET) MINIMUM. THE LANDING CLEAR WIDTH SHALL BE AT LEAST AS WIDE AS THE CURB RAMP,
- 4. COUNTER SLOPES OF ADJOINING SURFACES IMMEDIATELY ADJACENT TO THE CURB RAMP SHALL NOT BE STEEPER THAN 1:20.
- INSTALLED PERPENDICULAR TO THE ACCESSIBLE ROUTE.

ACCESSIBLE CURB RAMP (ACR) TYPE 'D' SCALE: N.T.S.

nvironmental | engineering | due diligend

www.ebiconsulting.com

Quincy, MA 02169

Tel: 617.481.5985

1400 Hancock Street, 4th Floor

PREPARED FOR: Town of Weymouth

75 Middle Street Weymouth, MA 021789 Tel: (781) 335-2000 Fax: (781) 335-3283

THIS DOCUMENT IS THE DESIGN PROPERTY AND COPYRIGHT O EBI CONSULTING, INC. AND FOR THE EXCLUSIVE USE BY THE TITL CLIENT. ANY DUPLICATION OR USE WITHOUT EXPRESS WRITTEN CONSENT OF THE CREATOR IS STRICTLY PROHIBITED.

DRAWING SCALES NOTED ARE FOR 22" x 34" SIZE PRINTED MEDIA ONLY. ALL OTHER PRINTED SIZES ARE DEEMED "NOT TO SCALE".

SUBMITTALS				
NO.	DATE	DESCRIPTION	BY	
1	7/26/2017	AGENCY COMMENTS	JLS	

May 18, 2017

PROJECT NUMBER: 1616000008

PROJECT TITLE:

Smelt Brook Daylighting

Weymouth Landing Weymouth, Massachusetts 02188 Norfolk County

ISSUED FOR: Notice of Intent

(NOT FOR CONSTRUCTION) SHEET TITLE:

Site Details '

CMI

SCALE: SHEET NO: N.T.S. **DESIGNED BY:** CHECKED BY:

CONCRETE SIDEWALK SCALE: N.T.S.

PERMANENT OBSTACLE; HYDRANTS, UTILITY POLES, SIGN POSTS, ETC.

5. FOR ACCESSIBLE ROUTES, SIDEWALKS SHALL CONFORM TO FIXED OBJECT, OR

6. FOR ACCESSIBLE ROUTES, THE RUNNING SLOPE OF WALKING SURFACES SHALL NOT BE GREATER THAN 1:20.

THE CROSS SLOPE OF WALKING SURFACES SHALL NOT BE GREATER THAN 1:50 OR LESS THAN 1:100.

7. FOR ACCESSIBLE ROUTES, WHERE THE SIDEWALK IS LESS THAN FIVE (5) FEET IN WIDTH, EXCLUDING

CURBING, A 5' X 5' PASSING AREA SHALL BE PROVIDED AT INTERVALS NOT TO EXCEED 200 FEET.


8. FOR ACCESSIBLE ROUTES, A MINIMUM CLEARANCE OF THREE (3) FEET SHALL BE MAINTAINED AT ANY

CONCRETE UNIT PAVERS SCALE: N.T.S.

FOR ACCESSIBLE ROUTES, WHERE THE SIDEWALK IS LESS THAN FIVE (5) FEET IN WIDTH, EXCLUDING

CURBING, A 5' X 5' PASSING AREA SHALL BE PROVIDED AT INTERVALS NOT TO EXCEED 200 FEET.

5. FOR ACCESSIBLE ROUTES, A MINIMUM CLEARANCE OF THREE (3) FEET SHALL BE MAINTAINED AT ANY

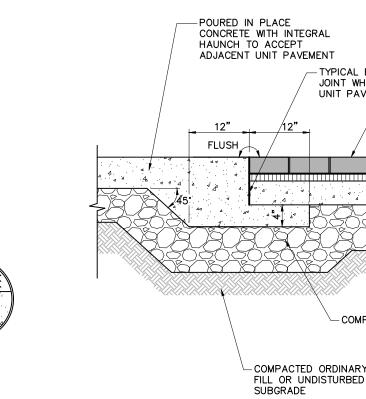

SCALE: N.T.S.

POURED IN PLACE CONCRETE TO **UNIT PAVERS TRANSITION**

SCALE: N.T.S.

CONSTRUCTION NOTES PAVEMENT SECTIONS ARE SUBJECT TO CHANGE AND WILL BE BASED ON THE RESULTS OF FURTHER GEOTECHNICAL INVESTIGATIONS. BITUMINOUS CONCRETE PAVEMENT

Standard Duty Flexible Pavement

3. LANDINGS SHALL BE PROVIDED AT THE TOPS OF CURB RAMPS. THE LANDING CLEAR LENGTH SHALL BE 36 EXCLUDING FLARED SIDES, LEADING TO THE LANDING.

5. DETECTABLE WARNINGS SHALL CONTRAST VISUALLY WITH ADJACENT WALKING SURFACES AND BE

CONSTRUCTION NOTES

GRANULAR FILL-

CONSTRUCTION NOTES

UTILITY TRENCH

SCALE: N.T.S.

2. USE METALLIC TRACING/WARNING TAPE OVER ALL PIPES.

3. FOR HIGH DENSITY POLYETHYLENE (HDPE) PIPE, DIMENSION IS 24 INCHES.

SAWCUT LINE-

COMPACTED

SUBGRADE -

PAVED AREA

SEE APPLICABLE PAVEMENT SECTIONS

1. ENTRANCE WIDTH SHALL BE A TWENTY-FIVE (25) FOOT MINIMUM, BUT NOT LESS THAN THE FULL WIDTH AT POINTS WHERE INGRESS OR EGRESS OCCURS.

Cross-section

- 2. THE ENTRANCE SHALL BE MAINTAINED IN A CONDITION WHICH SHALL PREVENT TRACKING OR FLOWING OF SEDIMENT ONTO PUBLIC RIGHTS-OF-WAY. THIS MAY REQUIRE PERIODIC TOP DRESSING WITH ADDITIONAL STONE AS CONDITIONS DEMAND AND REPAIR OR CLEANOUT OF ANY MEASURES USED TO TRAP SEDIMENT ALL SEDIMENT SPILLED, DROPPED, WASHED OR TRACKED ONTO PUBLIC RIGHTS-OF-WAY MUST BE REMOVED IMMEDIATELY. PERIODIC INSPECTION AND MAINTENANCE SHALL BE PROVIDED AS NEEDED.
- 3. STABILIZED CONSTRUCTION ENTRANCE SHALL BE REMOVED PRIOR TO FINAL FINISHED MATERIALS BEING



1. WHERE UTILITY TRENCHES ARE CONSTRUCTED THROUGH DETENTION BASIN BERMS OR OTHER SUCH

SPECIAL SECTIONS, PLACE TRENCH BACKFILL WITH MATERIALS SIMILAR TO THE SPECIAL SECTION

LOW FLOW CHANNEL WITH 6"-8" DIA. CRACKED STONE

IN GEOCELL SECURED TO

- COMPACTED SUBGRADE

12" COMPACTED GRAVEL

95% STANDARD PROCTOR

FORMED IN REINFORCED

CONCRETE BOX CULVER

CHANNEL BOTTOM



LANDSCAPED AREA



COMMON FILL/

ORDINARY

TREATMENT


TRACING/ WARNING TAPE

BEDDING

COMPACTED

-HAND TAMPED HAUNCHING - COMPACTED

BORROW

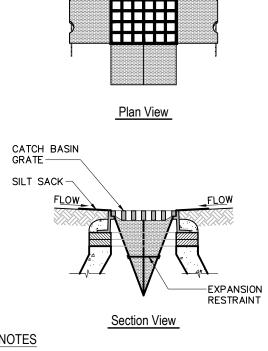

1" REBAR FOR

BAG REMOVAL

CATCH BASIN

GRATE -

SILT SACK-

CONSTRUCTION NOTES


- INSTALL SILT SACKS IN ALL CATCH BASINS WHERE INDICATED ON THE SITE PLANS BEFORE COMMENCING WORK OR IN PAVED AREAS AFTER THE BINDER COURSE IS PLACED AND EROSION CONTROL BARRIERS HAVE
- 2. GRATE TO BE PLACED OVER SILT SACK.
- 3. SILT SACKS SHALL BE INSPECTED PERIODICALLY AND AFTER ALL STORM EVENTS. CLEANING OR

NUMBER OF SPACERS PER

MANUFACTURER'S SPECIFICATIONS

WATER MAIN

REPLACEMENT SHALL BE PERFORMED AS NEEDED. MAINTAIN SILT SACKS UNTIL UPSTREAM AREAS HAVE BEEN PERMANENTLY STABILIZED.

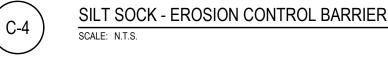

PROTECTED AREA, WORK AREA

SOCK

Section View

SILT SOCK

Plan View

2. COMPOST FOR SILT SOCK FILL MATERIAL TO BE PROVIDED BY THE MANUFACTURER IN CONJUNCTION WITH THE ENGINEER TO PROVIDE THE REQUIRED REMOVAL OF SEDIMENT OR OTHER POLLUTANTS FROM RUNOFF.

3. COMPOST MATERIAL SHALL BE DISPERSED ON SITE, AS DETERMINED BY THE LOCAL CONSERVATION AGENT

4. SILT SOCK SHALL BE INSPECTED AT LEAST ONCE EVERY SEVEN DAYS OR PER LOCAL AND STATE

5. METHOD OF INSTALLATION SHALL BE AS PER MANUFACTURER'S RECOMMENDATIONS.

REQUIREMENTS. REPAIR OR REPLACEMENT SHALL BE PERFORMED PROMPTLY, AS NEEDED.

1. ANCHOR TO BE A 2" X 2" X 36" HARD WOOD STAKE, OR APPROVED EQUAL.

DIRECTION OF FLOW

ANCHOR

(SEE NOTE 1)

STAKING DEPTH

LOOSE COMPOST

ANCHOR

CONSTRUCTION NOTES


-LOOSE COMPOST

SEDIMENT CONTROL

2:1 MAXIMUM GRADE

-PROTECTED

AREA

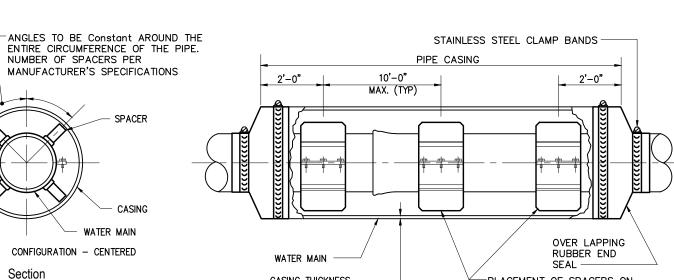


STEEL PIPE CASING SHALL CONFORM TO THE REQUIREMENTS OF ASTM A283, GRADE B, C OR D. ALL JOINTS SHALL BE WELDED. INTERIOR JOINTS SHALL BE GROUND TO A SMOOTH FINISH. ALL WELDING SHALL BE PERFORMED IN ACCORDANCE WITH AWWA C206, "AWWA STANDARD FOR FIELD WELDING OF STEEL WATER PIPE." COATINGS FOR STEEL CASING ARE NOT REQUIRED.

CONFIGURATION - CENTERED

Section

5. CASING TO BE FILLED (IF REQUIRED). SEE SPECIFICATIONS FOR FILL MATERIALS AND ADDITIONAL

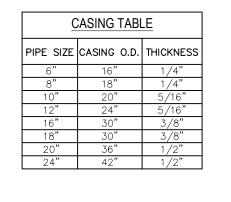

MANUFACTURER'S SPECIFICATIONS


CASING THICKNESS -PLACEMENT OF SPACERS ON WATER MAIN PER (SEE TABLE BELOW)


2. STEEL PIPE CASING SHALL BE INSTALLED SYMMETRICAL ABOUT WATER MAIN CENTERLINE (TYP). PIPE CASING


USE A "CENTERED" CONFIGURATION AND PROVIDE THE MANUFACTURER WITH THE FOLLOWING: (PIPE OD,

- SHALL BE LAID TRUE TO LINE AND GRADE WITH NO BENDS OR CHANGES IN GRADE FOR THE FULL LENGTH OF APPROVED CASING SPACERS AND END SEALS SHALL BE INSTALLED PER MANUFACTURER'S SPECIFICATIONS.
- CASING ID. AND CASING LENGTH). 4. ALL PIPE JOINTS WITHIN THE CASING ARE TO BE EXTERNALLY RESTRAINED.

REQUIREMENTS.
WATER SERVICE STEEL CASING INSTALLATION
SCALE: N.T.S.

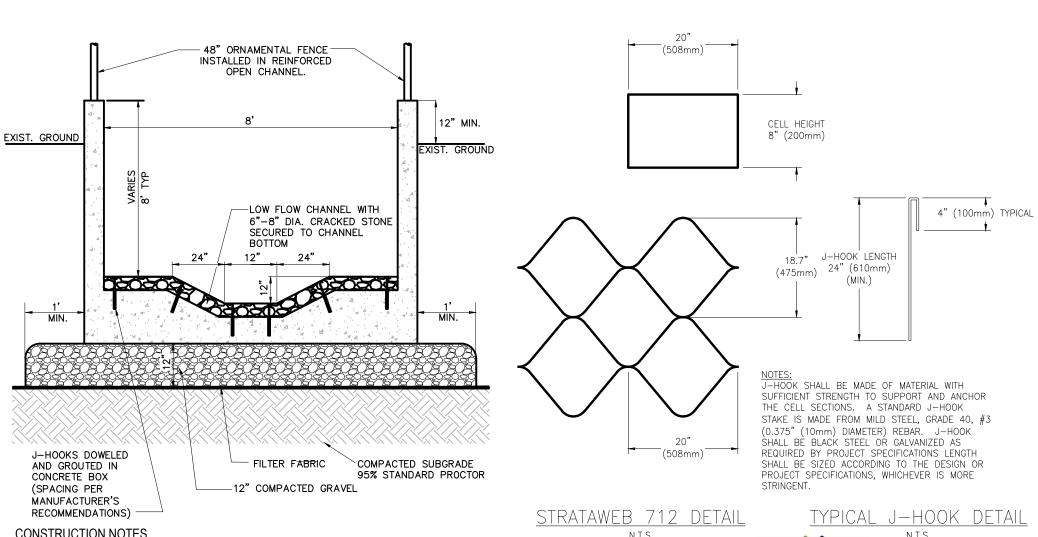

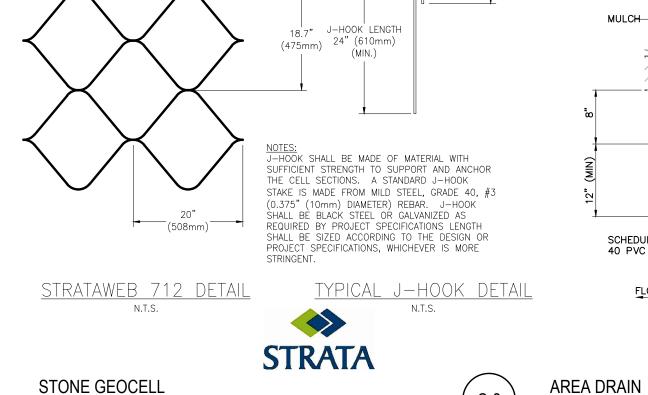


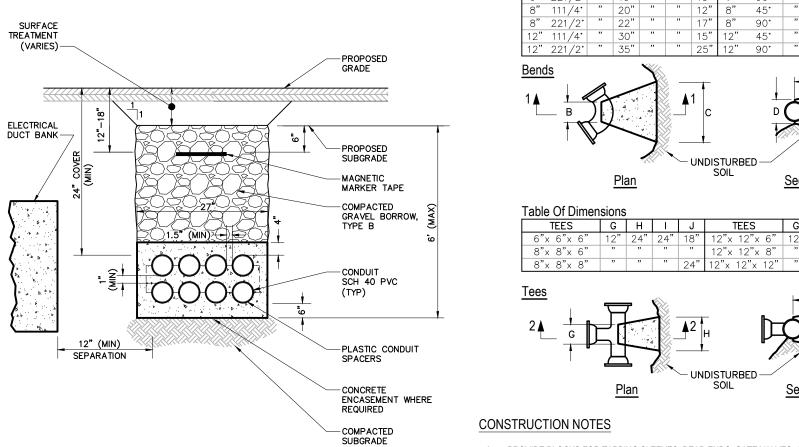

CONSTRUCTION NOTES


1. DETAIL SHOWN FOR TYPICAL UTILITY DUCTBANK CONFIGURATION. REFER TO PRIVATE UTILITY COMPANY DETAILS AND SPECIFICATIONS FOR INDIVIDUAL DUCTBANK DETAILS.

TYPICAL TELEPHONE / CATV / FIRE ALARM DUCTBANK SCALE: N.T.S.

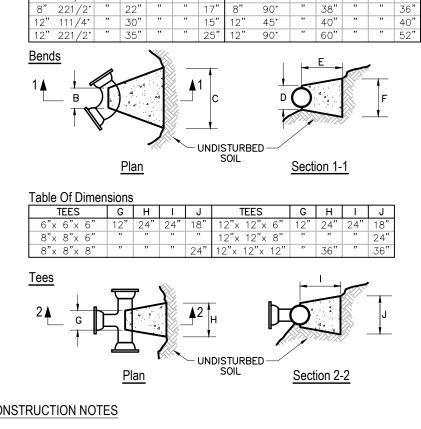

- 1. PROVIDE BLOCKS FOR TAPPING SLEEVES, DEAD ENDS, GATE VALVES, AND VERTICAL BENDS SAME SIZE AS REQUIRED FOR TEES. PROVIDE ANCHOR RODS AT VERTICAL BENDS AND GATE VALVES.
- 2. CONCRETE SHALL NOT BE PLACED AGAINST PIPE BEYOND FITTING.
- 3. CONCRETE SHALL BE 3000 PSI-TYPE I.

CONCRETE THRUST BLOCK SCALE: N.T.S.

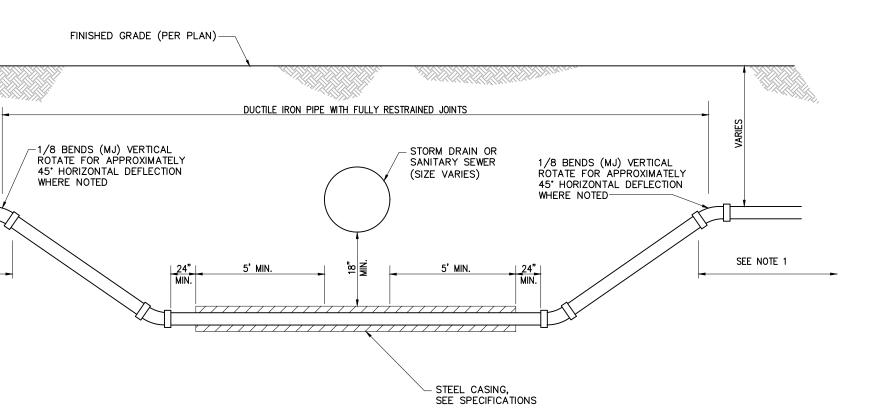


CONSTRUCTION NOTES

SEE NOTE 1


- 1. PROVIDE LENGTH OF RESTRAINED JOINTS PAST 1/8 BEND.
- 2. IDENTIFY TRANSITION FROM DUCTILE PIPE ON PLANS IF PIPE MATERIAL CHANGES.
- 3. SEE SPECIFICATIONS FOR TRENCH BACKFILL REQUIREMENTS

WATER MAIN CROSSING BENEATH STORM DRAIN OR SEWER SCALE: N.T.S.

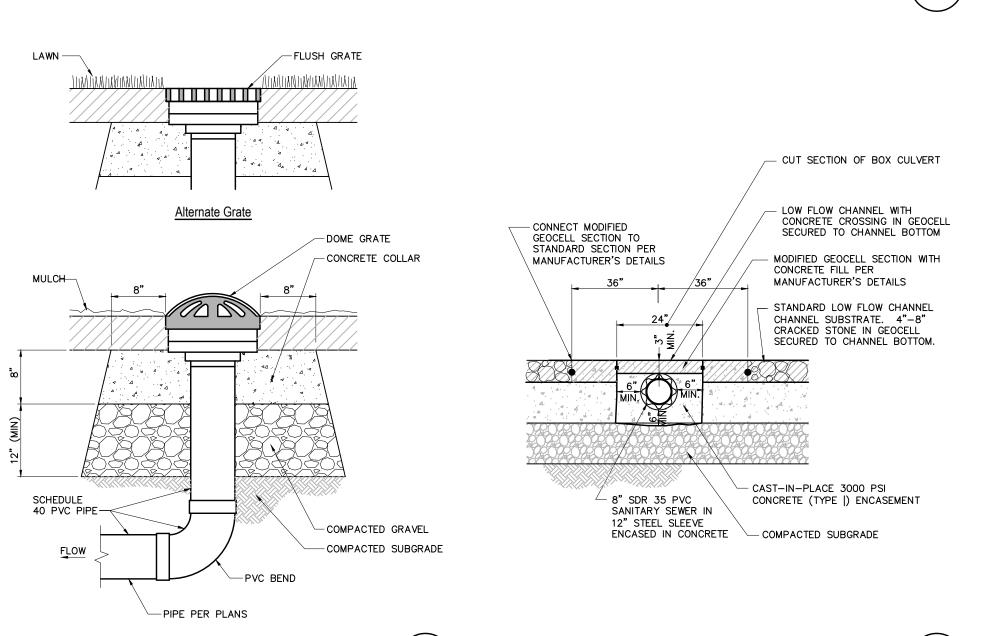

environmental | engineering | due diligence

1400 Hancock Street, 4th Floor Quincy, MA 02169 Tel: 617.481.5985 www.ebiconsulting.com

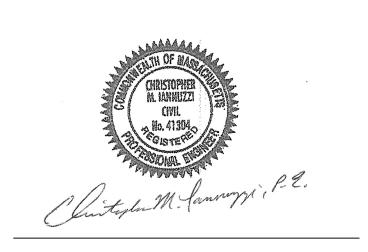

PREPARED FOR: Town of Weymouth

C-5

75 Middle Street Weymouth, MA 021789 Tel: (781) 335-2000 Fax: (781) 335-3283

THIS DOCUMENT IS THE DESIGN PROPERTY AND COPYRIGHT O EBI CONSULTING, INC. AND FOR THE EXCLUSIVE USE BY THE TITL CLIENT. ANY DUPLICATION OR USE WITHOUT EXPRESS WRITTEN CONSENT OF THE CREATOR IS STRICTLY PROHIBITED.

DRAWING SCALES NOTED ARE FOR 22" x 34" SIZE PRINTED MEDIA ONLY. ALL OTHER PRINTED SIZES ARE DEEMED "NOT TO SCALE".

SUBMITTALS				
NO.	DATE	DESCRIPTION	BY	
1	7/26/2017	AGENCY COMMENTS	JLS	

DATE: May 18, 2017

PROJECT TITLE:

1616000008

PROJECT NUMBER:

Smelt Brook Daylighting

Weymouth Landing Weymouth, Massachusetts 02188 Norfolk County

ISSUED FOR: Notice of Intent (NOT FOR CONSTRUCTION)

SHEET TITLE:

Site Details 2

SCALE: SHEET NO: N.T.S. **DESIGNED BY:** CHECKED BY:



1. ALL UNSUITABLE MATERIALS ENCOUNTERED DURING EXCAVATION ARE TO BE REMOVED.

AND GROUTED IN

MANUFACTURER'S

RECOMMENDATIONS) -


CONSTRUCTION NOTES

CONCRETE BOX

(SPACING PER


2. REFER TO MANUFACTURER'S DRAWINGS AND SPECIFICATIONS FOR STRUCTURAL DESIGN OF CULVERT.


- FILTER FABRIC

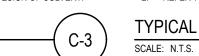



TYPICAL OPEN CHANNEL CROSS SECTION

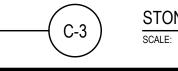

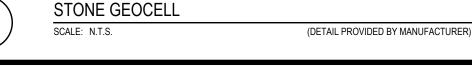

SCALE: N.T.S.

SCALE: N.T.S.

SANITARY SEWER CULVERT CROSSING

CMI 10 OF 10