
DEFINITIVE SUBDIVISION PLAN




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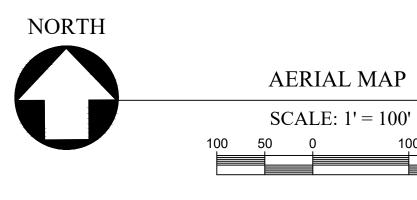
WEATHERVANE MASSAPOAG, LLC.

MASSAPOAG STREET, WEYMOUTH, MA

0 MASSAPOAG (SOUTH), ASSESSOR'S REF: 44-505-1 0 MASSAPOAG (NORTH), ASSESSOR'S REF: 44-505-2 68 MASSAPOAG, ASSESSORS REF: 44-504-8

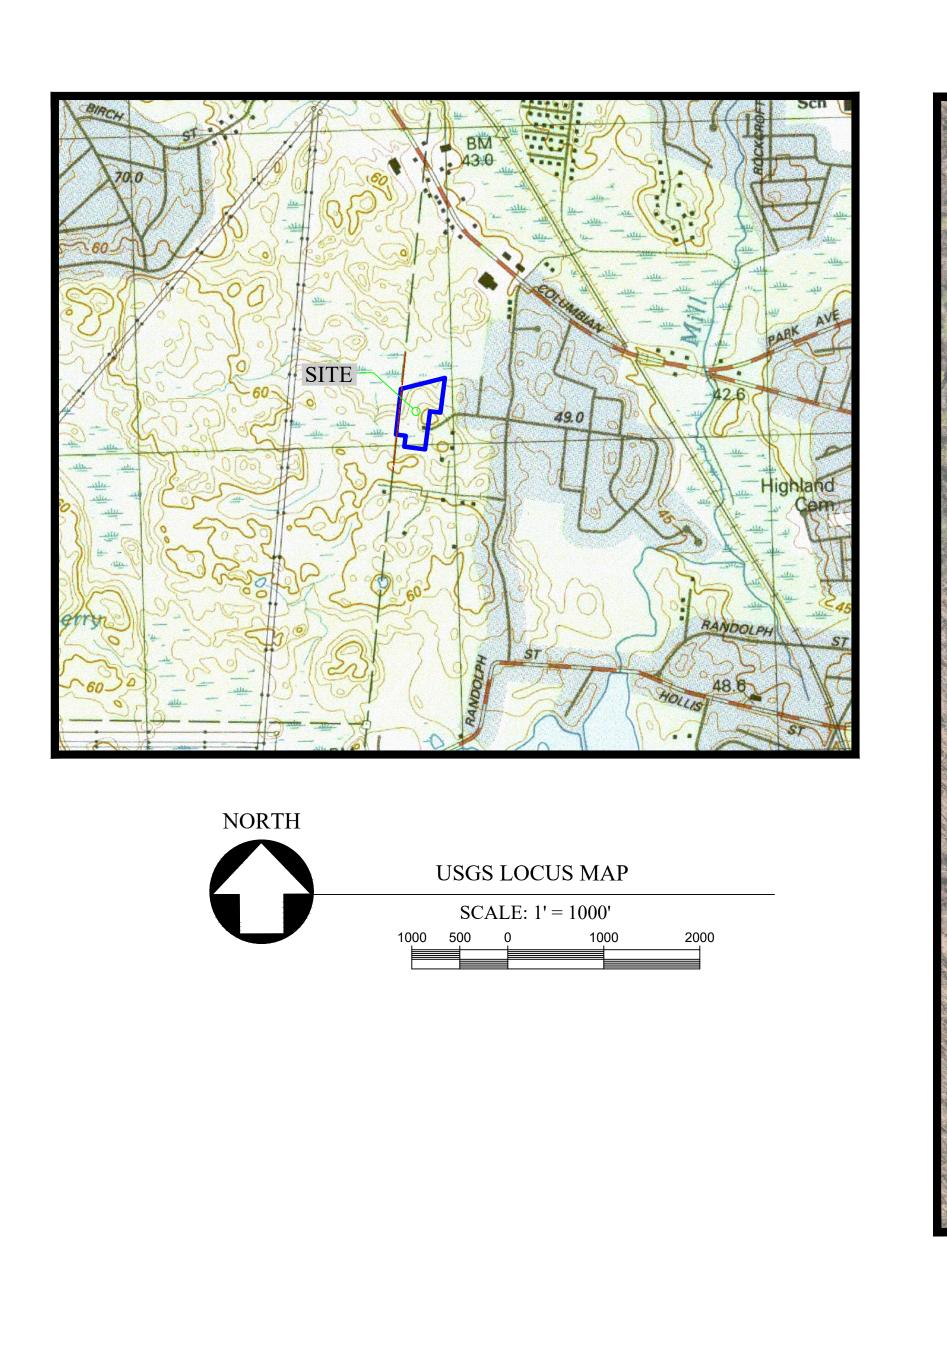

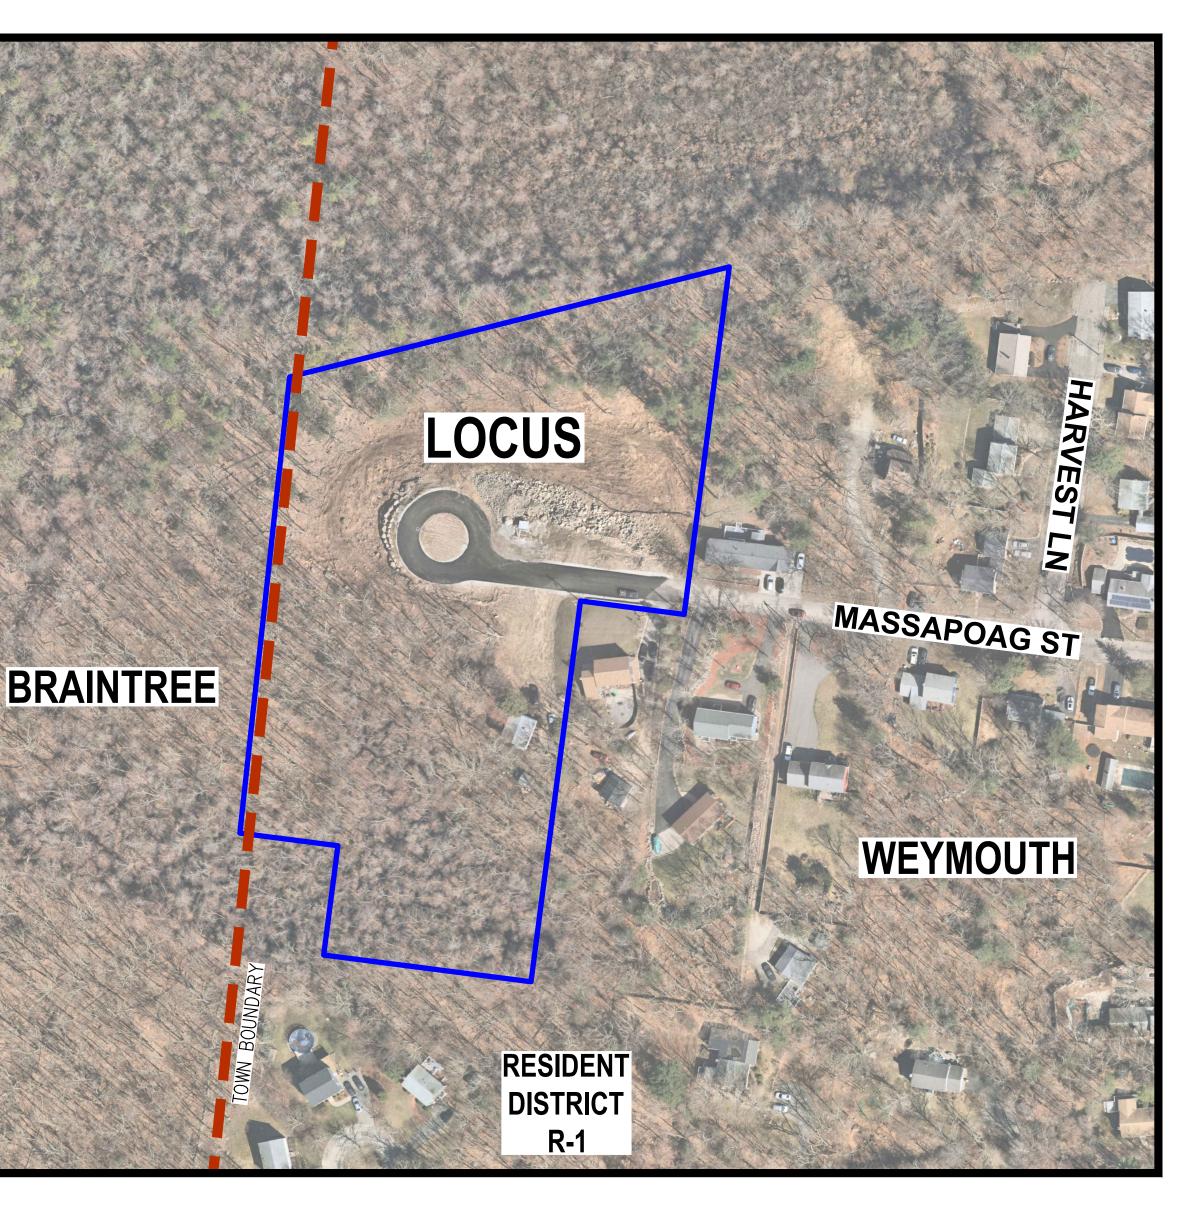200





	APPROVAL UNDER THE SUBDIVISION CONTROL LAW WEYMOUTH PLANNING BOARD
_ <u>D</u> A	NTE:
	PLANNING BOARD ENDORSEMENT DOES NOT IMPLY CONFORMANCE WITH TOWN OF WEYMOUTH ZONING BY-LAW.

FOR REGISTRY USE ONLY

DRAWING INDEX:

C-1 C-2	COVER SHEET LOTTING PLAN
C-3	SITE PLAN
C-4	GRADING AND DRAINAGE PLAN
C-5	UTILITIES PLAN
C-6	SOIL EROSION AND SEDIMENT CONTROL PLAN
C-7	ROADWAY PLAN AND PROFILE
C-8.1	DETAIL SHEET (1 OF 2)
C-8.2	DETAIL SHEET (2 OF 2)
TP-1	TEST PIT PLAN

SUPPLEMENTAL PLANS:

PLAN OF LAND 0 MASSAPOAG STREET (SHEET 1& 2) (PREPARED BY HOYT LAND SURVEYING)

OWNER/APPLICANT:

WEATHERVANE MASSAPOAG, LLC. 190 OLD DERBY STREET, SUITE 311 HINGHAM, MA 02043


SURVEYOR


(FOR THE EXISTING CONDITION PLAN)

HOYT LAND SURVEYING **1287 WASHINGTON STREET** WEYMOUTH, MA 02189 781-682-9142

ENGINEER/ SURVEYOR:

CROCKER DESIGN GROUP, LLC. 2 SHARP STREET, UNIT B HINGHAM, MA 02043 781-820-0416

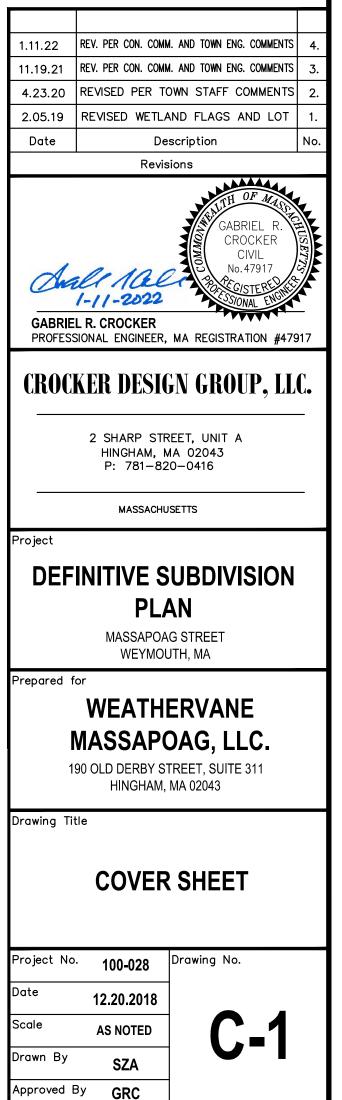

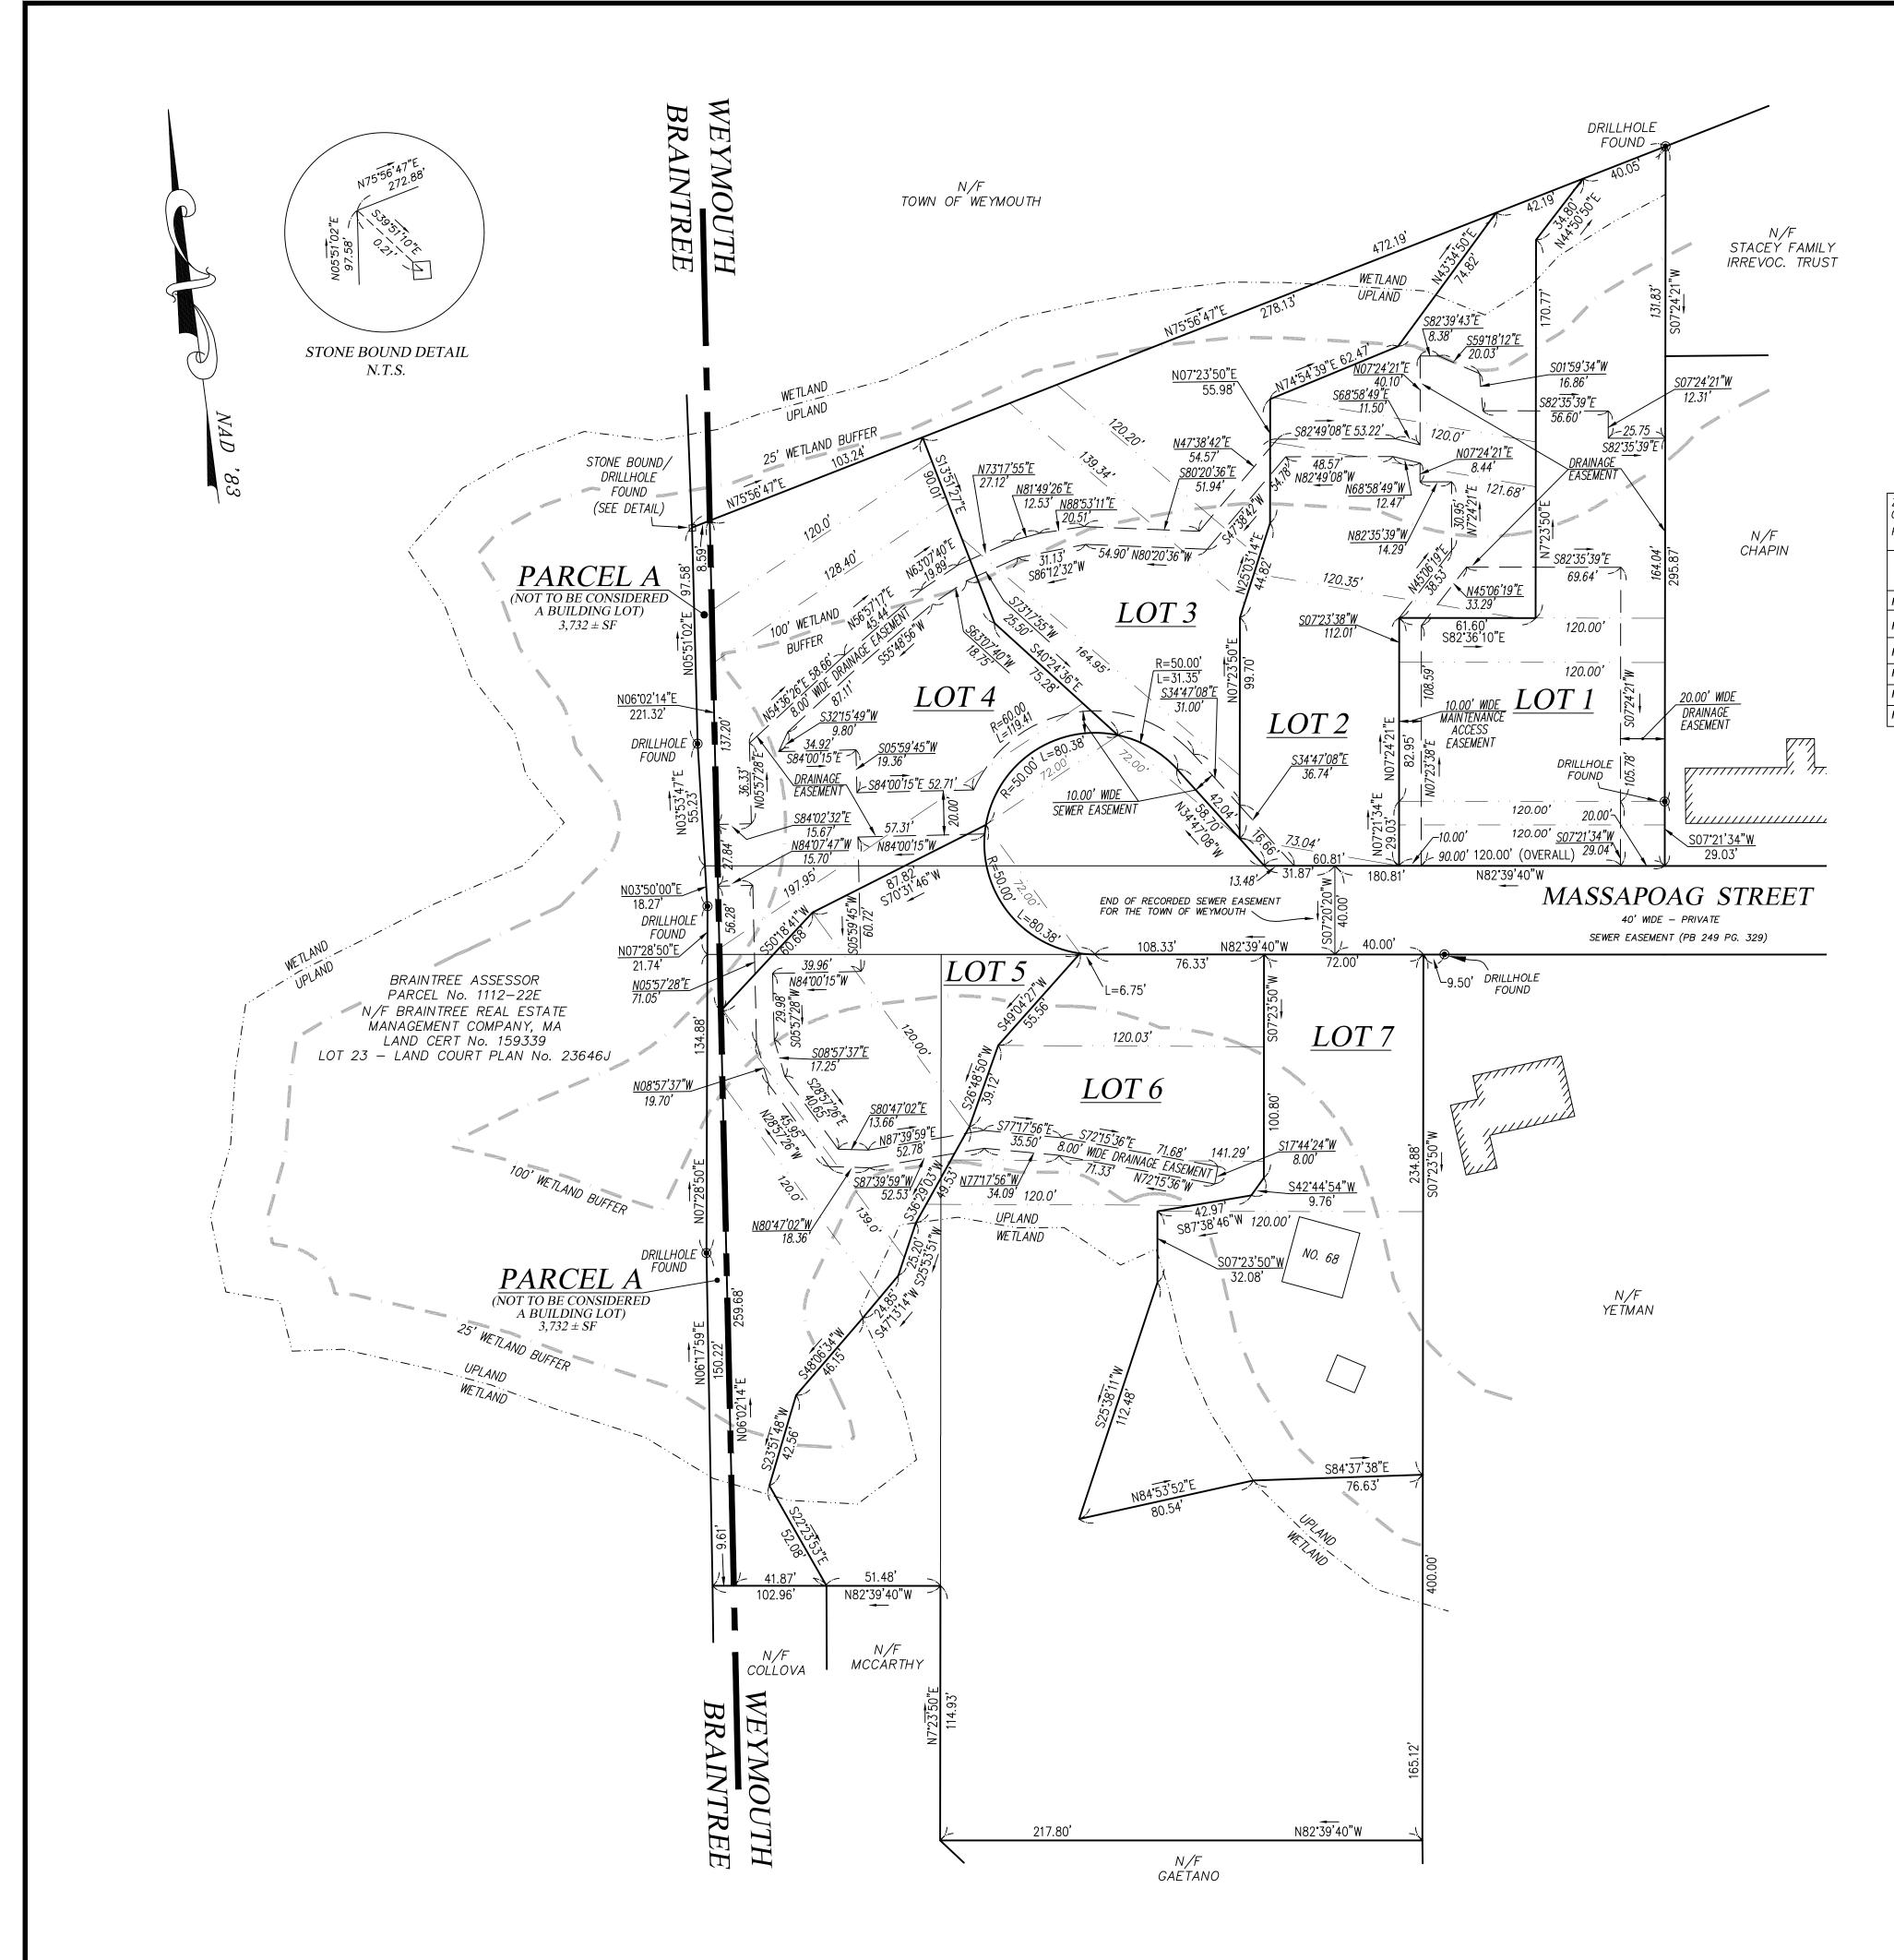

APPROVAL UNDER THE SUBDIVISION CONTROL LAW WEYMOUTH PLANNING BOARD

DATE

PLANNING BOARD ENDORSEMENT DOES NOT IMPLY CONFORMANCE WITH TOWN OF WEYMOUTH ZONING BY-LAW. ZONING TABLE ZONING DISTRICT: RESIDENT DISTRICT R-1 OVERLAY DISTRICT: WATERSHED PROTECTION DISTRICT PROPOSED USE: ONE FAMILY RESIDENTIAL HOUSES REQUIREMENT MINIMUM LOT AREA (SF) 85% OF MINIMUM UPLAND AREA 85% X SQUARE L MAX LOT SHAPE FACTOR*

MINIMUM LOT WIDTH (FT) MINIMUM LOT FRONT LINE (FT)** MIN. LOT MEASURMENT ACCROSS FRONT YARD*** 60% OF

* 120-53.2. NO LOT SHALL BE CREATED SO AS TO BE SO IRREGULARLY SHAPED OR EXTENDED THAT IT HAS A "SHAPE FACTOR" IN EXCESS OF 30. "SHAPE FACTOR" EQUALS THE SQUARE OF THE LOT PERIMETER DIVIDED BY THE LOT AREA.

** 120-56. FRONT LOT LINE, FRONTAGE AND FRONTAGE WIDTH. (A.) EACH LOT SHALL HAVE A FRONT LOT LINE, AS SAID TERM IS DEFINED IN ~ 120-6, OF NOT LESS THAN 40 FEET, UNLESS STATED OTHERWISE IN TABLE 1, SCHEDULE OF DISTRICT REGULATIONS, AT THE END OF THIS CHAPTER. [AMENDED MAY 1990 STM BY ART. 1, APPROVED 8-29-1990] (C.) EACH LOT SHALL HAVE FRONTAGE AND FRONTAGE WIDTH, AS SAID TERMS ARE DEFINED IN § 120-6, OF NO LESS THAN 40 FEET, UNLESS STATED OTHERWISE IN TABLE 1, SCHEDULE OF DISTRICT REGULATIONS, INCLUDED AS AN ATTACHMENT TO THIS CHAPTER.

*** 120-59.1. MEASUREMENTS ACROSS LOTS. [ADDED FEBRUARY 1985 STM BY ART. 7, APPROVED 6-3-1985; AMENDED MAY 1997 ATM BY ART. 42, APPROVED 8-11-1997] IF ANY LOT IN EXISTENCE AS OF FEBRUARY 25, 1985, IS TO BE SUBDIVIDED INTO THREE OR MORE LOTS OR IF ANY LOT SUBSEQUENTLY CREATED IS TO BE SUBDIVIDED, THEN EACH SUBDIVIDED LOT SHALL HAVE A MINIMUM LOT MEASUREMENT ACROSS THE FRONT YARD FROM SIDE LOT LINE TO SIDE LOT LINE AT ANY POINT FROM THE LOT LINE TO THE MINIMUM LOT WIDTH LINE AT THE FRONT LINE OF THE BUILDING SHALL NOT BE LESS THAN 60% OF THE MINIMUM REQUIRED LOT WIDTH, AND NO PORTION OF A PRINCIPAL BUILDING SHALL BE ERECTED ON ANY PORTION OF A LOT WHICH IS LESS THAN THE REQUIRED LOT WIDTH AS SET FORTH IN THESE BYLAWS. SAID MINIMUM REQUIRED LOT WIDTH SHALL EXTEND AN ADDITIONAL 20 FEET BEYOND THE REAR PORTION OF THE PRINCIPAL BUILDING

LOT WIDTH DEFINITION: CORNERS, MEASURED BETWEEN THE SIDE LOT LINES AT THE BUILDING LINE.

I CERTIFY:

1. THIS PLAN IS THE RESULT OF AN ACTUAL ON THE GROUND SURVEY.

2. THAT THIS PLAN WAS PREPARED IN CONFORMANCE WITH THE RULES AND REGULATIONS OF THE REGISTERS OF DEEDS.



SHANE M. BRENNER, P.L.S.



IAY F TOMMY MARKS RD. LOCUS , KING PHILIP MASSAPOAG S AMOSET BR 1"=800' LOCUS MAP

FOR REGISTRY USE ONLY

REQUIRED	PROPOSED LOT 1	PROPOSED LOT 2	PROPOSED LOT 3	PROPOSED LOT 4	PROPOSED LOT 5	PROPOSED LOT 6	PROPOSED LOT 7
25,000 SF	25,001 SF	25,001 SF	25,001 SF	25,001 SF	25,052 SF	68,032 SF	25,001 SF
F MIN REQ. LOT AREA X 25,000=21,250 SF	23,624 SF	23,414 SF	23,952 SF	25,001	23,439 SF	21,253 SF	21,250 SF
LOT PERIM/ LOT AREA =MAX 30	29.87	27.99	29.21	20.66	29.90	29.75	23.23
120 FT	120.00'	GREATER THAN 120.00'	GREATER THAN 120.00'	GREATER THAN 120.00'	GREATER THAN 120.00'	GREATER THAN 120.00'	120.00'
40 FT	120.00'	77.47'	73.39'	80.38'	80.38'	83.08'	72.00'
F LOT WIDTH=72 FT*	120.00'	73.04'	72.00'	72.00'	72.00'	83.06'	72.00'

THE HORIZONTAL DISTANCE PARALLEL TO THE FRONT LOT LINE OR, IN THE CASE OF A CURVED OR IRREGULAR LOT LINE, A LINE PARALLEL TO A STRAIGHT LINE DRAWN BETWEEN THE FRONT LOT

LOCUS INFORMATION CURRENT OWNER: 0 MASSAPOAG (SOUTH) ASSESSOR'S REF: 44-505-1

JAMES E. BRISTOL III 114 SANDTRAP CIRCLE WEYMOUTH, MA

LEGAL REF: BOOK 35830 PAGE 295

PLAN REF: PLAN BOOK 406 PAGE 323

CURRENT OWNER: 68 MASSAPOAG ASSESSORS REF: 44-504-8 0 MASSAPOAG (NORTH) ASSESSOR'S REF: 44–505–2

WEATHERVANE MASSAPOAG LLC 190 DERBY STREET, SUITE 311, HINGHAM, MA, 02043

LEGAL REF: DEED BOOK 36686 PAGE 426 PLAN REF: LCP 36658A

ZONE: R-1

WATERSHED PROTECTION DISTRICT

FEMA REFERENCE: ZONE X FIRM 25021C0236E DATED 7-17-12

HORIZONTAL DATUM: NAD '83

2-05-19 REVISED WETLAND FLAGS AND LOT 10-08-21 CALCULATIONS 1-13-22 REV. PER CON. COMM. AND TOWN ENG. COMMENTS Date Description Revisions

CROCKER DESIGN GROUP, LLC

2 SHARP STREET, UNIT B HINGHAM, MA 02043 P: 781-820-0416 MASSACHUSETTS

Project

DEFINITIVE SUBDIVISION PLAN

MASSAPOAG STREET WEYMOUTH, MA

Prepared for **BRISTOL BROS. DEVELOPMENT CORP.** 190 OLD DERBY STREET, SUITE 311 HINGHAM, MA 02043

Drawing Title

LOTTING PLAN


100-028 Drawing No. Project No. 12.20.2018

Scale 1"=40' Drawn By AS Approved By SMB

C-2

40	20	0	

GRAPHIC SCALE FEET

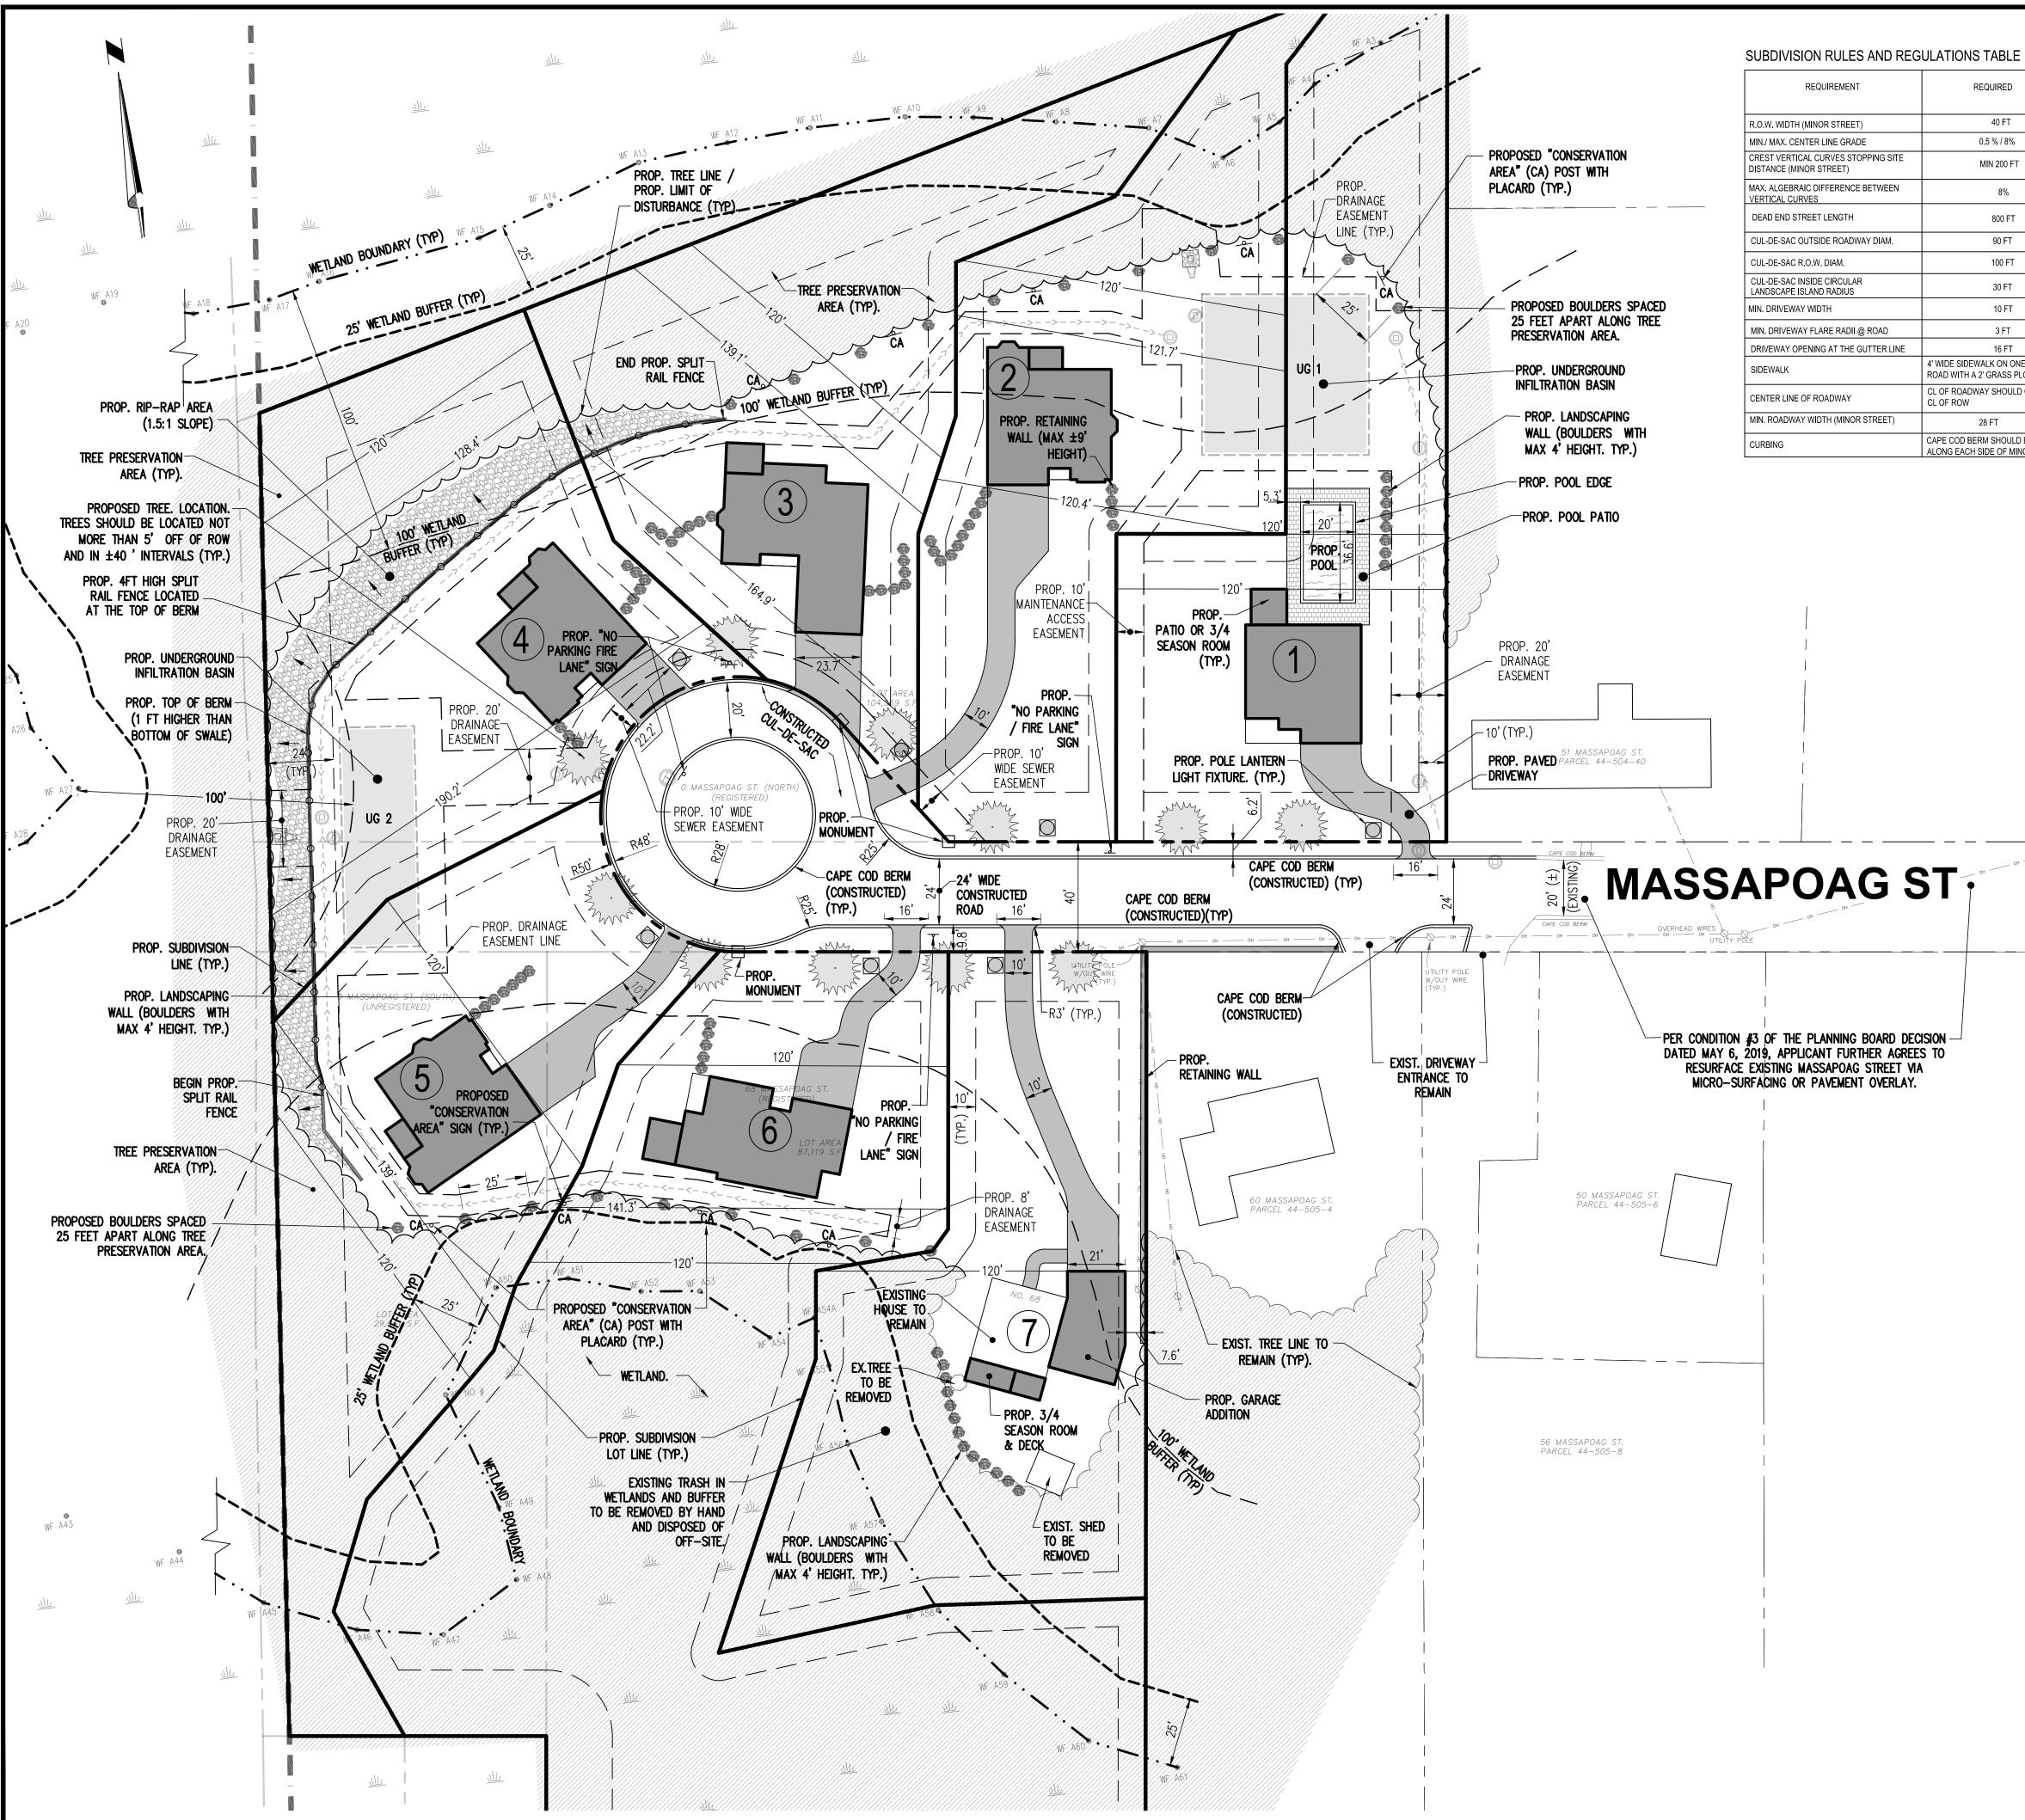

REQUIRED	PROPOSED	WAIVER REQUIRED (YES / NO)
40 FT	40 FT	NO
0.5 % / 8%	1.99 % / 5.90%	NO
MIN 200 FT	200 FT	NO
8%	7.96%	NO
800 FT	680 FT (±) (HARVEST LN.) 980 FT (±) (FOREST ST.)	YES (GRANTED ON 5.06.19)
90 FT	96 FT	NO
100 FT	100 FT	NO
30 FT	28 FT	YES (GRANTED ON 5.06.19)
10 FT	10 FT	NO
3 FT	3 FT	NO
16 FT	16 FT	NO
E SIDEWALK ON ONE SIDE OF THE WITH A 2' GRASS PLOT	NO SIDEWALK PROVIDED	YES (GRANTED ON 5.06.19)
ROADWAY SHOULD COINCIDE WITH ROW	CL OF ROADWAY DOESN'T COINCIDE WITH CL OF ROW	YES (GRANTED ON 5.06.19)
28 FT	24 FT	YES (GRANTED ON 5.06.19)
COD BERM SHOULD BE PROVIDED G EACH SIDE OF MINOR STREET	CCB PROVIDED ALONG EACH SIDE OF STREET	NO


UTILITY POLE OH OH

ZONING BY-LAW.

	30 1	5 0	30	60			
-							
	1.11.22	REV. PER CON. COMM	I. AND TOWN ENG. COMMENTS	4.			
	11.19.21	REV. PER CON. COMM	I. AND TOWN ENG. COMMENTS	3.			
	4.23.20	REVISED PER TO	WN STAFF COMMENTS	2.			
	2.05.19	REVISED WETLA	ND FLAGS AND LOT	1.			
	Date	De	scription	No.			
		Revis	ions				
	GABRIEL R. CROCKER PROFESSIONAL ENGINEER, MA REGISTRATION #						
	CROC	KER DESIG	SN GROUP, LL	C.			
		2 SHARP STR HINGHAM, M P: 781-82	IA 02043				
		MASSACHU	SETTS	_			
	Project DEF	INITIVE S PL <i>I</i>	UBDIVISION				
		MASSAPOA WEYMOL					
	Prepared f	WEATH	ERVANE DAG, LLC.				
APPROVAL UNDER THE SUBDIVISION CONTROL LAW WEYMOUTH PLANNING BOARD	19	90 OLD DERBY ST HINGHAM,	REET, SUITE 311				
DATE:	Drawing Tit						
	SITE PLAN						
	Project No	100-028	Drawing No.				
	Date	12.20.2018					
	Scale	1"=30'	C-3				
PLANNING BOARD ENDORSEMENT DOES NOT IMPLY CONFORMANCE WITH TOWN OF WEYMOUTH	Drawn By	SZA	U-J				


Approved By GRC

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FIELD AND REPORT ANY DISCREPANCIES IMMEDIATELY TO THE OWNER OR HIS REPRESENTATIVE.	
IG UTILITY LINES SHALL BE DONE BY HAND. CONTRACTOR SHALL REPAIR ANY DAMAGE TO EXISTING UTILITY LINES OR S AT NO COST TO THE OWNER.	
S TO DRAIN. ALL PAVED AREAS MUST PITCH TO DRAIN AT A MINIMUM OF 1/8" PER FOOT UNLESS OTHERWISE SPECIFIED. ANY 3E REPORTED TO THE OWNER OR HIS REPRESENTATIVE PRIOR TO CONTINUING WORK.	
MENTS AND SHALL COMPLY WITH APPLICABLE CODES AND REGULATIONS, AND THE STORMWATER POLLUTION PREVENTION	
MAY BE REQUIRED TO EXCAVATE ADDITIONAL TEST PITS FOR THE PURPOSE OF LOCATING UNDERGROUND UTILITIES OR TION OF NEW WORK. THIS WORK IS TO BE PERFORMED AT NO ADDITIONAL COST TO THE OWNER. TEST PITS SHALL BE EN OBTAINED.	
S AND OTHER FACILITIES FROM DAMAGE CAUSED BY SETTLEMENT, LATERAL MOVEMENT, UNDERMINING, WASHOUT AND	
GETATED AREAS WITHIN THE PROPOSED LIMITS OF WORK FOR EXCAVATION, GRADING, OR IMPROVEMENT SHALL BE CLEARED REMOVE ALL TREES, SHRUBS AND ROOTS UNLESS DESIGNATED OTHERWISE. CLEARING SHALL INCLUDE THE FELLING, JMPS AND VEGETATIVE DEBRIS PRODUCED THROUGH THE CLEARING OPERATIONS.	FOR REGISTRY USE ONLY
AND GRUBBING OPERATIONS WITH SATISFACTORY SOIL MATERIAL UNLESS FURTHER EXCAVATION OR EARTHWORK IS	
SUBSURFACE OR GROUNDWATER FROM FLOWING INTO EXCAVATIONS OR EARTHWORK AREAS WHICH WOULD CAUSE R SOFTENING OR LOOSENING OF THE SOIL AT EXCAVATION OR EARTHWORK SUB-GRADES.	
INTAIN AND REMOVE ADEQUATE AND SATISFACTORY DEWATERING SYSTEMS AND DRAINAGE OF EXCAVATIONS TO PERMIT R SHALL ASSUME ALL RESPONSIBILITY FOR THE ADEQUACY OF THE METHODS, MATERIALS AND EQUIPMENT EMPLOYED. THE NECESSARY DEWATERING.	
TER FLOW OR SURFACE INFILTRATION AND RUNOFF FROM UNDERMINING OR OTHERWISE DAMAGING ADJACENT	
YED BY HOSE TO AN UPLAND AREA AND DISCHARGED INTO HAYBALE CORRALS OR SEDIMENTATION BAGS.	
ON SHALL BE DONE ONLY AFTER EXCAVATION AND CONSTRUCTION WORK WHICH MIGHT INJURE THEM HAS BEEN COMPLETED. D BEFORE ACCEPTANCE.	
A MUDDY OR FROZEN SUBGRADE.	
ORMANCE TO REQUIRED GRADE TOLERANCES SHALL BE THE RESPONSIBILITY OF THE CONTRACTOR.	
AGE AND KEEP THEM FREE OF TRASH AND DEBRIS RESULTING FROM CONSTRUCTION OPERATIONS. REPAIR AND EAS.	
VHETHER ON THE SITE OR ADJACENT PROPERTIES, SHALL BE RESTORED AND MATCHED WITH EXACTLY THE SAME MATERIALS IAL COST TO THE OWNER, OR ADJACENT PROPERTY OWNERS.	
ASONABLY WELL GRADED, HARD, DURABLE, ANGULAR IN SHAPE, RESISTANT TO WEATHERING AND FREE FROM ORGANIC PTABLE. THE MINIMUM WEIGHT OF THE STONE SHALL BE 155 POUNDS PER CUBIC FOOT. STONE SHALL BE PLACED IN SHOWN ON THE DRAWINGS.	
NT ABUTS NEW CONSTRUCTION, THE EDGE OF THE EXISTING CURB OR PAVEMENT SHALL BE SAW CUT TO A CLEAN, SMOOTH OTHLY INTO EXISTING BY MATCHING LINES, GRADES AND JOINTS.	
ONFORM TO MASSACHUSETTS HIGHWAY DEPARTMENT STANDARDS.	

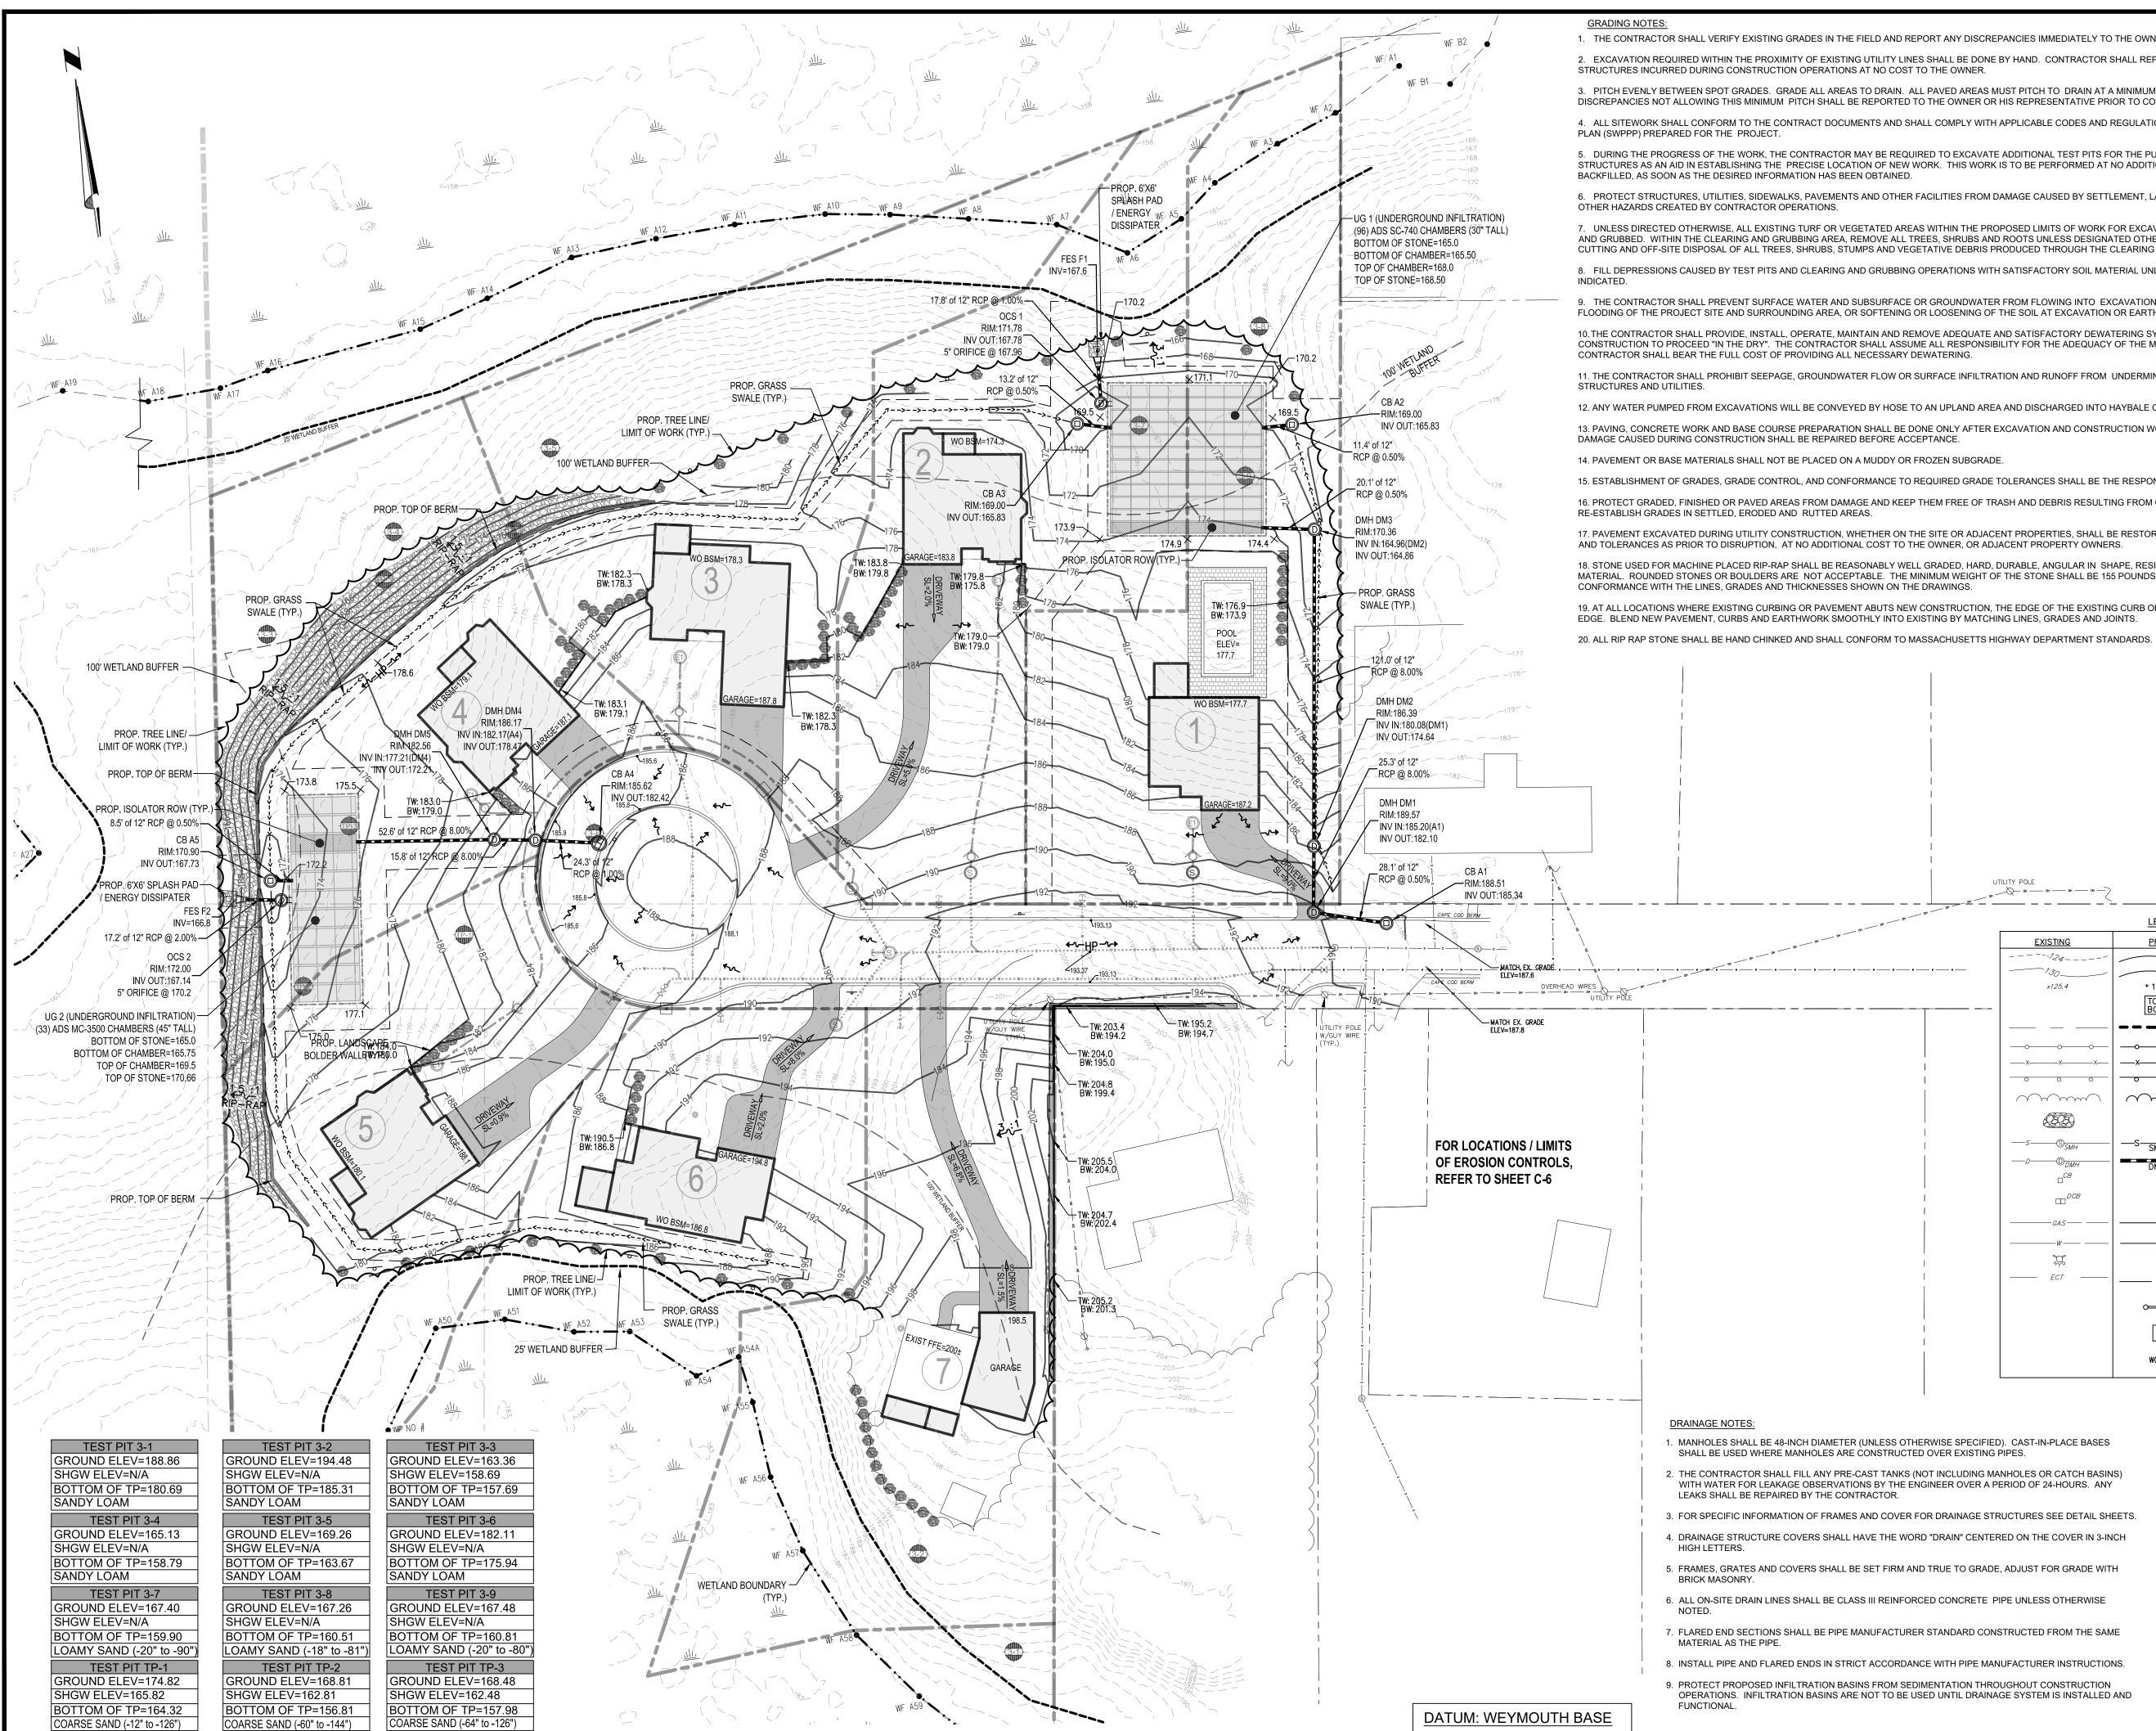JTILITY POL а <u>а страна страна страна страна</u> LEGEND: <u>EXISTING</u> PROPOSED DESCRIPTION MINOR CONTOUR _______ MAJOR CONTOUR 130 SPOT ELEVATION x125.4 + 130.50 TC131.50 BC131.00 TOP/BOTTOM OF CURB ELEVATION PROPERTY LINE (ROW) -----_____ POST AND RAIL FENCE _____O____O____O___ _____O____O____O CHAIN LINK FENCE ____X____X____X____ ____X____X____X_ GUARDRAIL/GUIDERAIL 0 0 0 0 0 \frown TREE LINE \sim RIPRAP 62626 —S—<u>-sмн</u>©— SEWER LINE/MANHOLE DRAIN LINE/MANHOLE CATCH BASIN DOUBLE CATCH BASIN GAS LINE/GATE —GAS— —— GAS —— WATER LINE/GATE —*W* —— HYDRANT , Ç Ø UNDERGROUND ELECTRIC, ECT ---- ECT \sim AREA LIGHT ELECTRICAL TRANSFORMER T WO BSM WALK OUT BASEMENT ELEVATION



30

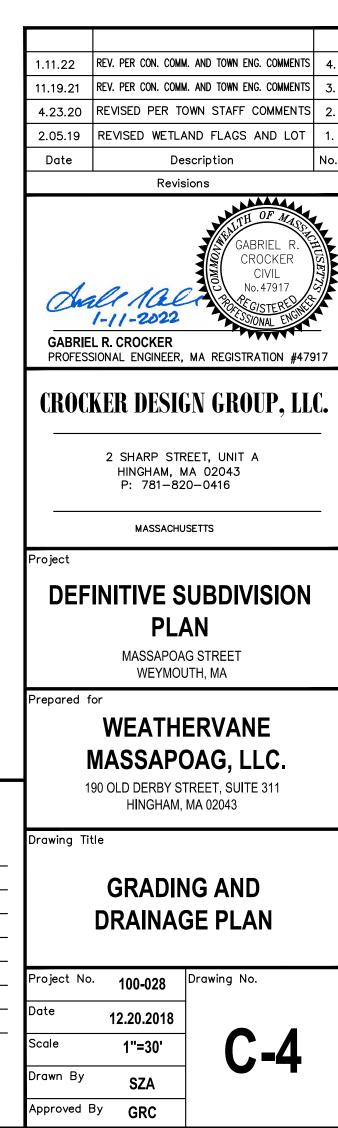15

1. MANHOLES SHALL BE 48-INCH DIAMETER (UNLESS OTHERWISE SPECIFIED). CAST-IN-PLACE BASES 2. THE CONTRACTOR SHALL FILL ANY PRE-CAST TANKS (NOT INCLUDING MANHOLES OR CATCH BASINS) WITH WATER FOR LEAKAGE OBSERVATIONS BY THE ENGINEER OVER A PERIOD OF 24-HOURS. ANY 3. FOR SPECIFIC INFORMATION OF FRAMES AND COVER FOR DRAINAGE STRUCTURES SEE DETAIL SHEETS. 4. DRAINAGE STRUCTURE COVERS SHALL HAVE THE WORD "DRAIN" CENTERED ON THE COVER IN 3-INCH 5. FRAMES, GRATES AND COVERS SHALL BE SET FIRM AND TRUE TO GRADE, ADJUST FOR GRADE WITH 6. ALL ON-SITE DRAIN LINES SHALL BE CLASS III REINFORCED CONCRETE PIPE UNLESS OTHERWISE

7. FLARED END SECTIONS SHALL BE PIPE MANUFACTURER STANDARD CONSTRUCTED FROM THE SAME


8. INSTALL PIPE AND FLARED ENDS IN STRICT ACCORDANCE WITH PIPE MANUFACTURER INSTRUCTIONS. 9. PROTECT PROPOSED INFILTRATION BASINS FROM SEDIMENTATION THROUGHOUT CONSTRUCTION OPERATIONS. INFILTRATION BASINS ARE NOT TO BE USED UNTIL DRAINAGE SYSTEM IS INSTALLED AND

PLANNING BOARD ENDORSEMENT DOES NOT IMPLY CONFORMANCE WITH TOWN OF WEYMOUTH ZONING BY-LAW.

APPROVAL UNDER THE

SUBDIVISION CONTROL LAW


WEYMOUTH PLANNING BOARD

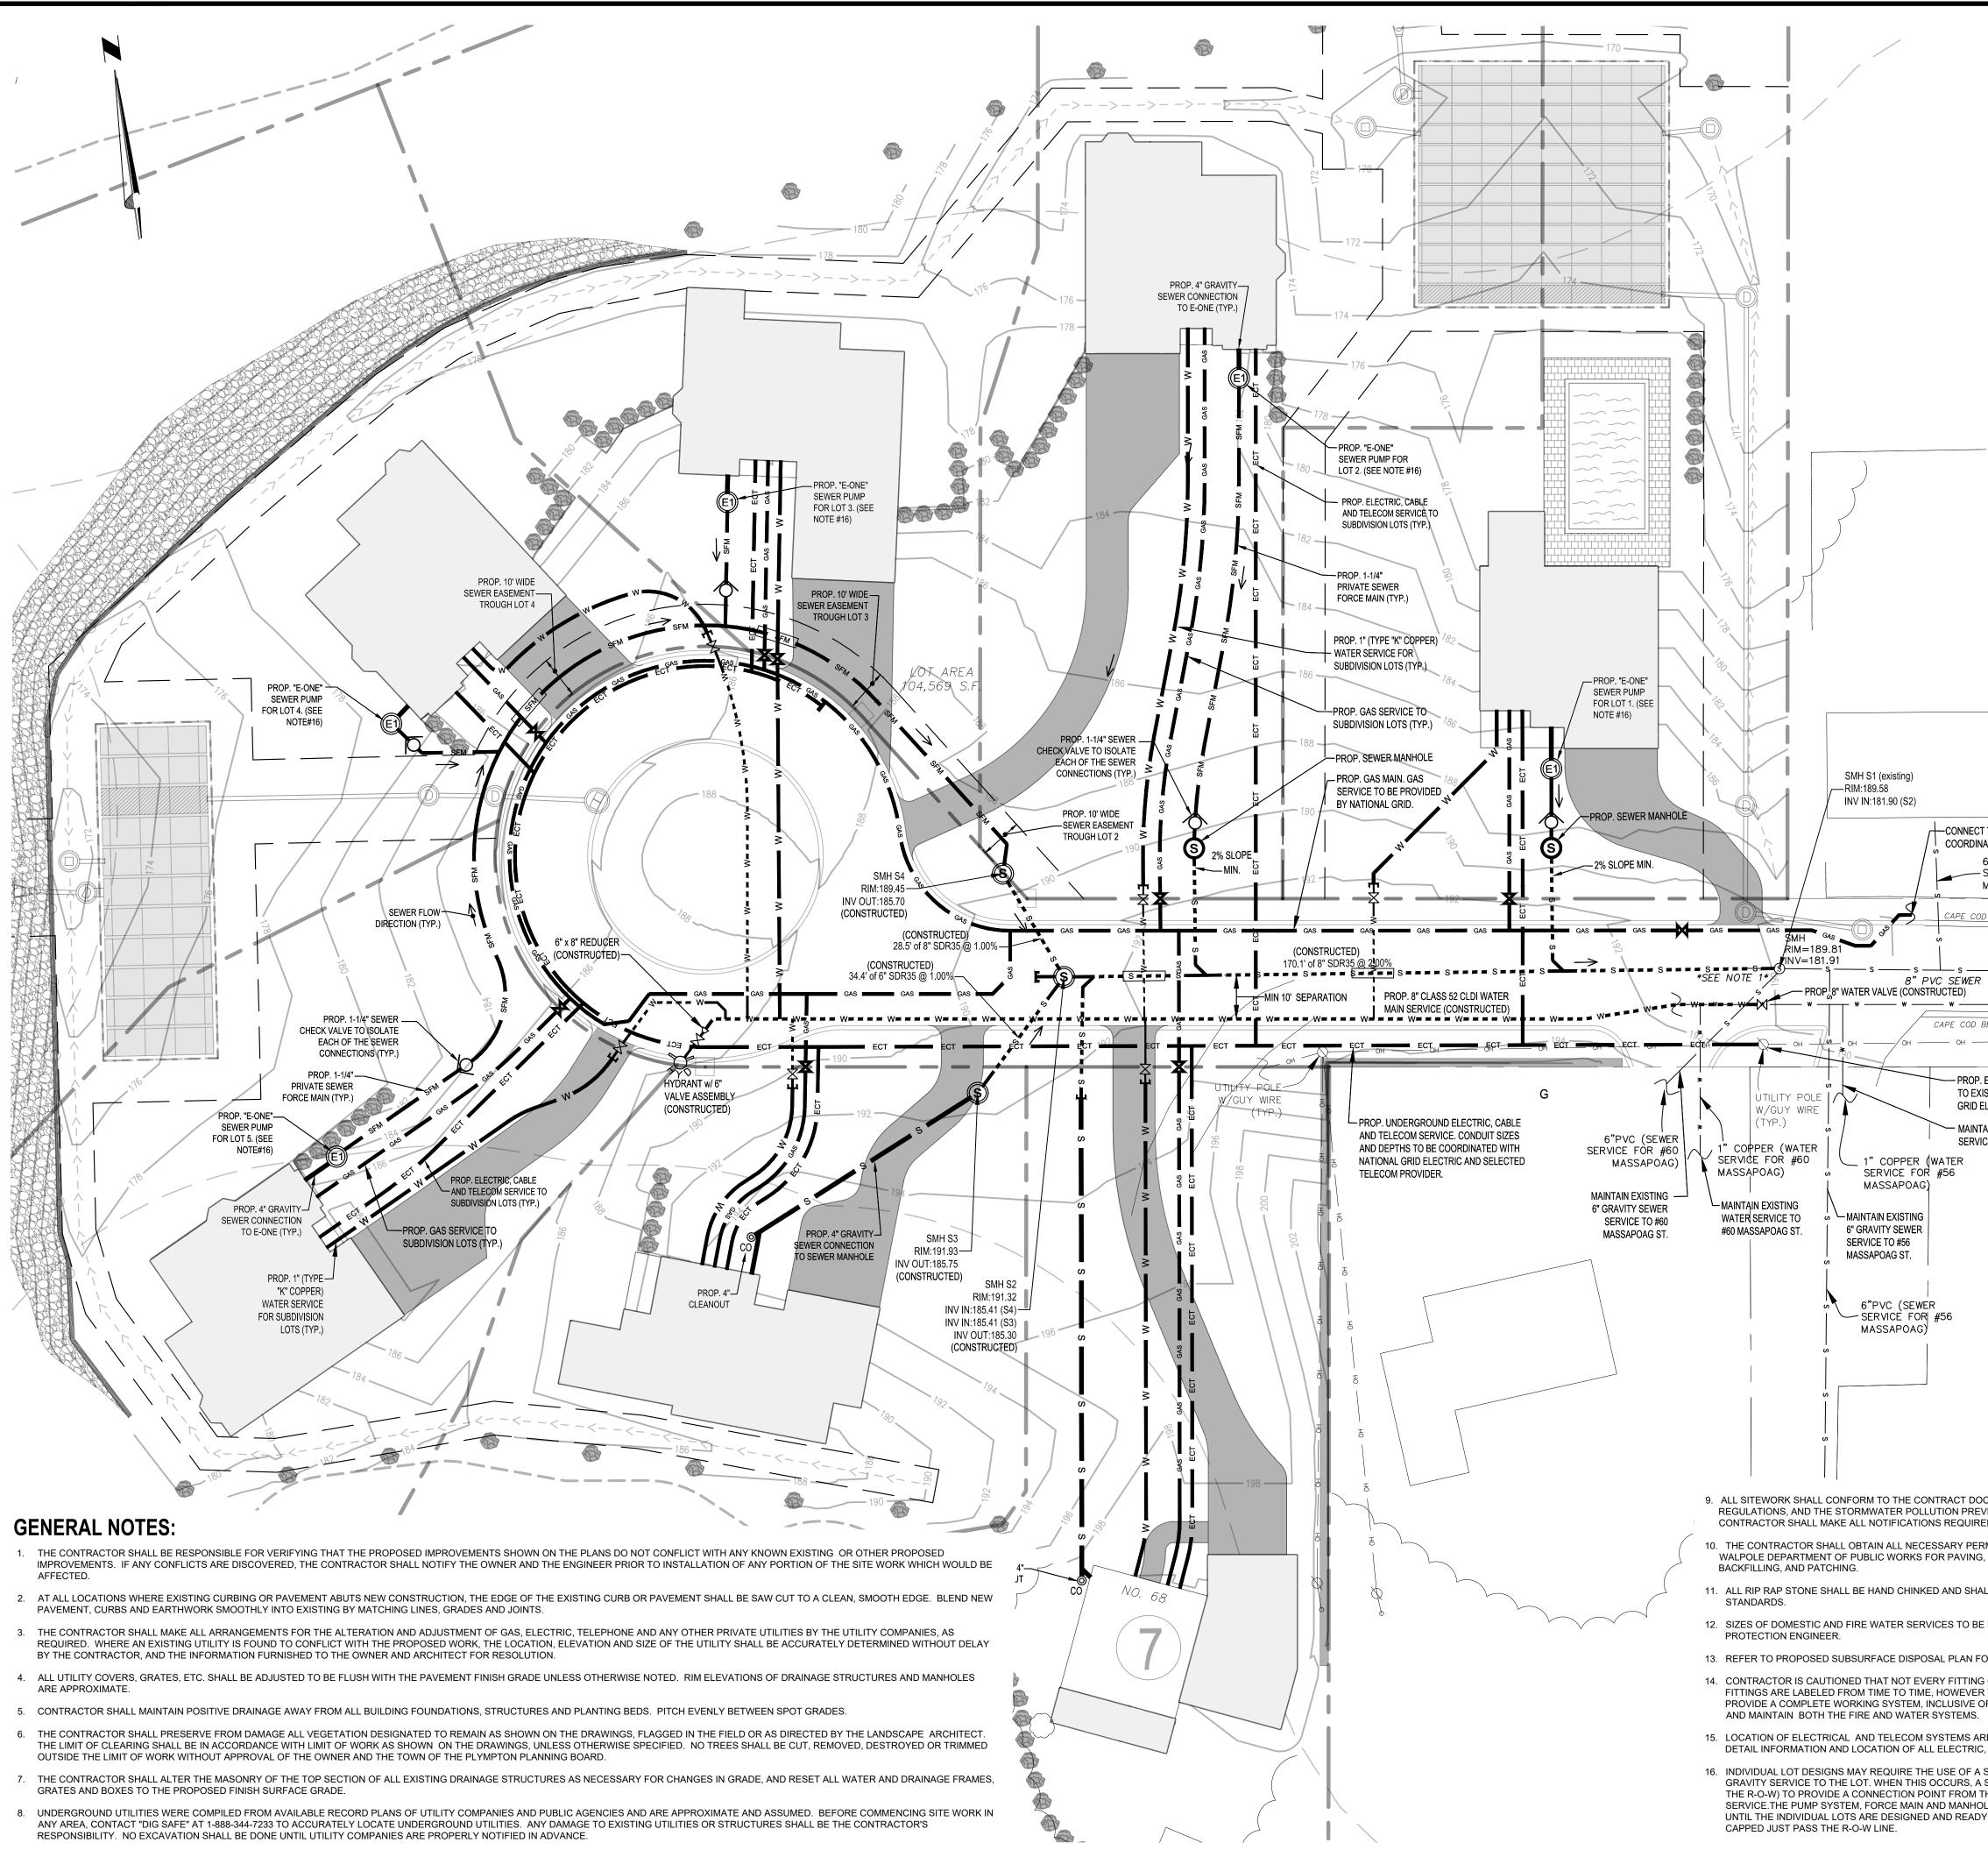


		LEGEND:				
-	EXISTING	PROPOSED	DESCRIPTION MINOR CONTOUR			
		124	MAJOR CONTOUR			
	×125.4	+ 130.50 TC131.50	SPOT ELEVATION TOP/BOTTOM_OF			
		BC131.00	CURB ELEVATION PROPERTY LINE (ROW)			
	oo	oo	POST AND RAIL FENCE			
	XXX 	<u> </u>	CHAIN LINK FENCE GUARDRAIL/GUIDERAIL			
			TREE LINE			
			RIPRAP		FOR REG	STRY USE ONLY
	S\$ 	S-SMHS DMH	SEWER LINE/MANHOLE DRAIN LINE/MANHOLE			
		© ^{CB}	CATCH BASIN			
		DCB	DOUBLE CATCH BASIN			
	GAS	GAS	GAS LINE/GATE WATER LINE/GATE			
		ж.	HYDRANT			
	——————————————————————————————————————	ECT	UNDERGROUND ELECTRIC,			
_		\bigcirc	STREET LIGHT			
		Т	ELECTRICAL TRANSFORMER			
			SEWER SLEEVE			
		—< <u>()</u> —	CHECK VALVE			
		[-M	WATER LOT SERVICE CONNECTION (CAP AND GATE VALVE)			
		[-×	GAS LOT SERVICE CONNECTION (CAP AND GATE VALVE)			
		_ = = = = S = = = S =	CONSTRUCTED SEWER			
		w w-	CONSTRUCTED WATER			
CH OH	TIONAL VIDER	WATER WOH	SEEN	11.19.21 4.23.20 2.05.19 Date Date	REV. PER CON. COMM REV. PER CON. COMM REVISED PER TO REVISED WETLA De: Revis	MA REGISTRATION #47917
	ED. AS-BUILT DATA		PRICE, CO.	Project	MASSACHU	SETTS
				DEFI Prepared fo	PLA MASSAPOA WEYMOL	G STREET
CUMENTS AND SHALL COMPLY WI VENTION PLAN (SWPPP) PREPAREI					WEATH	ERVANE
ED FOR INSPECTIONS AND TESTIN	G ASSOCIATED WITH SUC	H.		Ν		DAG, LLC.
RMITS AND CONSTRUCTION SHALL 6, PAVEMENT CUTTING, EXCAVATIO	ON, UTILITY CONNECTIONS	S, Al SUB	PPROVAL UNDER THE DIVISION CONTROL LAW			REET, SUITE 311
		- WEYN	IOUTH PLANNING BOARD	Drawing Titl	e	
	INGINEER AND FIRE				ידו וודון	Y PLAN
OR SEPTIC SYSTEM DETAILS. G ON THE WATER AND FIRE SERVIC R THE INTENT OF THESE DRAWING	S IS THAT THE CONTRACT	OR			UTILIT	
OF ALL COMPONENTS NECESSARY	TO CONSTRUCT , OPERA	TE		Project No.	100-028	Drawing No.
RE APPROXIMATE. REFER TO FINAL C, TELECOM, CABLE AND EQUIPMEN	NTS.			Date	12.20.2018	
SEWER EJECTOR PUMP SYSTEM I SEWER MANHOLE SHALL BE INST THE PRIVATE PUMPED DISCHARGE	ALLED ON THE LOT (OUTS	IDE		Scale	1"=20'	C-5
THE PRIVATE POMPED DISCHARGE DLE SHALL ALL REMAIN PRIVATELY Y FOR CONSTRUCTION, THE GRAV	OWNED AND MAINTAINED	DOES N	NG BOARD ENDORSEMENT NOT IMPLY CONFORMANCE OWN OF WEYMOUTH	Drawn By	SZA	U -J


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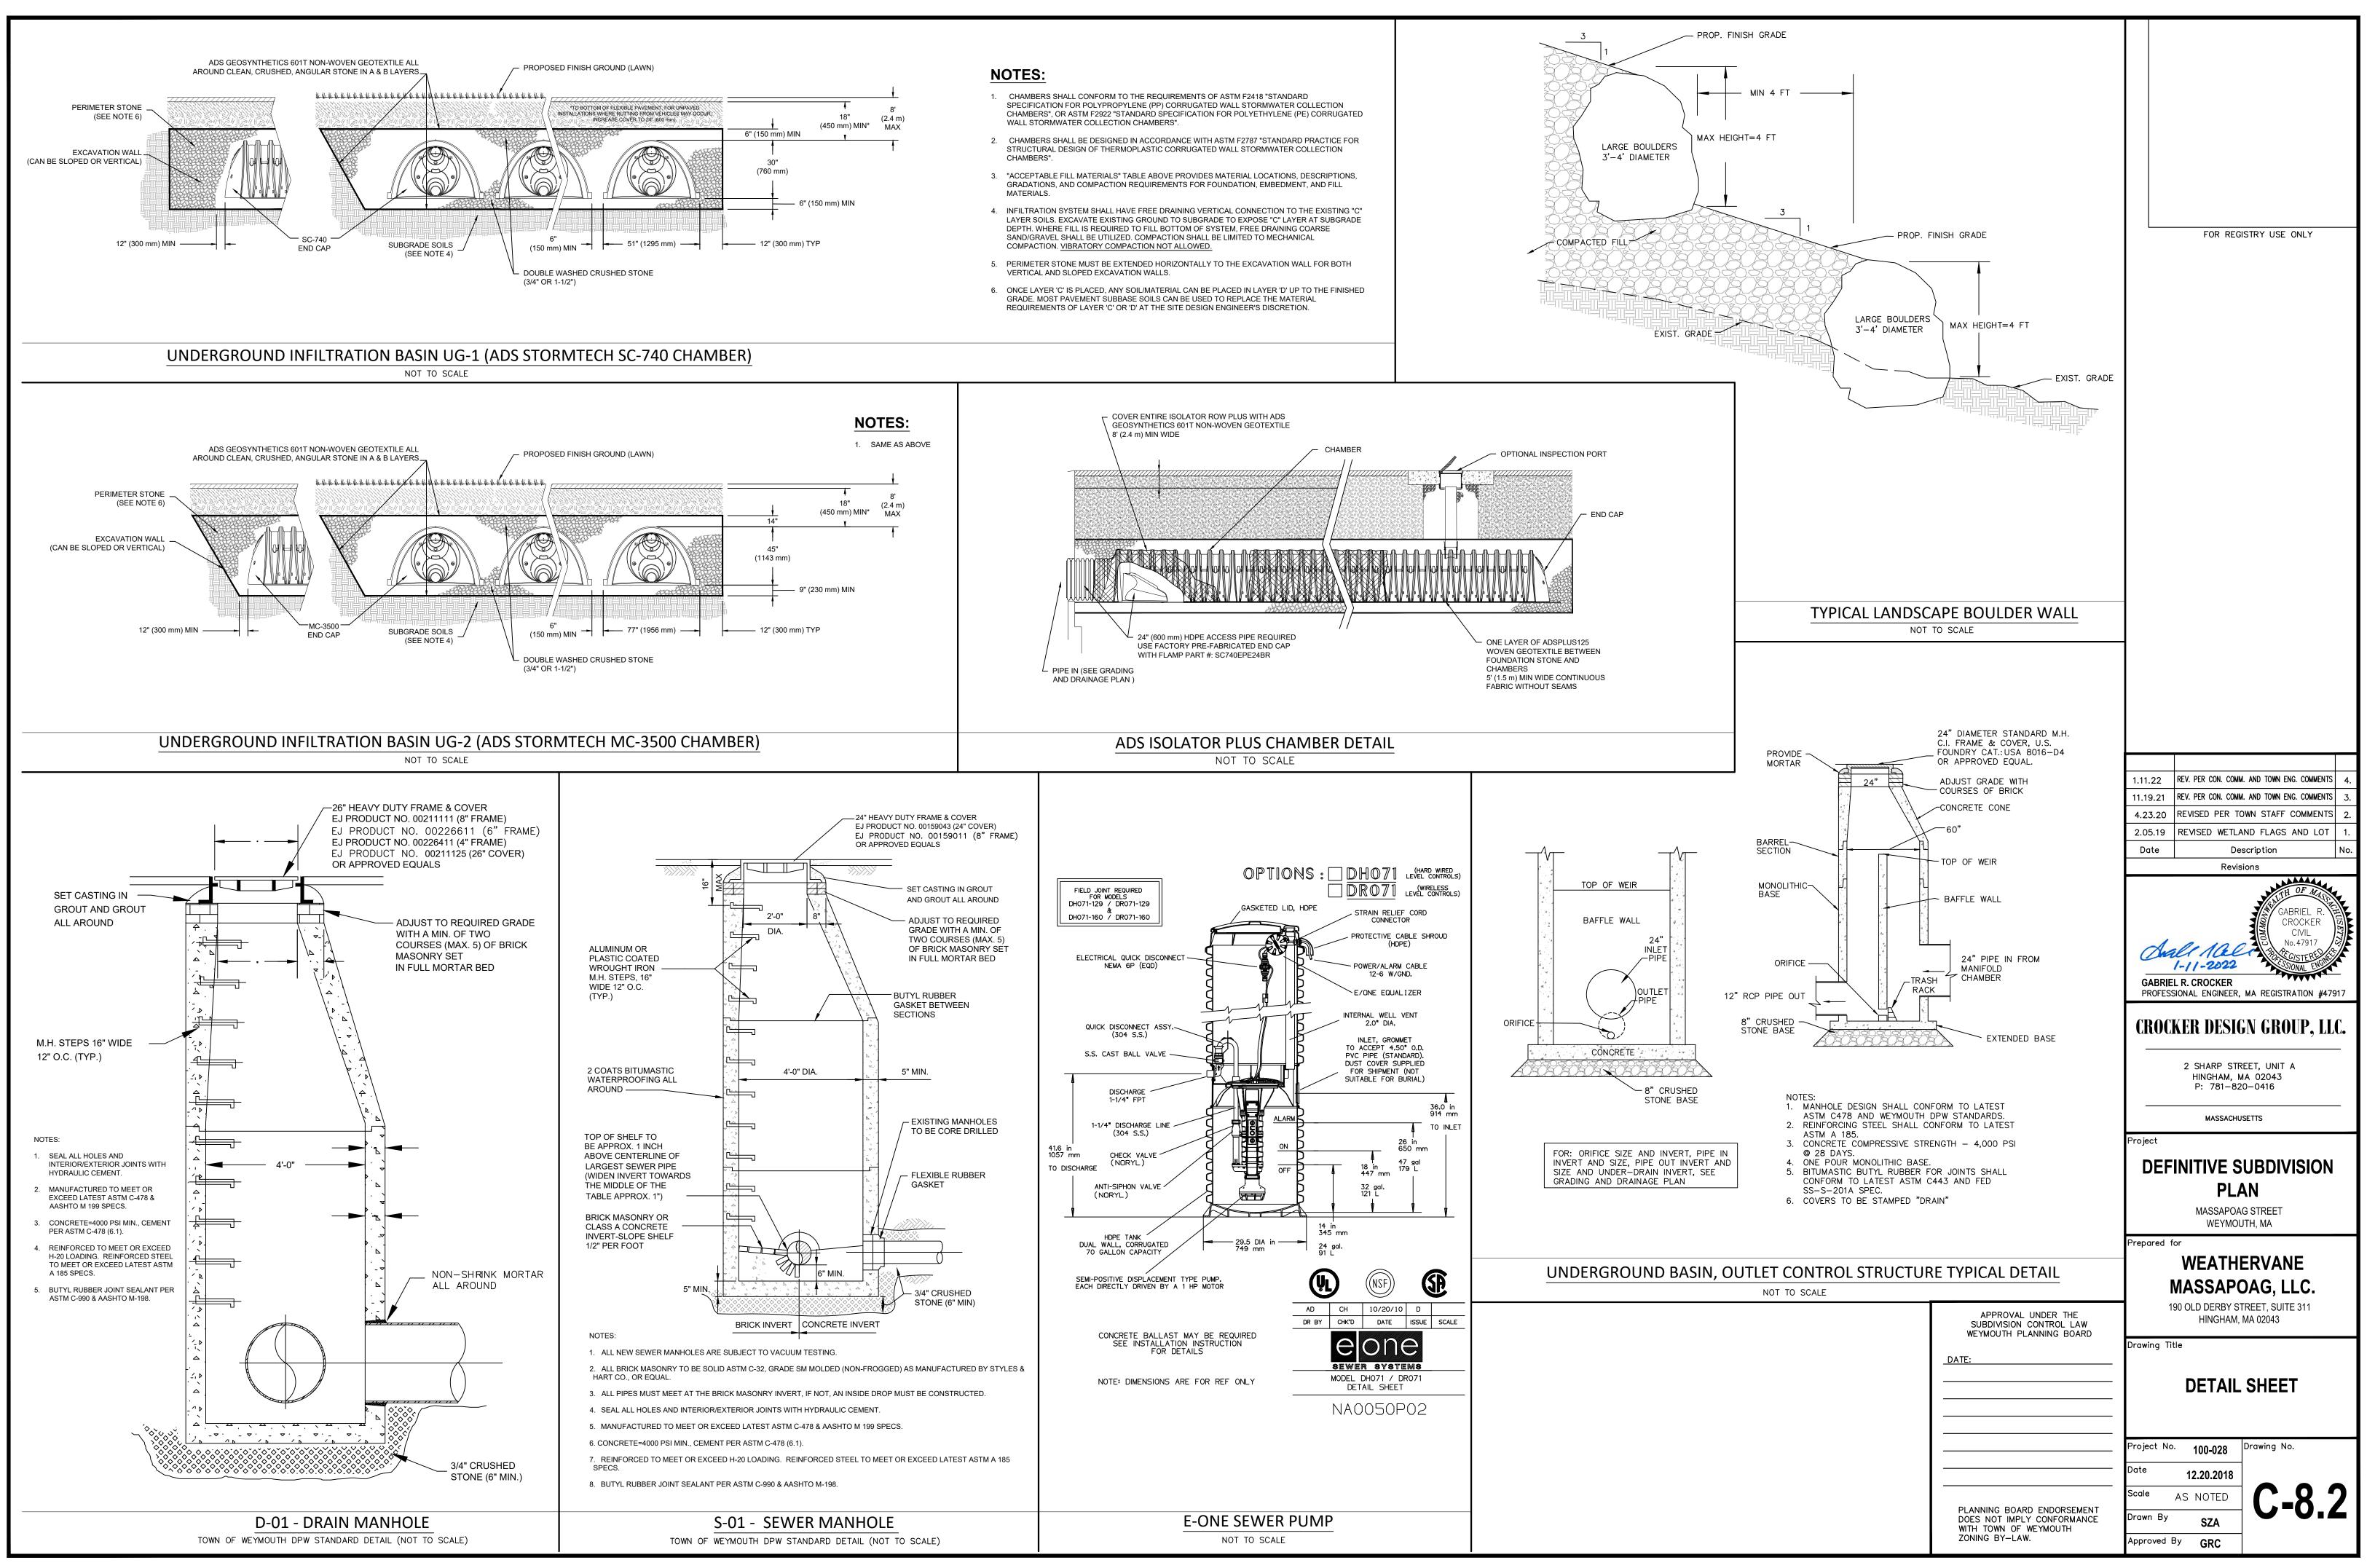
Approved By GRC

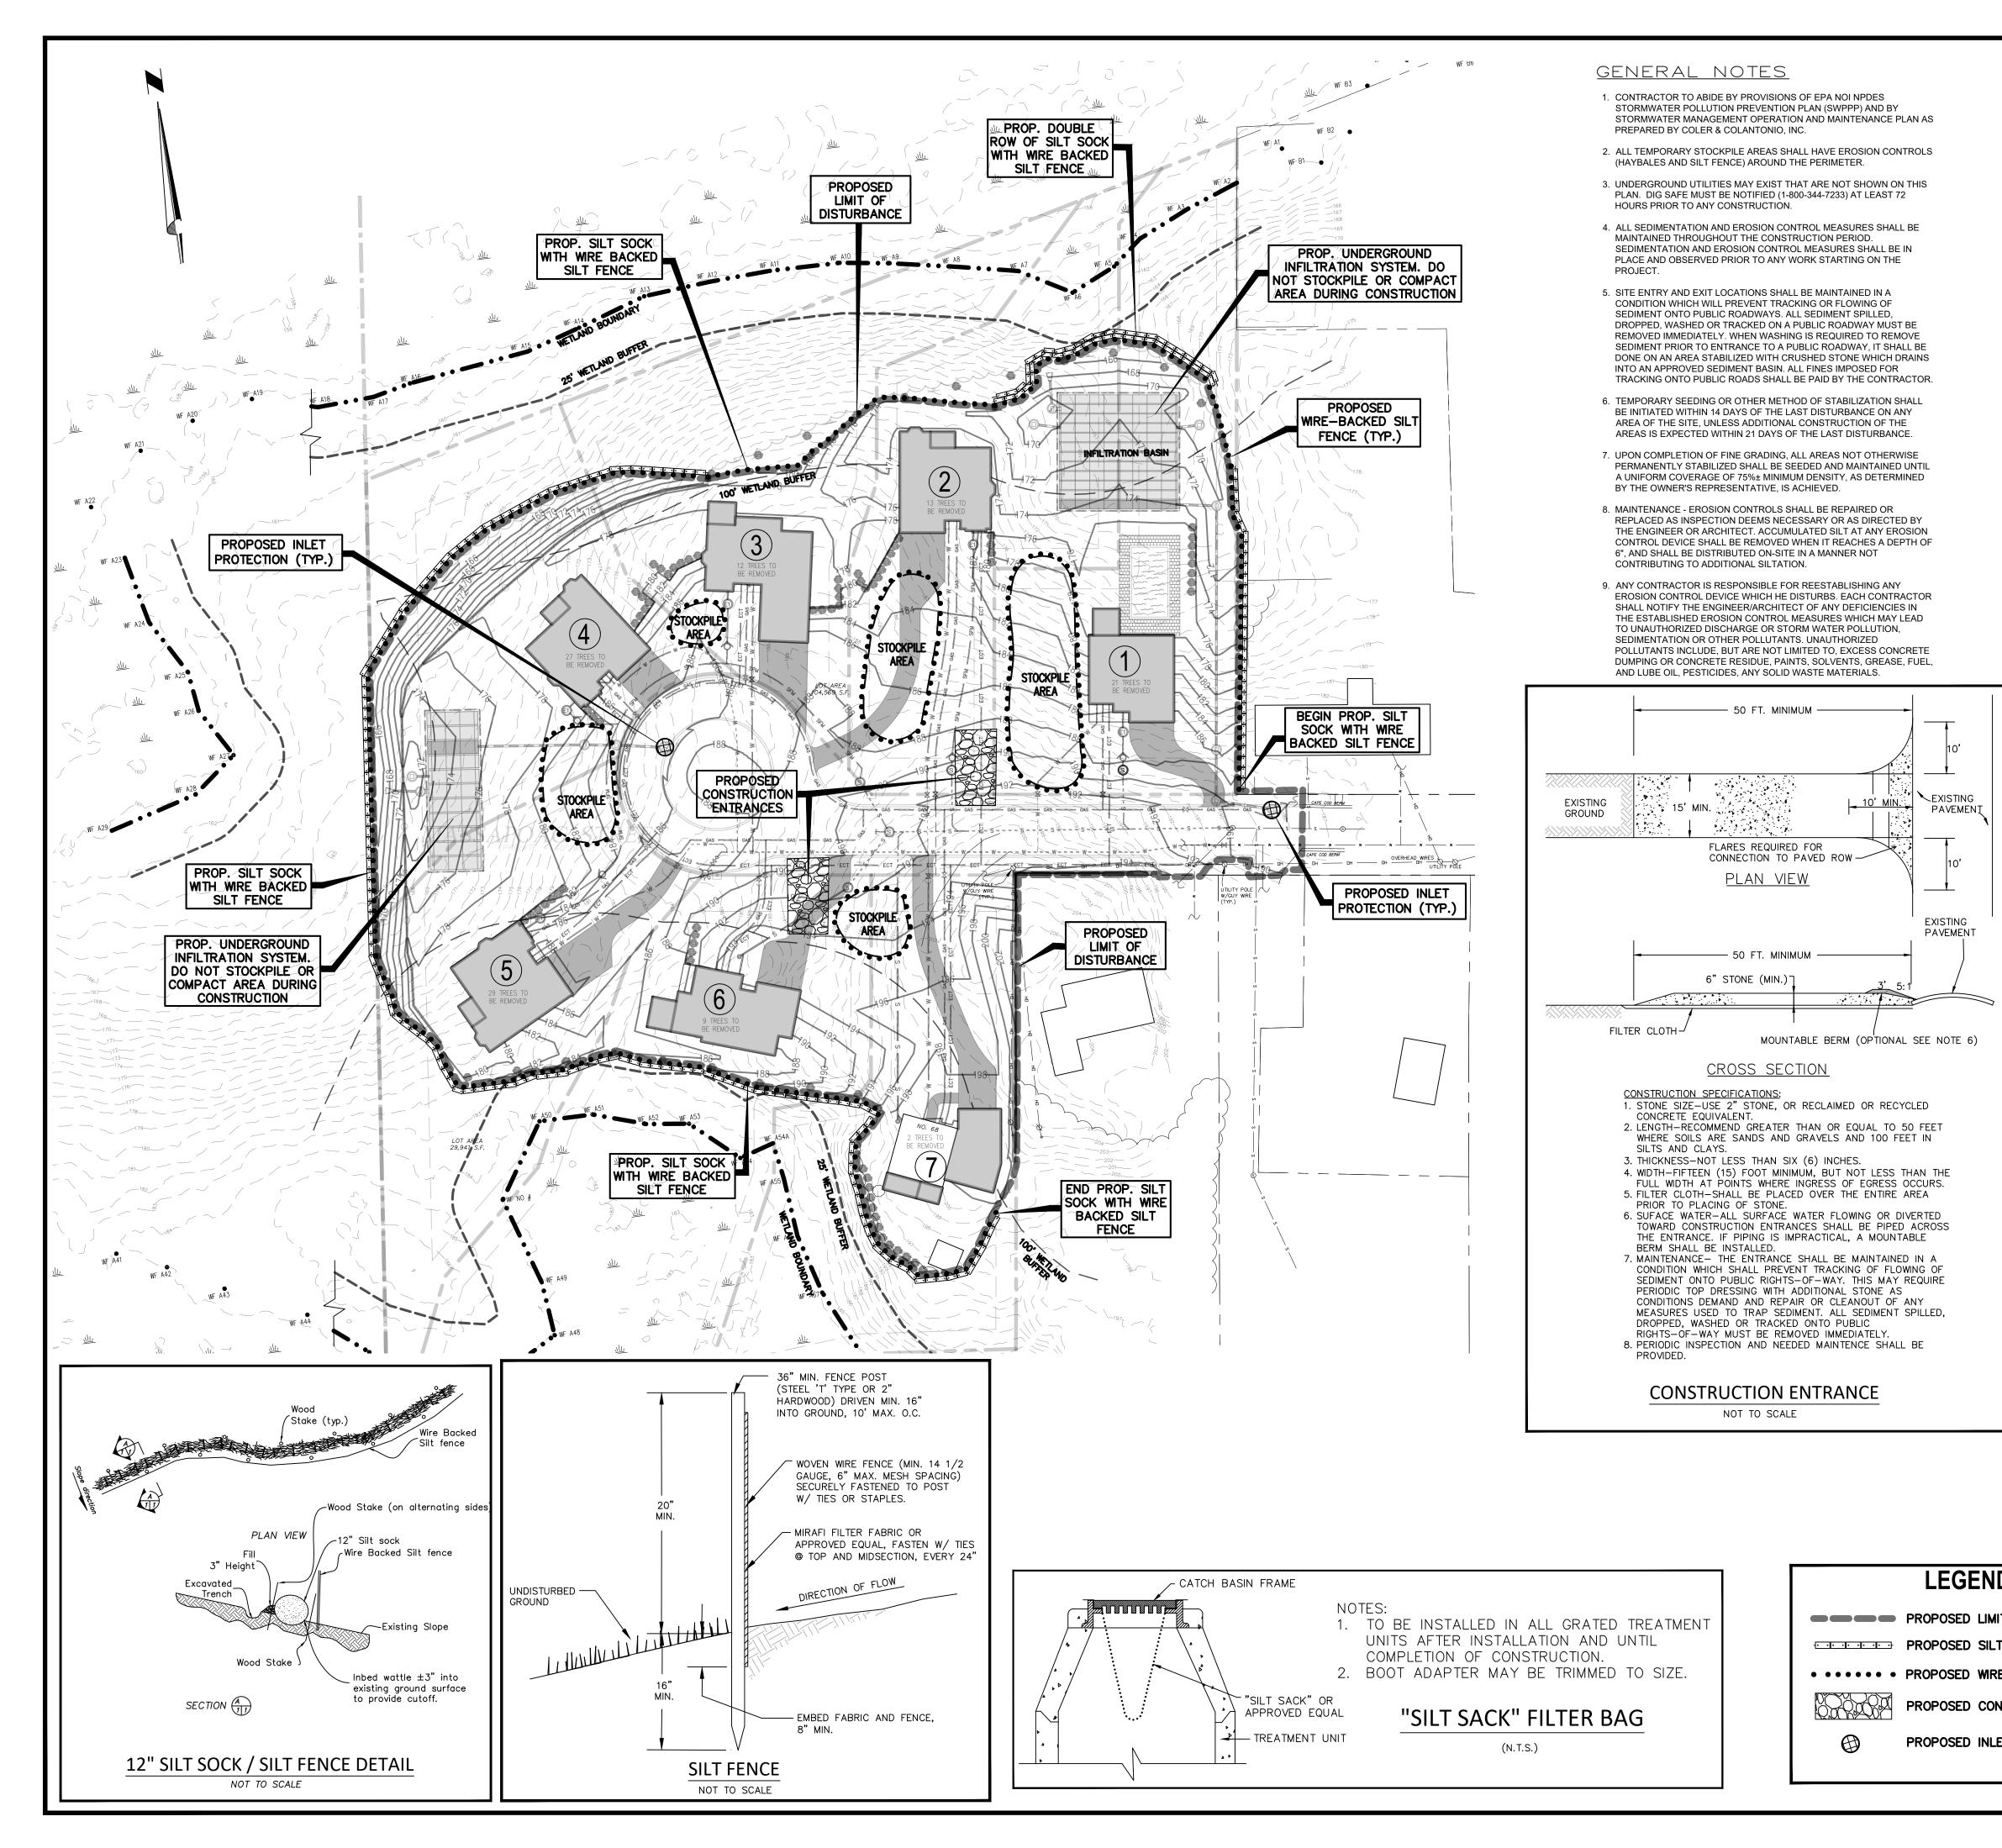

	(CONTINUATION OF (GENERAL NOTES)						
1	0. ALL SIDE SLOPES SH NETTING TO PREVEN		I GRASS OR INSTALL JUTE					
1	1. MAINTENANCE: ERO	SION CONTROLS SHA						
	THE ENGINEER OR A	ARCHITECT. ACCUMUL	SARY OR AS DIRECTED BY ATED SILT AT ANY EROSION HEN IT REACHES A DEPTH					
	,	E DISTRIBUTED ON-SIT						
1	PERSONNEL. DISTUR	RBED AREAS THAT HA	ERFORMED BY QUALIFIED VE NOT BEEN FINALLY					
	MEASURES, AND LOO	CATIONS WHERE VEH	STRUCTURAL CONTROL ICLES ENTER OR EXIT THE 7 DAYS AND WITHIN 24					
	HOURS OF A STORM AREAS ARE TO BE IN	EVEN OF 0.5 INCHES	OR GREATER. STABILIZED MONTH DISTURBED AREAS					
	INSPECTED FOR EVI		TIALION SHALL BE TIAL FOR POLLUTANTS ROL MEASURES SHALL BE					
	LOCATIONS AND POI	INTS SHALL BE INSPE	NG PROPERLY. DISCHARGE CTED TO ASCERTAIN SIGNIFICANT IMPACT. BASED			FOR REG	ISTRY USE ONLY	
	ON THE RESULTS OF CHANGES TO THE PL	F THE ABOVE INSPECT LAN WILL BE MADE WI	TIONS, ANY NECESSARY THIN 7 DAYS OF THE					
	THE CHANGES MUST		VN PLANNING BOARD. THE FIELD BEFORE THE ERWISE AS SOON AS					
1	POSSIBLE. 3.INSTALL AND MAINTA	AIN CATCH BASIN INSE	ERTS IN ALL PROPOSED AND					
1			ASINS, HAY BALES, ETC. AS					
	NECESSARY.							
	STOCKPILES NOT TO STABILIZED WITH SE) be reused within (Eed or mulch.						
1	6. CONTRACTOR TO MA EASEMENT EXCEPT DISTURBED WITHIN F	FOR SPECIFIC AREAS						
1	7. POTENTIAL STOCK P CONTROL MEASUR		DTECTED WITH EROSION					
1	TIMES AND SHALL PR	ROVIDE TEMPORARY S WOOD CHIPS TO MI	TRUCK ON-SITE AT ALL PLANTINGS OR OTHER NIMIZE THE AMOUNT OF					
			PHASING struction phasing. a					
	MORE DETAILED S		TED IN THE STORMWATER					
:	2. CENTERLINE OF RO DELINEATED BY CO		CONSTRUCTION TO BE					
:			DL MEASURES INCLUDING NAL FILTER SACK IN LIEU OF					
		ONTROL MÉASURES N	STALLED. CONTRACTOR IONTHLY AND AFTER RAIN					
	MATERIAL REMOVE	ED FROM THE SITE WI	DF DEBRIS AND BOULDERS. LL BE TRANSPORTED TO AN POSED OF ELSEWHERE	40 L	20	0	40 8	С
	ACCORDING TO FE STOCKPILES OR A	EDERAL, STATE, AND L REAS OF GRANULAR I	OCAL GUIDELINES. INACTIVE					
	SEDIMENT LADEN	RUNOFF.) IN ORDER TO CONTROL	F				
	5. CONTRACTOR IS R NECESSARY GRAD		OUT UTILITIES AND ANY	1.	11.22 R	ev. Per con. com	I. AND TOWN ENG. COMMENTS	4.
	DETENTION BASIN	S AND DIGGING OF UT						3.
	SITE AREA FOR FIL SUITABLE TOPSOIL	L OR PROPERLY REM L IS FOUND, IT WILL B			.20.20			2. 1.
		NUPLAND AREA AT LE	AST 100' FROM WETLANDS DJECT.	_	Date		•	10.
		S. SETTING OUT OF FO	L ON ALL ACCESS ROADS DUNDATIONS AND	_		Revis	TH OF MAN	
ł	8. LAYING OF ALL UT	ILITIES INCLUDING DR					SAUTH OF MASS	
	ONLY TRENCHES E	BEING WORKED ON OF			,		CROCKER CIVIL No.47917	
9	9. FINE GRADING FOF DRAINAGE BASINS	R THE PARKING AREA TO BE COMPLETED.	S, ROADWAYS, AND			// ACel -11-2022	ROLATION CONTRACTOR	
	10. DRAINAGE BASIN V DISCHARGE FROM	VEGETATION TO BE ES			GABRIEL	R. CROCKER	MA REGISTRATION #4791	7
			D INLETS TO PREVENT				"	
	12. INSTALL BINDER C				LKUCK	EK DESI	SN GROUP, LLC	•
	13. LIGHT POLES, SIGN					2 SHARP STR		
	14. INSTALL TOP COUF					HINGHAM, N P: 781-82		
	SHALL BE LANDSC	APED OR SEEDED (SE	CES. DISTURBED AREAS E ADDITIONAL DISCUSSION ER CONDITIONS PREVENT			MASSACHU	SETTS	
	FINAL STABILIZATION MEASURES WILL B	ON, TEMPORARY ERO E EMPLOYED UNTIL T	SION AND SEDIMENTATION HE TEMPERATURE AND DWING. A FINAL INSPECTION	Pro	oject			
	WILL ENSURE THA AND THAT EROSIO	T THE SITE IS CLEARE ON AND SEDIMENTATIO	ED OF ALL PROJECT DEBRIS		DEFI	NITIVE S	UBDIVISION	
	IN PLACE UNTIL TH	IE SITE IS FULLY STAE	ND SILT FENCE WILL REMAIN BILIZED AND THE SITE HAS N IS TO BE OF A UNIFORM			PL	AN	
	DENSITY OF AT LEA	AST 75% FOR ACCEPT	ANCE.			MASSAPOA WEYMOU		
				Pre	epared for			
							ERVANE	
							DAG, LLC.	
			APPROVAL UNI SUBDIVISION CON WEYMOUTH PLANN	TROL LAW		HINGHAM,	,	
D			DATE:	Dro	awing Title			_
IIT OF DISTL	JRBANCE				S	OIL ERO	SION AND	
T SOCK					SEDIN	MENT CO	ONTROL PLAN	1
RE BACKED	SILT FENCE			 	hingt N		Drawing No.	
NSTRUCTION	ENTRANCE			Pro	oject No. te	100-028	Drawing No.	
ET PROTEC	TION			Du		12.20.2018	\frown	
			PLANNING BOARD E DOES NOT IMPLY C		awn By	1"=40' \$74	C-6	
		1	WITH TOWN OF WEY ZONING BY-LAW.	MOUTH	proved By	SZA GRC		
					-			



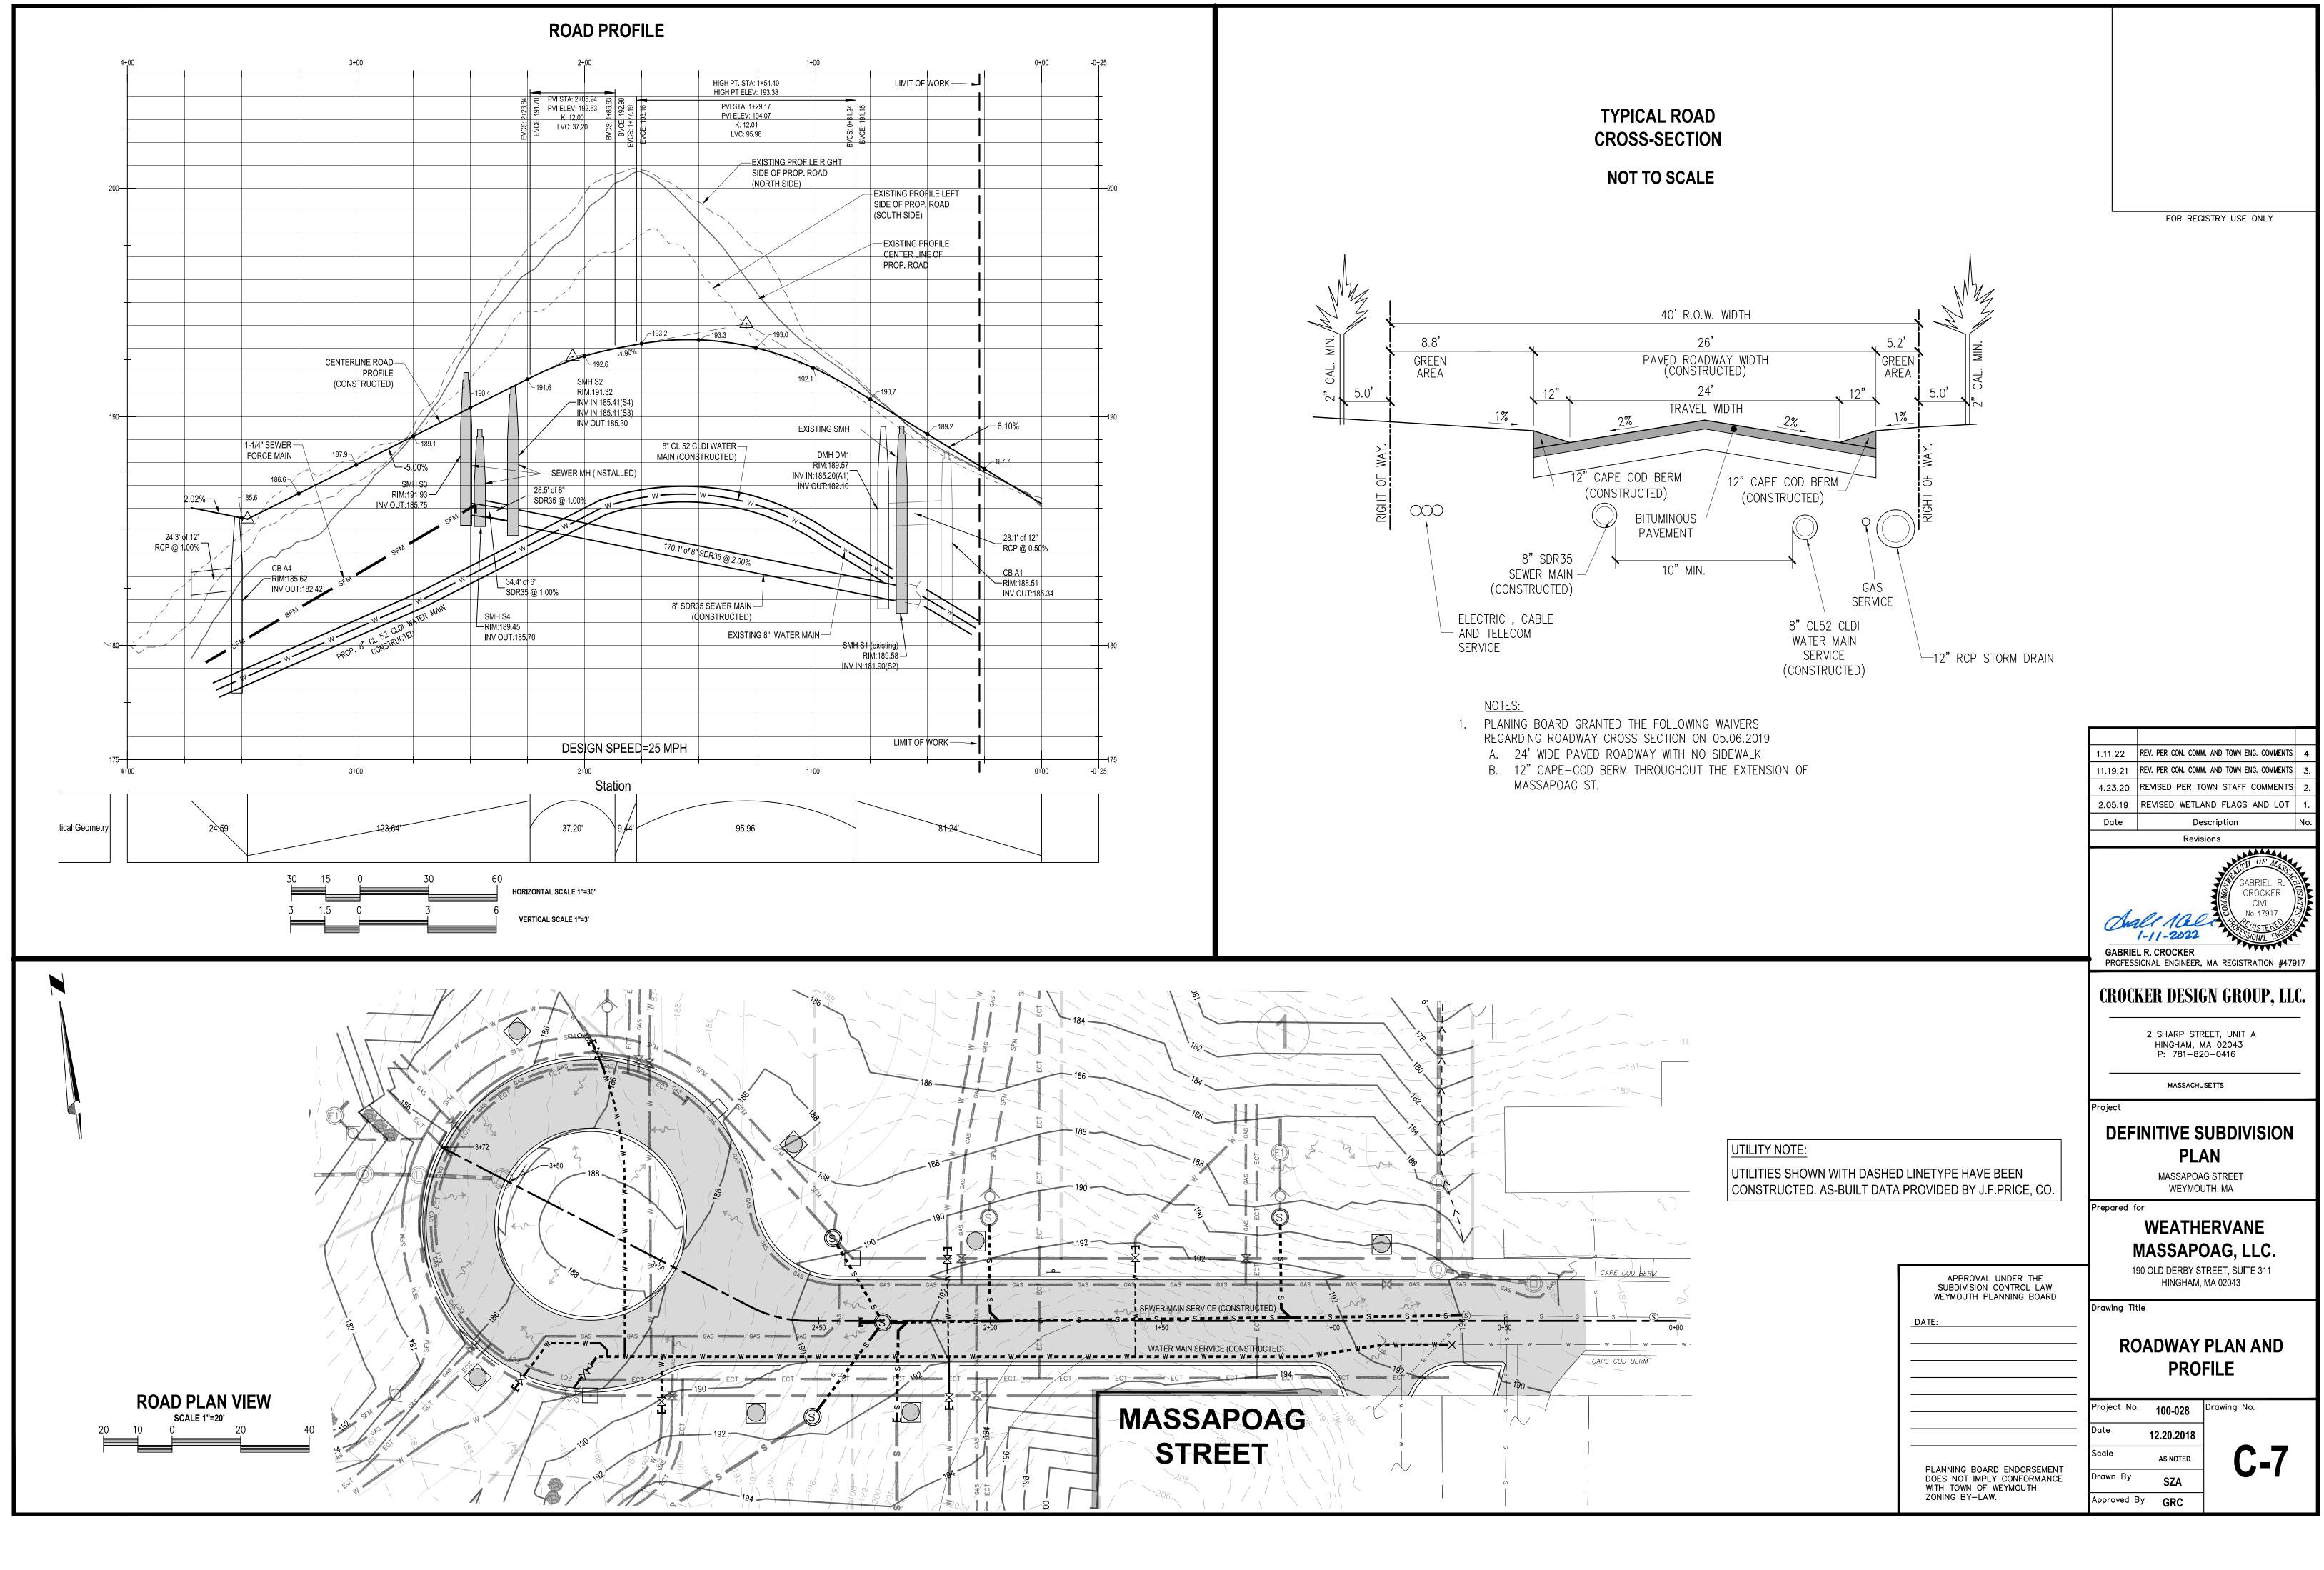

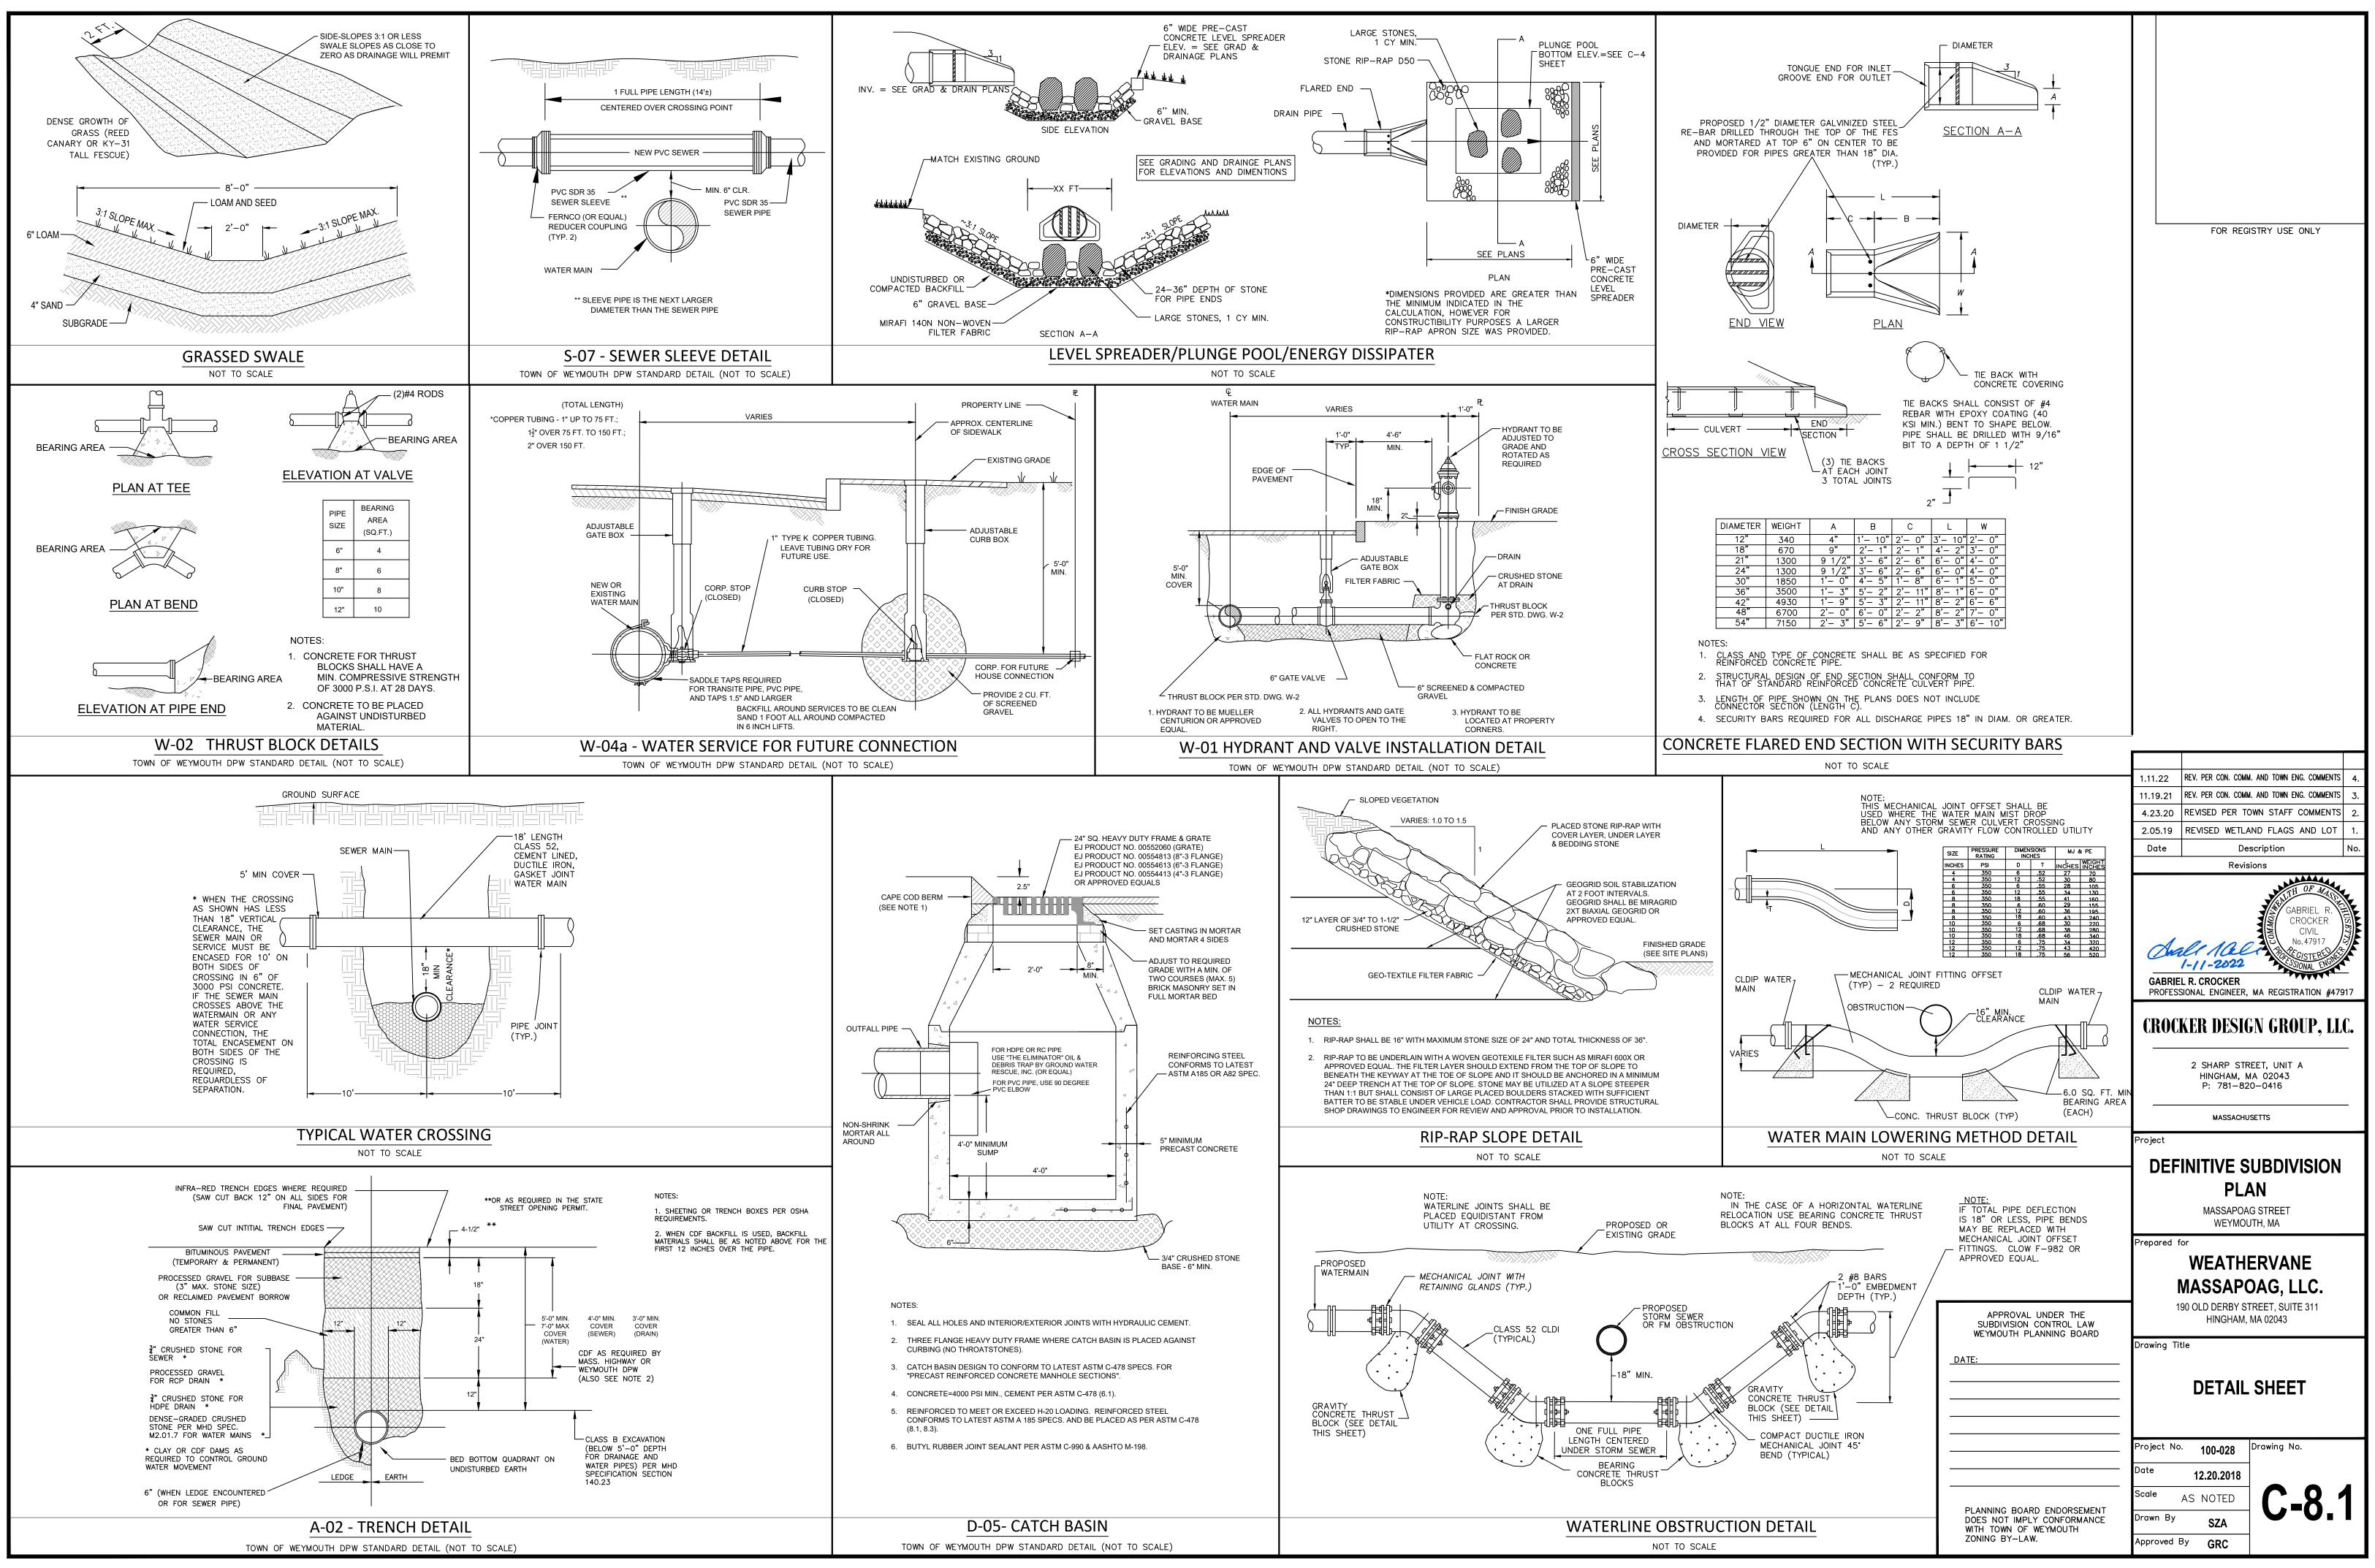

BRAINTREE

BRAINTRE ASSESSORS REF

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TEST PIT 3-1 GROUND ELEV=188.86

SHGW ELEV=N/A BOTTOM OF TP=180.69 SANDY LOAM

TEST PIT 3-4 GROUND ELEV=165.13

SHGW ELEV=N/A BOTTOM OF TP=158.79 SANDY LOAM

TEST PIT 3-7 GROUND ELEV=167.40 SHGW ELEV=N/A BOTTOM OF TP=159.90

LOAMY SAND (-20" to -90") TEST PIT TP-1

GROUND ELEV=174.82 SHGW ELEV=165.82 BOTTOM OF TP=164.32 COARSE SAND (-12" to -126")

TEST PIT 3-2 GROUND ELEV=194.48 SHGW ELEV=N/A BOTTOM OF TP=185.31 SANDY LOAM TEST PIT 3-5 GROUND ELEV=169.26 SHGW ELEV=N/A

BOTTOM OF TP=163.67 SANDY LOAM

TEST PIT 3-8 GROUND ELEV=167.26 SHGW ELEV=N/A BOTTOM OF TP=160.51

LOAMY SAND (-18" to -81") TEST PIT TP-2

GROUND ELEV=168.81 SHGW ELEV=162.81 BOTTOM OF TP=156.81 COARSE SAND (-60" to -144") TEST PIT 3-3 GROUND ELEV=163.36 SHGW ELEV=158.69 BOTTOM OF TP=157.69 SANDY LOAM

TEST PIT 3-6 GROUND ELEV=182.11 SHGW ELEV=N/A BOTTOM OF TP=175.94 SANDY LOAM

TEST PIT 3-9 GROUND ELEV=167.48 SHGW ELEV=N/A BOTTOM OF TP=160.81 LOAMY SAND (-20" to -80")

TEST PIT TP-3 GROUND ELEV=168.48 SHGW ELEV=162.48 BOTTOM OF TP=157.98 COARSE SAND (-64" to -126")

