JACKSON SQUARE

WEYMOUTH, MA

SEPTEMBER 6, 2023 NOI PLAN REVIEW

ABBREVIATIONS

ACT ADA ACOUSTIC CEILING TILE AMERICANS WITH DISABILITIES ACT APPROX APPROXIMATE ARCHITECTURAL ARCH AUDIO VISUAL BLDG BUILDING BLKG B.O. BLOCKING BOTTOM OF CABINET CEILING HEIGHT CENTERLINE COL. CONT. COLUMN CONTINUOUS CONCRETE MASONRY UNIT

ABOVE FINISHED FLOOR

CMU C.J. CONTROL JOINT DIAMETER DIM. DOWN DWG. DRAWING existing



FACE OF STUD GFIC GSM. GWB GROUND FAULT INTERCEPTOR CIRCUIT GALVANIZED SHEET METAL GYPSUM WALL BOARD H OR HVAC HEATING, VENTILATING, AND AIR CONDITIONING HOSE BIB H.B. HOLLOW METAL HM

MAXIMUM M.O. MASONRY OPENING MECH. MECHANICAL, ELECTRICAL, PLUMBING MEP MINIMUM MISC MISCELLANEOUS MTL. METAL

N.I.C. NOT IN CONTRACT N.T.S. NOT TO SCALE ON CENTER OUTSIDE DIAMETER OPNG. OPENING OPP. **OPPOSITE** P.G. PAINT GRADE PLYWD. PLYWOOD


PTD. PAINTED R.D. **ROOF DRAIN** REQUIRED R.O. ROUGH OPENING SCHEDULE STAIN GRADE SIM S.L.D. SIMILAR SEE LANDSCAPE DRAWINGS SQ. SPEC. S.S.D. SSTL. SQUARE SPECIFICATION SEE STRUCTURAL DRAWINGS STAINLESS STEEL STOR.

STEEL STORAGE STRUCTURAL SYMMETRICAL TONGUE AND GROOVE THICKNESS TOP OF TOP OF SLAB TUBULAR STEEL

THK. T.O. T.O.S. T.S. TYP. TYPICAL U.O.N. UNLESS OTHERWISE NOTED V.I.F. VERIFY IN FIELD

WITH W/O WD WPM. WITHOUT WOOD WATERPROOFING MEMBRANE


SYMBOLS

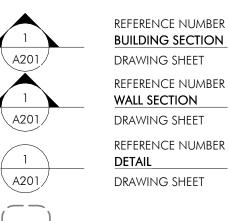

REFERENCE NUMBER DRAWING Drawing sheet

REFERENCE NUMBER


INTERIOR ELEVATION

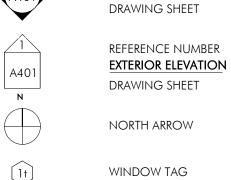

X000 INTERIOR WALL TYPE TAG APPLIANCE TAG





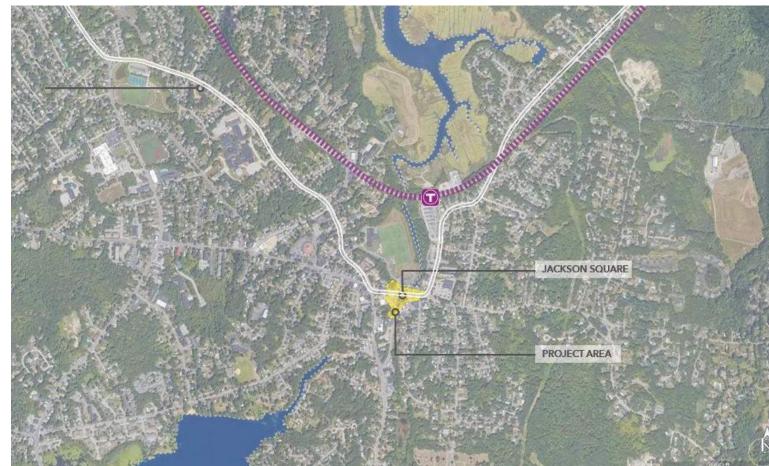

VICINITY MAP

SHEET LIST

ARCHITECTURAL

A000 A010	COVER SHEET ARCHITECTURAL SITE PLAN
CIVIL	
EX-1 EX-2 EX-3 C-1 C-2 C-3 C-4 C-5 C-6 C-7 C-8 C-9 C-10 C-11 C-12 C-13 C-14	EXISTING CONDITIONS PLAN EXISTING CONDITIONS PLAN SITE LAYOUT PLAN BUILDINGS A&B SITE LAYOUT PLAN BUILDINGS C&D GRADING & DRAINAGE PLAN BUILDINGS A&B GRADING & DRAINAGE PLAN BUILDINGS C&D CONSTRUCTION DETAILS ENOSION CONTROL PLAN EROSION CONTROL PLAN
LANDSCAPE	

LANDSCAPE KEY PLAN LANDSCAPE PLANTING AND LIGHTING PLAN LANDSCAPE PLANTING AND LIGHTING PLAN L3 LANDSCAPE PLANTING AND LIGHTING PLAN LANDSCAPE DETAILS LANDSCAPE DETAILS

REVISIONS

SQUARE

REVIEW

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AND 1409 COMMERCIAL ST LLC 1 FRANKLIN STREET, UNIT 2308

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MDLA

840 SUMMER STREET

IRAKLIS N PAPACHRISTOS, MANAGER OF 864, 909, 910 BROAD ST LLCs

MCKENZIE ENGINEERING

150 LONGWATER DRIVE, SUITE 101 NORWELL, MA 02061 781.792.3900

MARK ISSUE DATE



DRAWING INFORMATION

ISSUE: NOI PLAN REVIEW SEPTEMBER 6, 2023 PROJECT #: 22034

DRAWING TITLE

COVER SHEET


SCALE: As indicated


DRAWING NUMBER

STRUCT.

SYM.

T&G

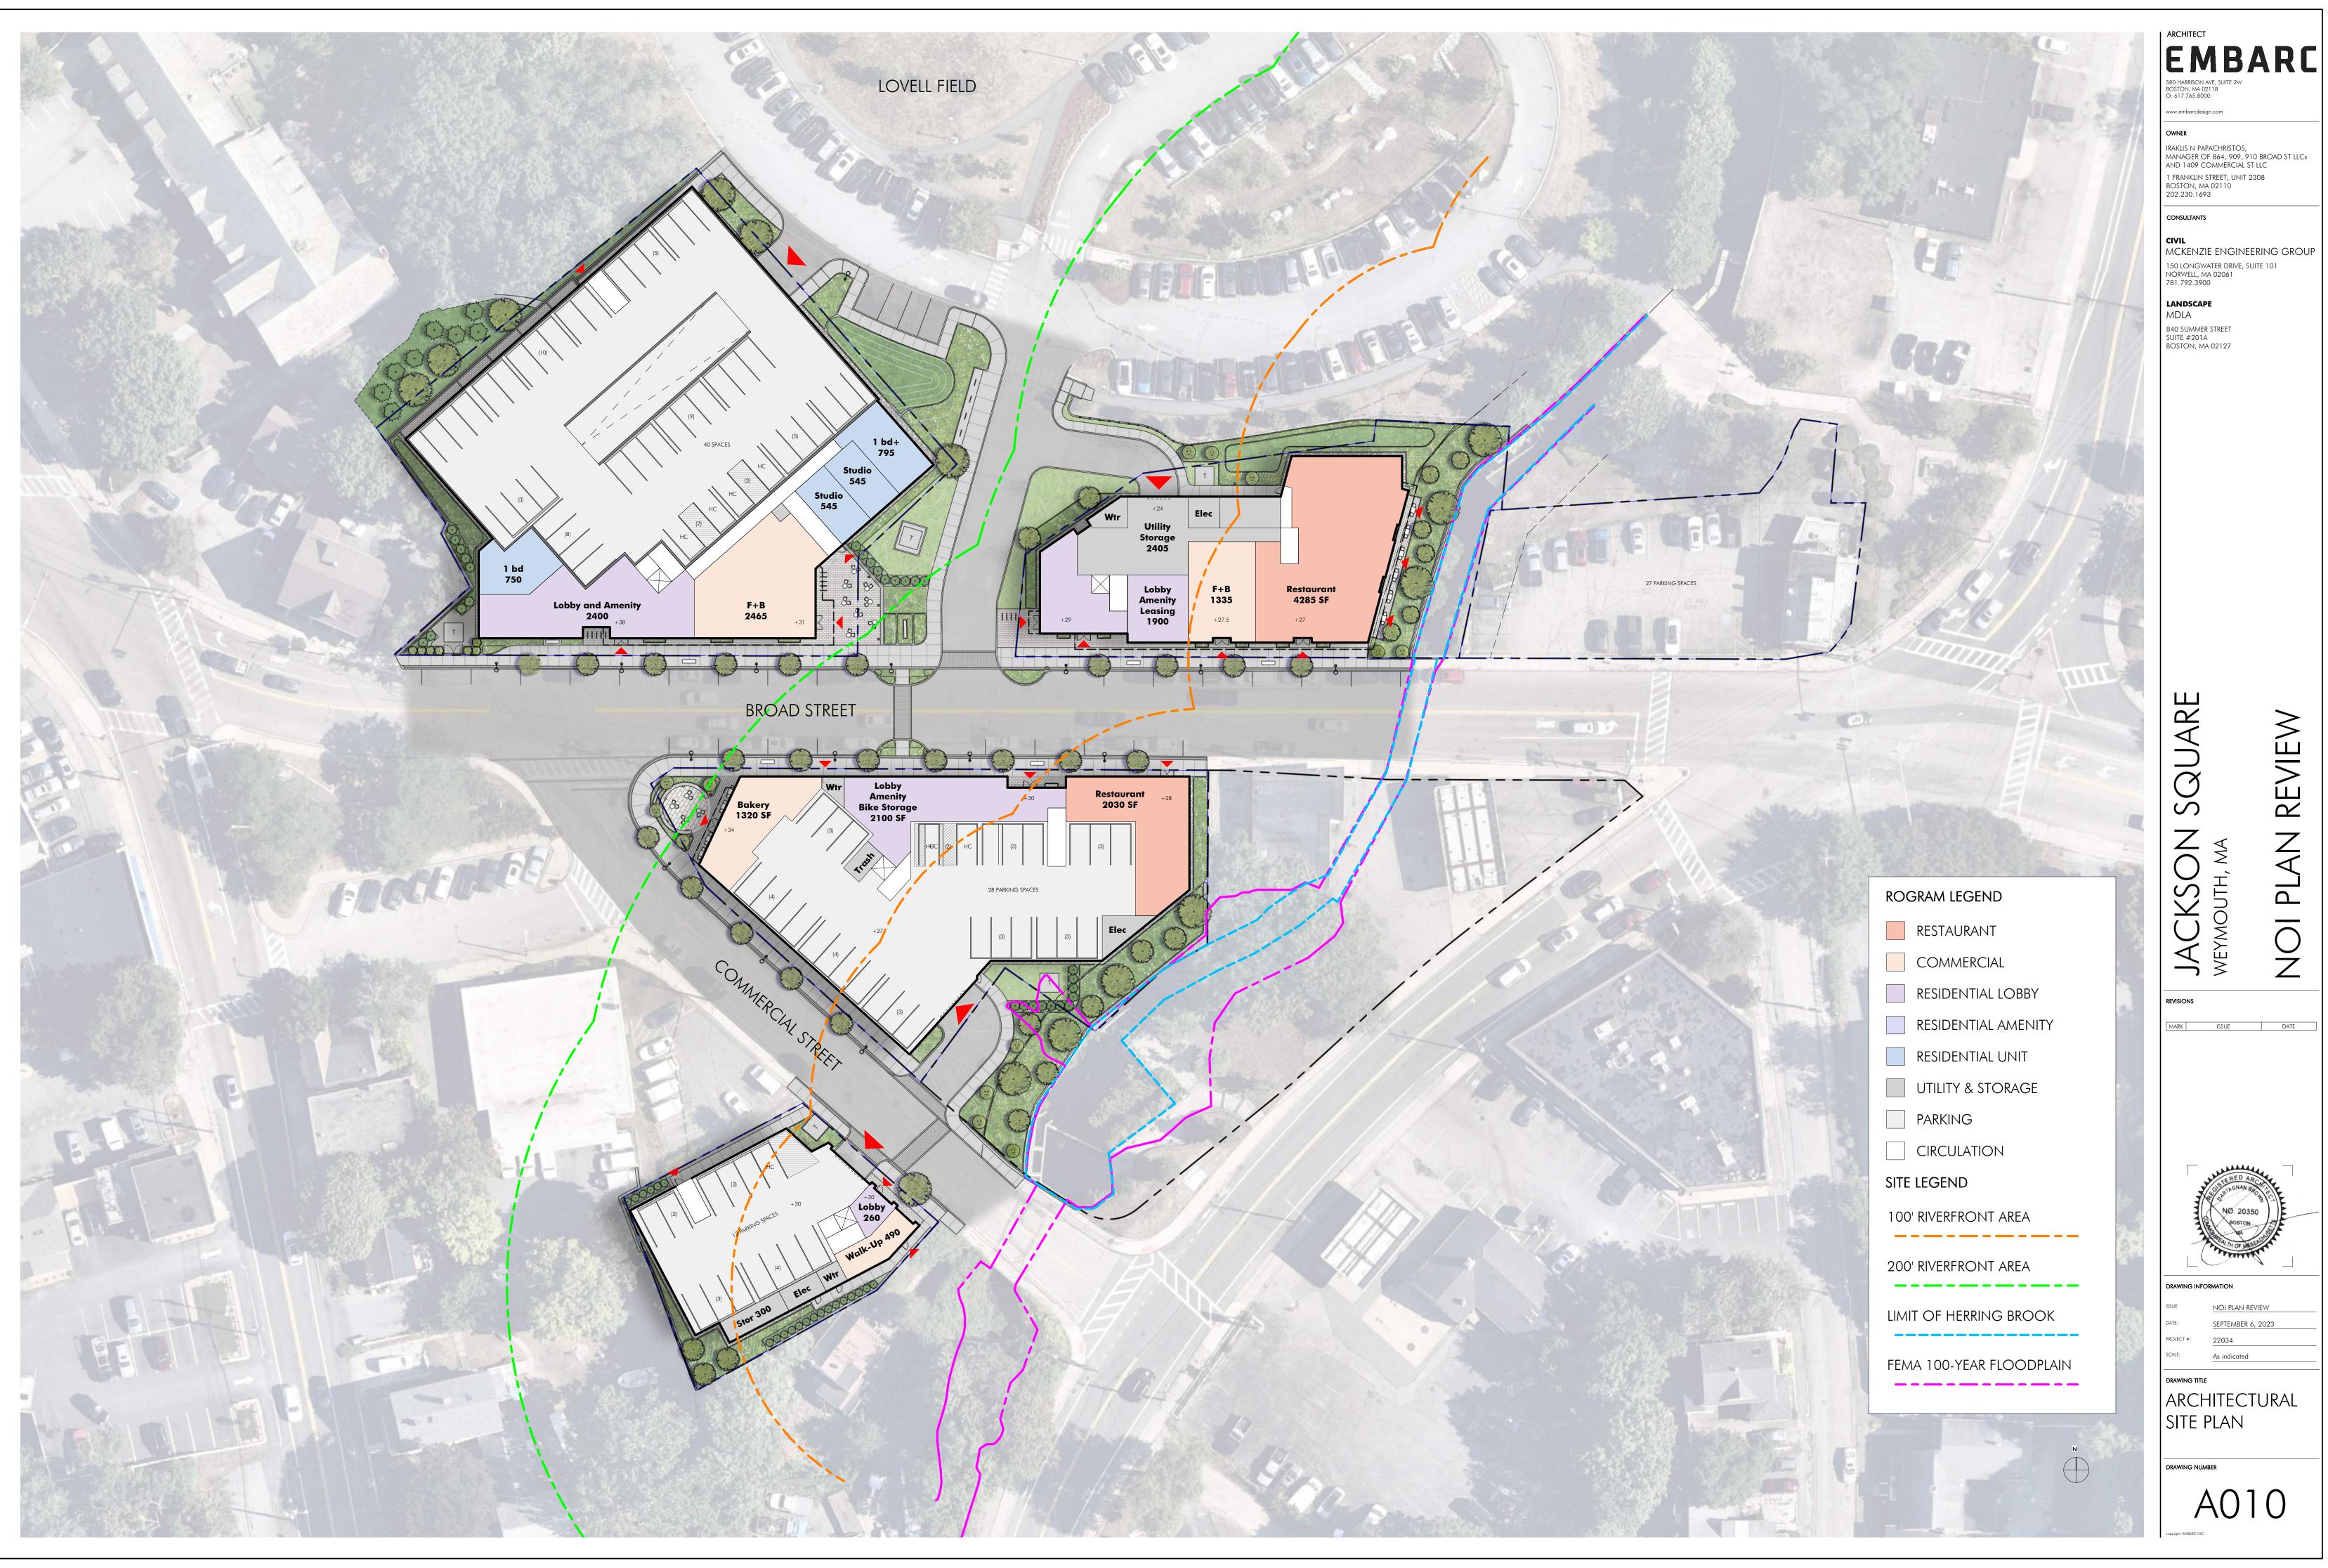

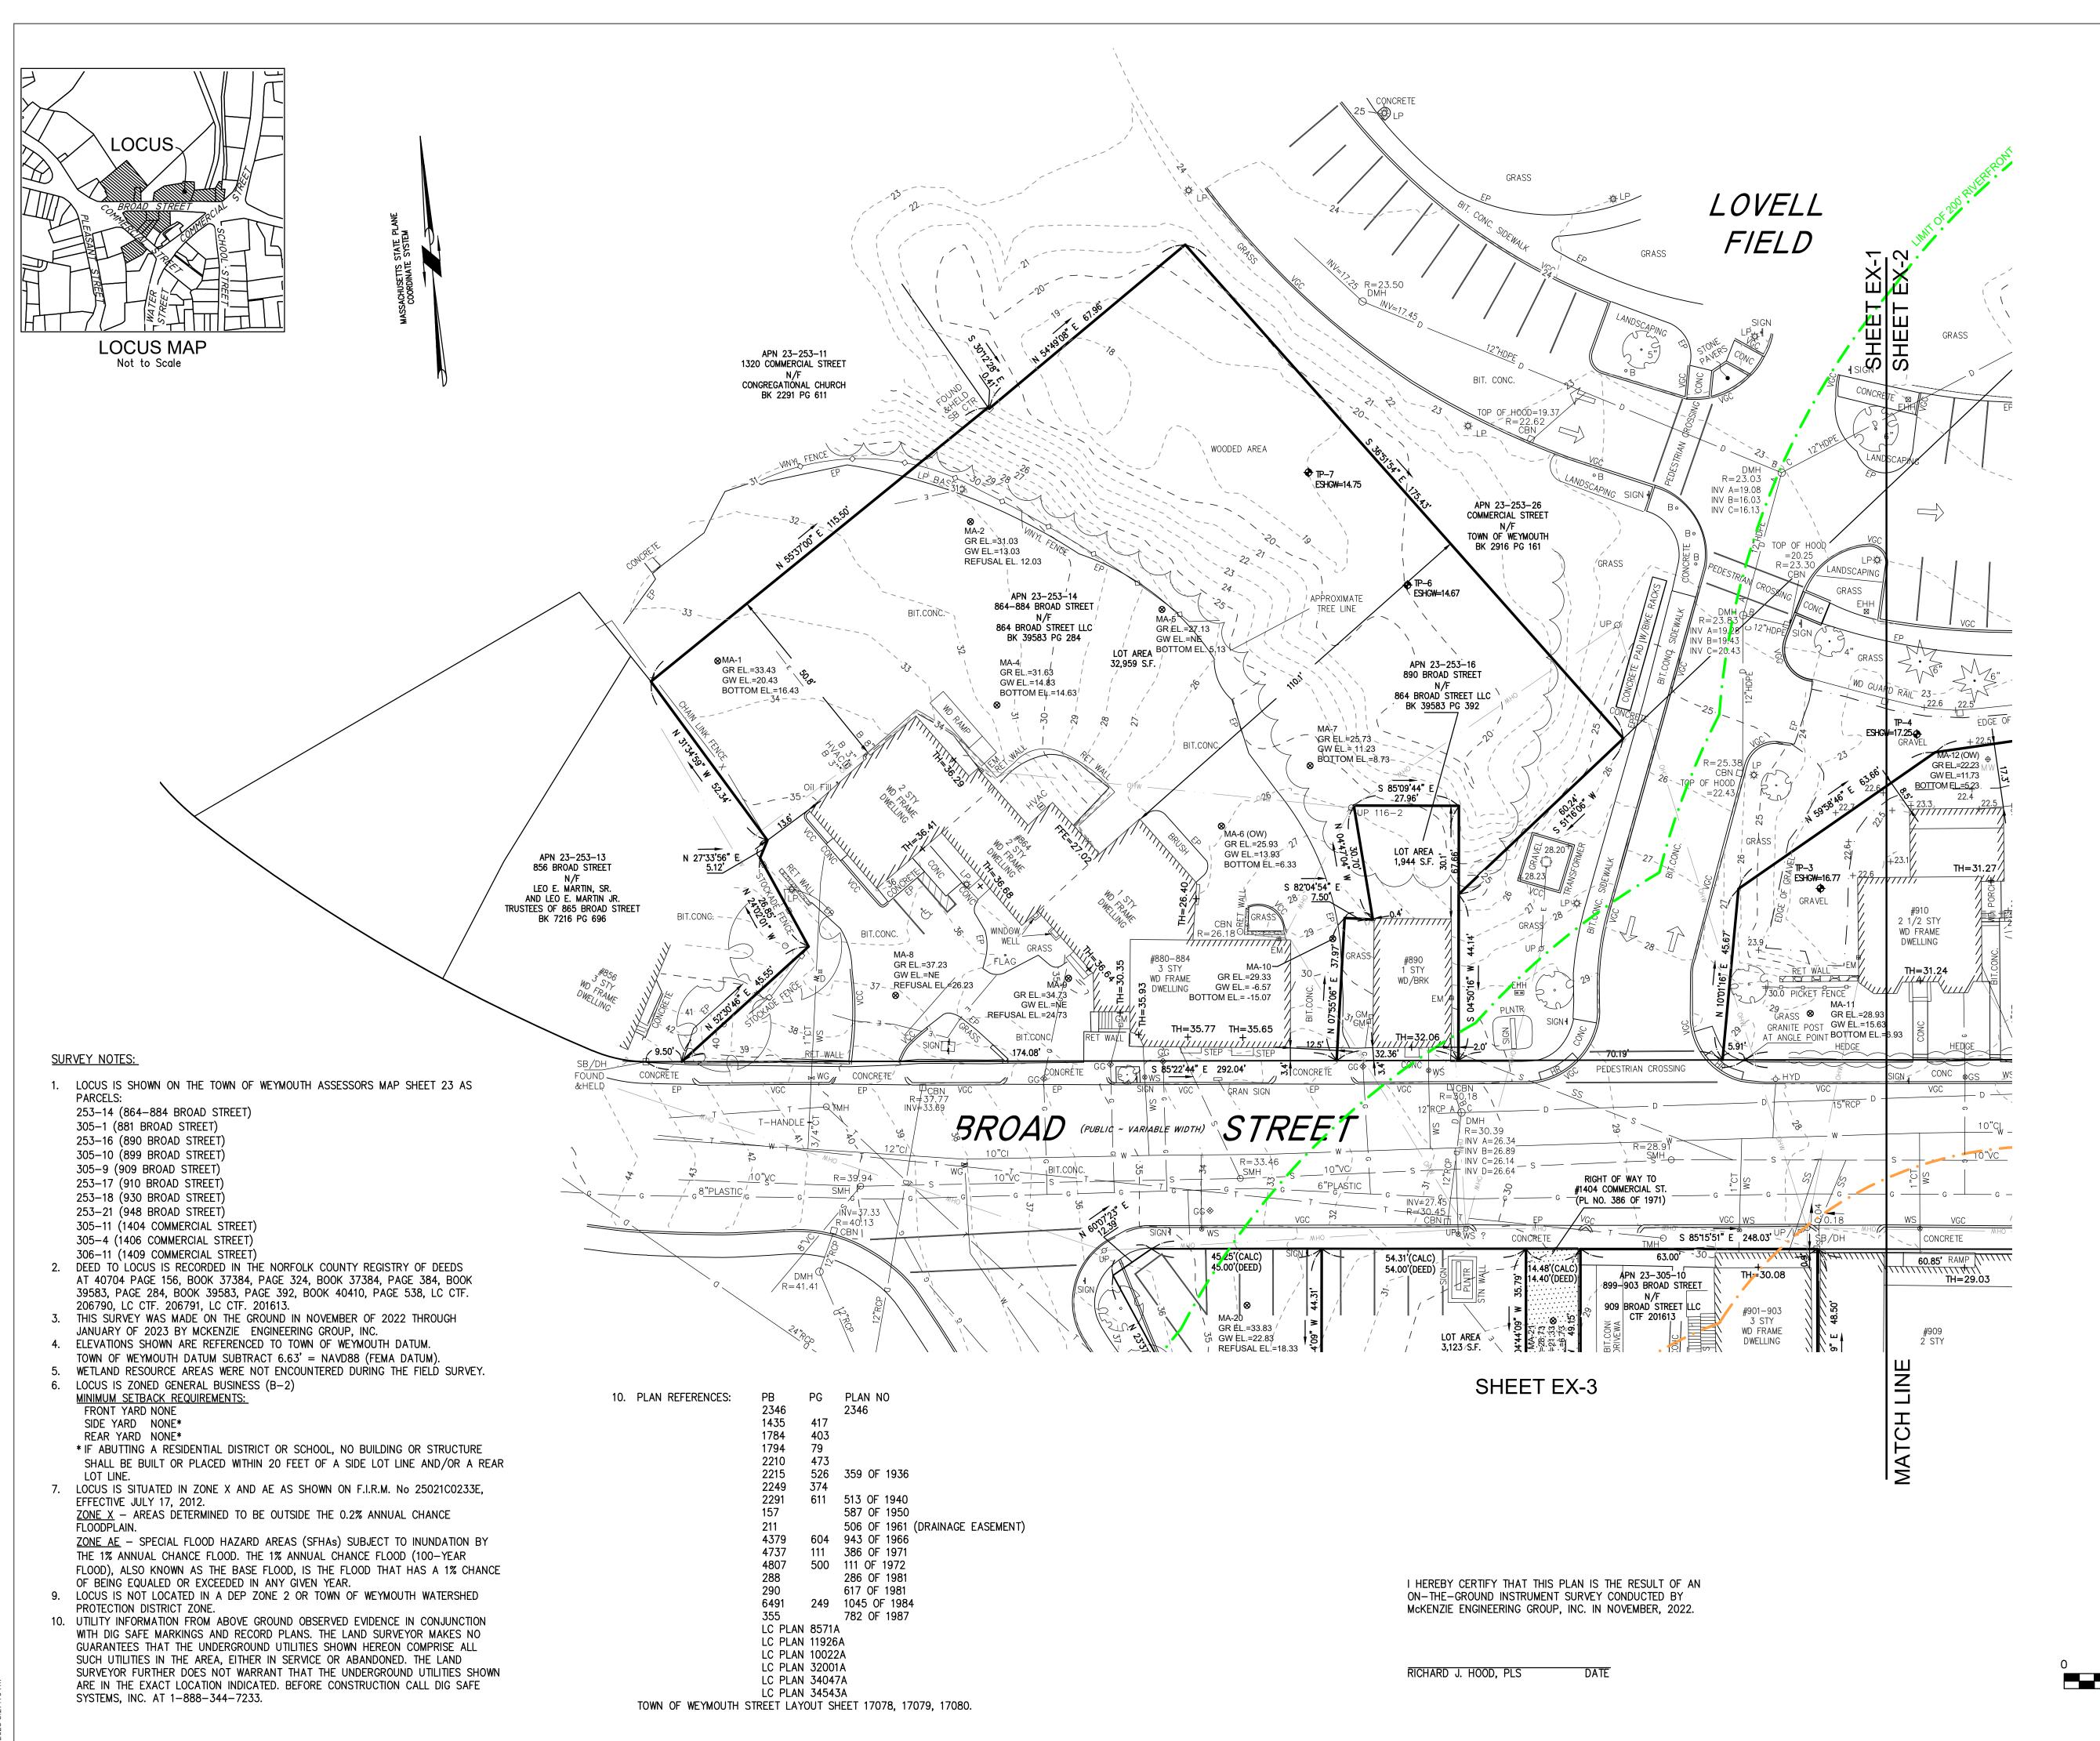

LEGEND SURVEY SYMBOLS REBAR ✓ ANGLE IRON CB/DH □ CONCRETE BOUND WITH DRILL HOLE SB □ STONE BOUND SB/DH ☐ STONE BOUND UTILITY SYMBOLS EX CHIMNEY ☑ ELECTRIC HAND HOLE Ø GUY POLE →GW GUY WIRE HVAC UNIT

-)O BUILDING LIGHT W∕MAST BUILDING LIGHT TRANSFORMER WATER GATE EXH⊗ EXHAUST VENT ◆ DRAINAGE SUMP

SMH SEWER MANHOLE O DMH DRAIN MANHOLE TMH TELEPHONE MANHOLE ☐ CBN DRAINAGE CATCH BASIN DOOR WAY THRESHOLD HYDRANT o POST INDICATER VALVE

Ø UTILITY POLE

EMH ELECTRIC MANHOLE

X YARD LIGHT RIP RAP

oB BOLLARD ¶ SIGN □FA FIRE ALARM

CONIFEROUS TREE

DECIDUOUS TREE

LINE DESIGNATORS

TTT GUARD RAIL RAILROAD TRACKS

----OHW----- OVERHEAD WIRES ---- G ---- GAS LINE -----WS------ WATER SERVICE ---- E ---- UNDERGROUND ELECTRIC

TELEPHONE LINE --- DRAINAGE SWALE --- X --- CHAIN LINK FENCE

> ABBREVIATIONS BIT CONC. BITUMINOUS CONCRETE PAVEMENT CAPE COD BERM EDGE OF PAVEMENT BITUMINOUS CONCRETE CURB RET WALL RETAINING WALL CONCRETE REINFORCED CONCRETE PIPE VERTICAL GRANITE CURB

EDGE OF TRAVEL WAY

VERTICAL CONCRETE CURB

CORRUGATED METAL PIPE

THRESHOLD ELEVATION

METAL BERM

REVISIONS

UTH,

_

Z

| ARCHITECT

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LANDSCAPE

SUITE #201A

MDLA

202.230.1693

AND 1409 COMMERCIAL ST LLC

1 FRANKLIN STREET, UNIT 2308


150 LONGWATER DRIVE, SUITE 101

MANAGER OF 864, 909, 910 BROAD ST LLCs

MCKENZIE ENGINEERING GROUP

O: 617.765.8000

OWNER

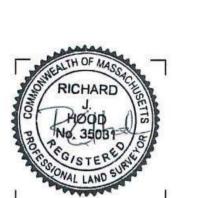


DRAWING INFORMATION NOI PLAN REVIEW SEPTEMBER 6, 2023

PROJECT #: 22034 1" = 20'

> DRAWING TITLE EXISTING CONDITIONS

DRAWING NUMBER

PLAN

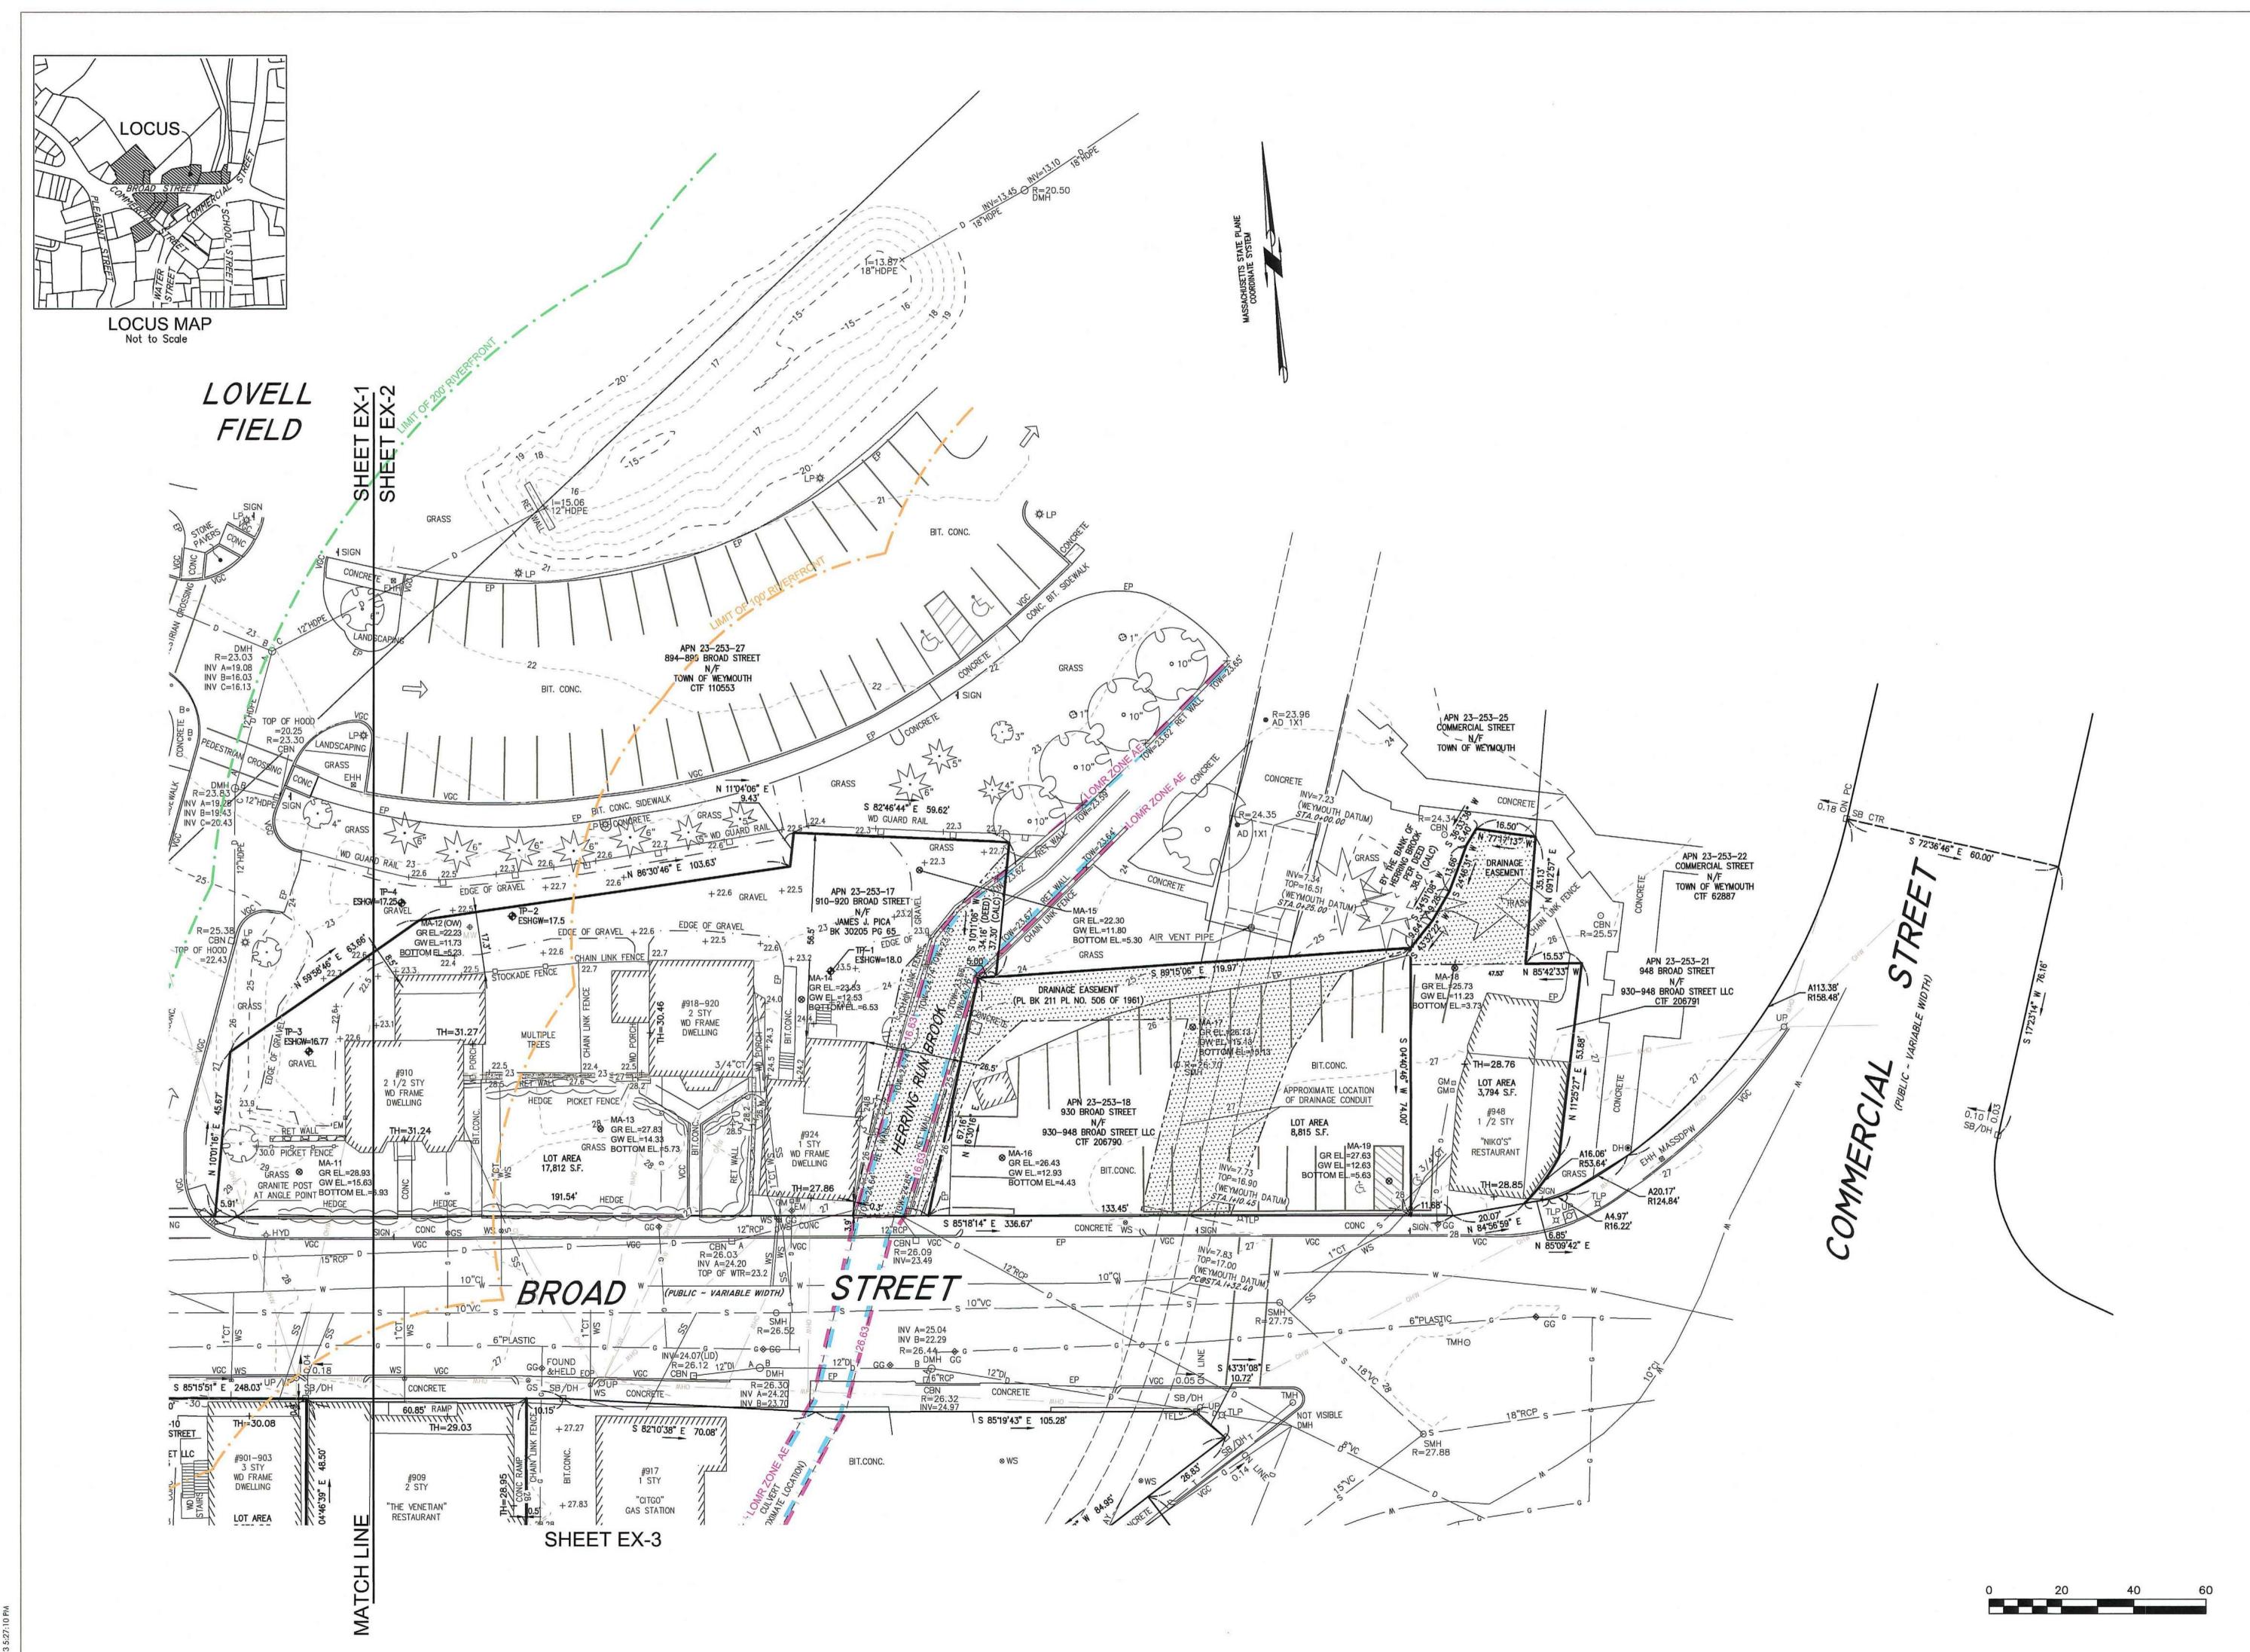

| ARCHITECT

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IRAKLIS N PAPACHRISTOS, MANAGER OF 864, 909, 910 BROAD ST LLCs AND 1409 COMMERCIAL ST LLC 1 FRANKLIN STREET, UNIT 2308 BOSTON, MA 02110 202,230.1693

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MCKENZIE ENGINEERING GROUP 150 LONGWATER DRIVE, SUITE 101 NORWELL, MA 02061 781.792.3900

840 SUMMER STREET SUITE #201A BOSTON, MA 02127

REVISIONS


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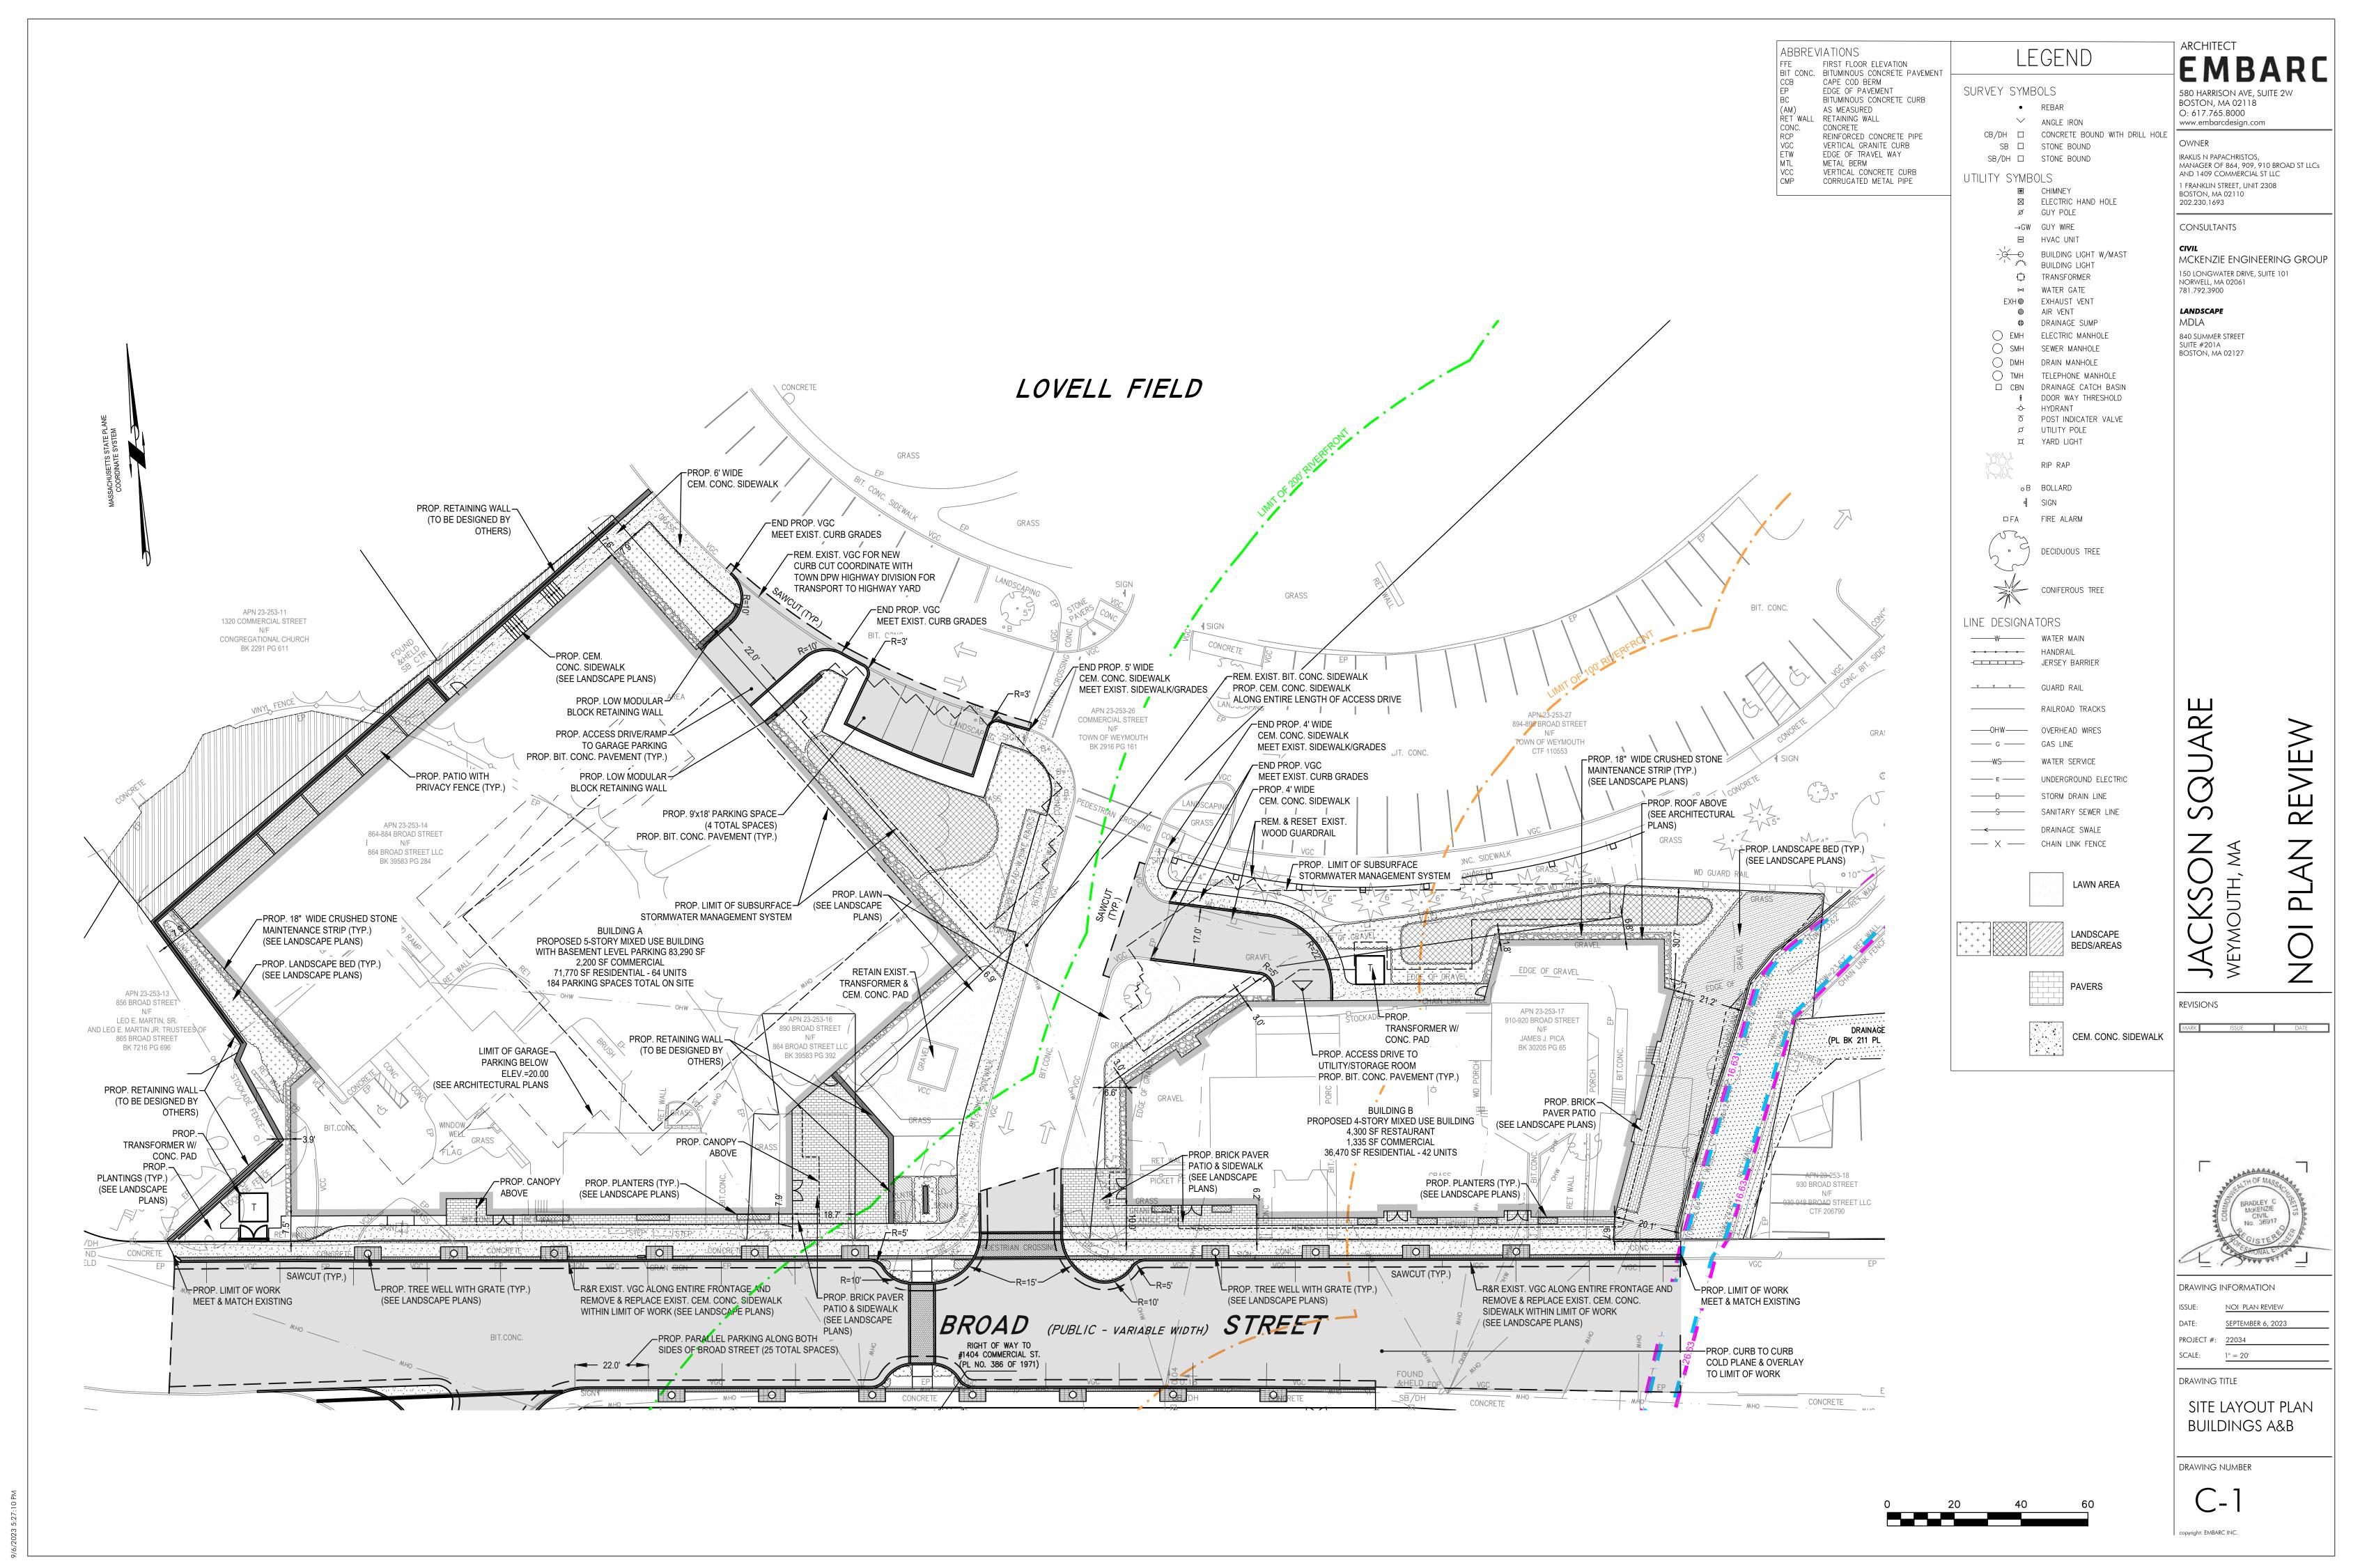
PROJECT #: 22034

DRAWING TITLE


EXISTING CONDITIONS PLAN

DRAWING NUMBER




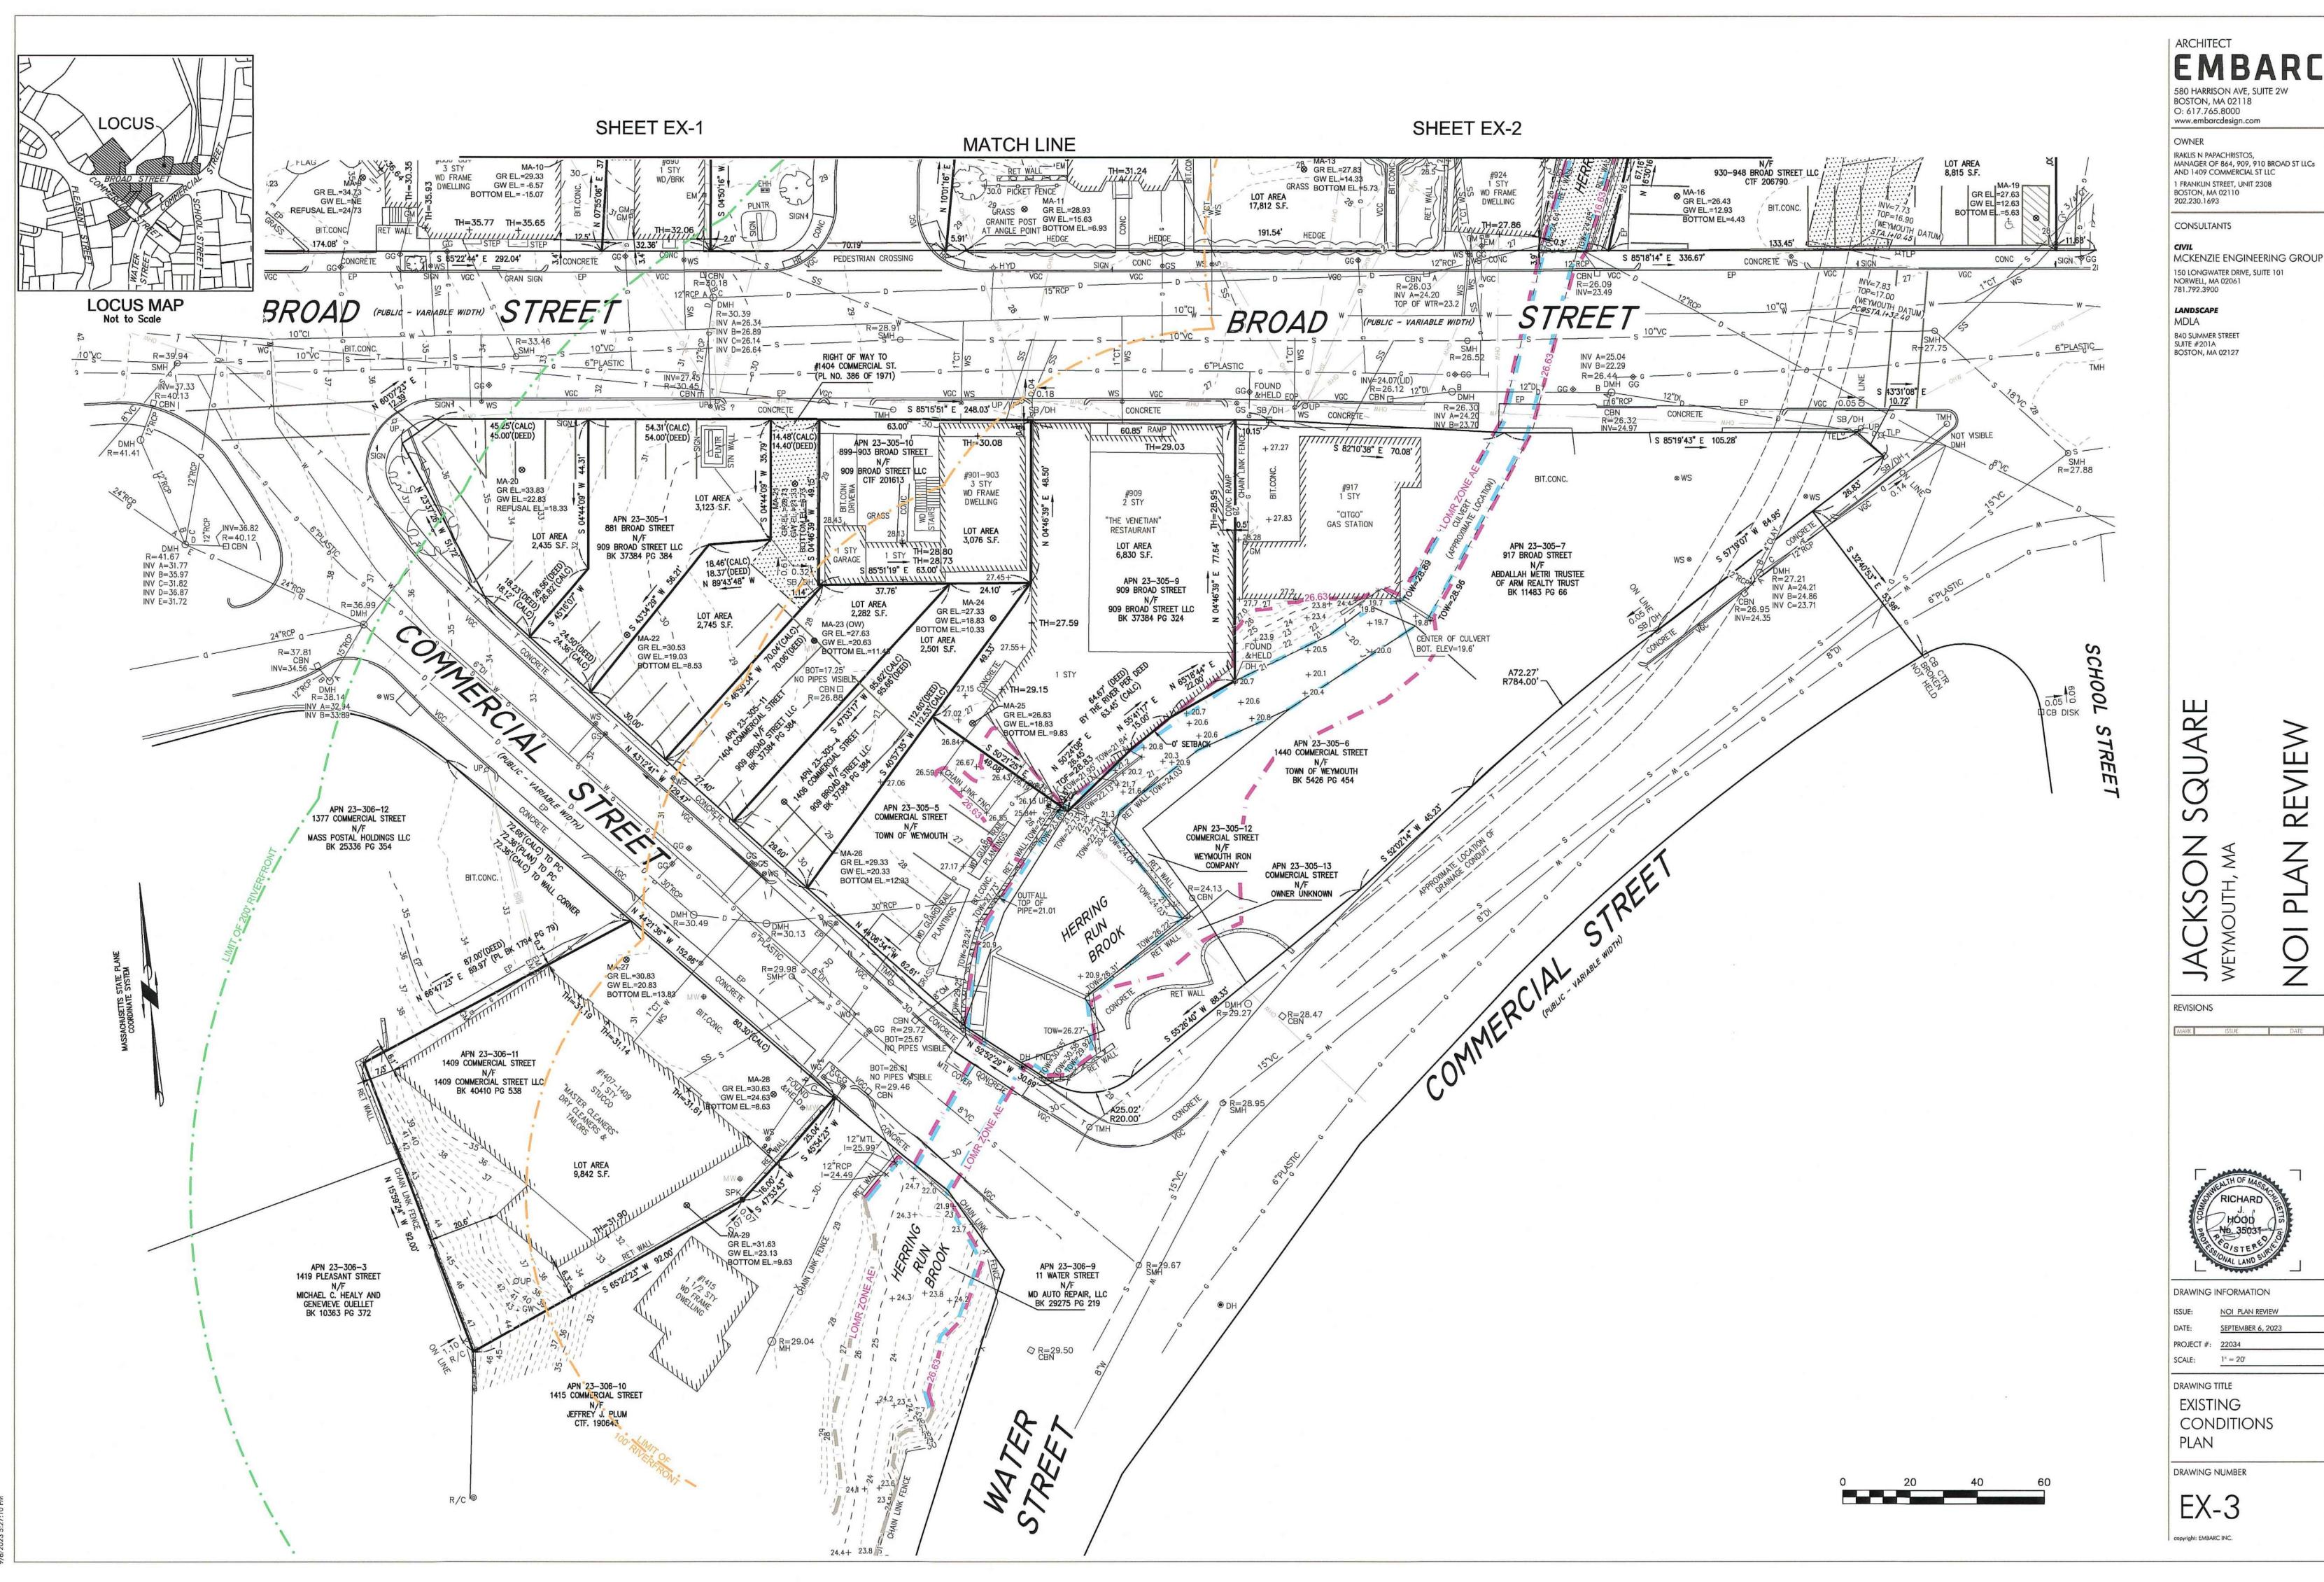


C:\Users\tloranger\Documents\22034_Jackson Square Weymouth_tloran

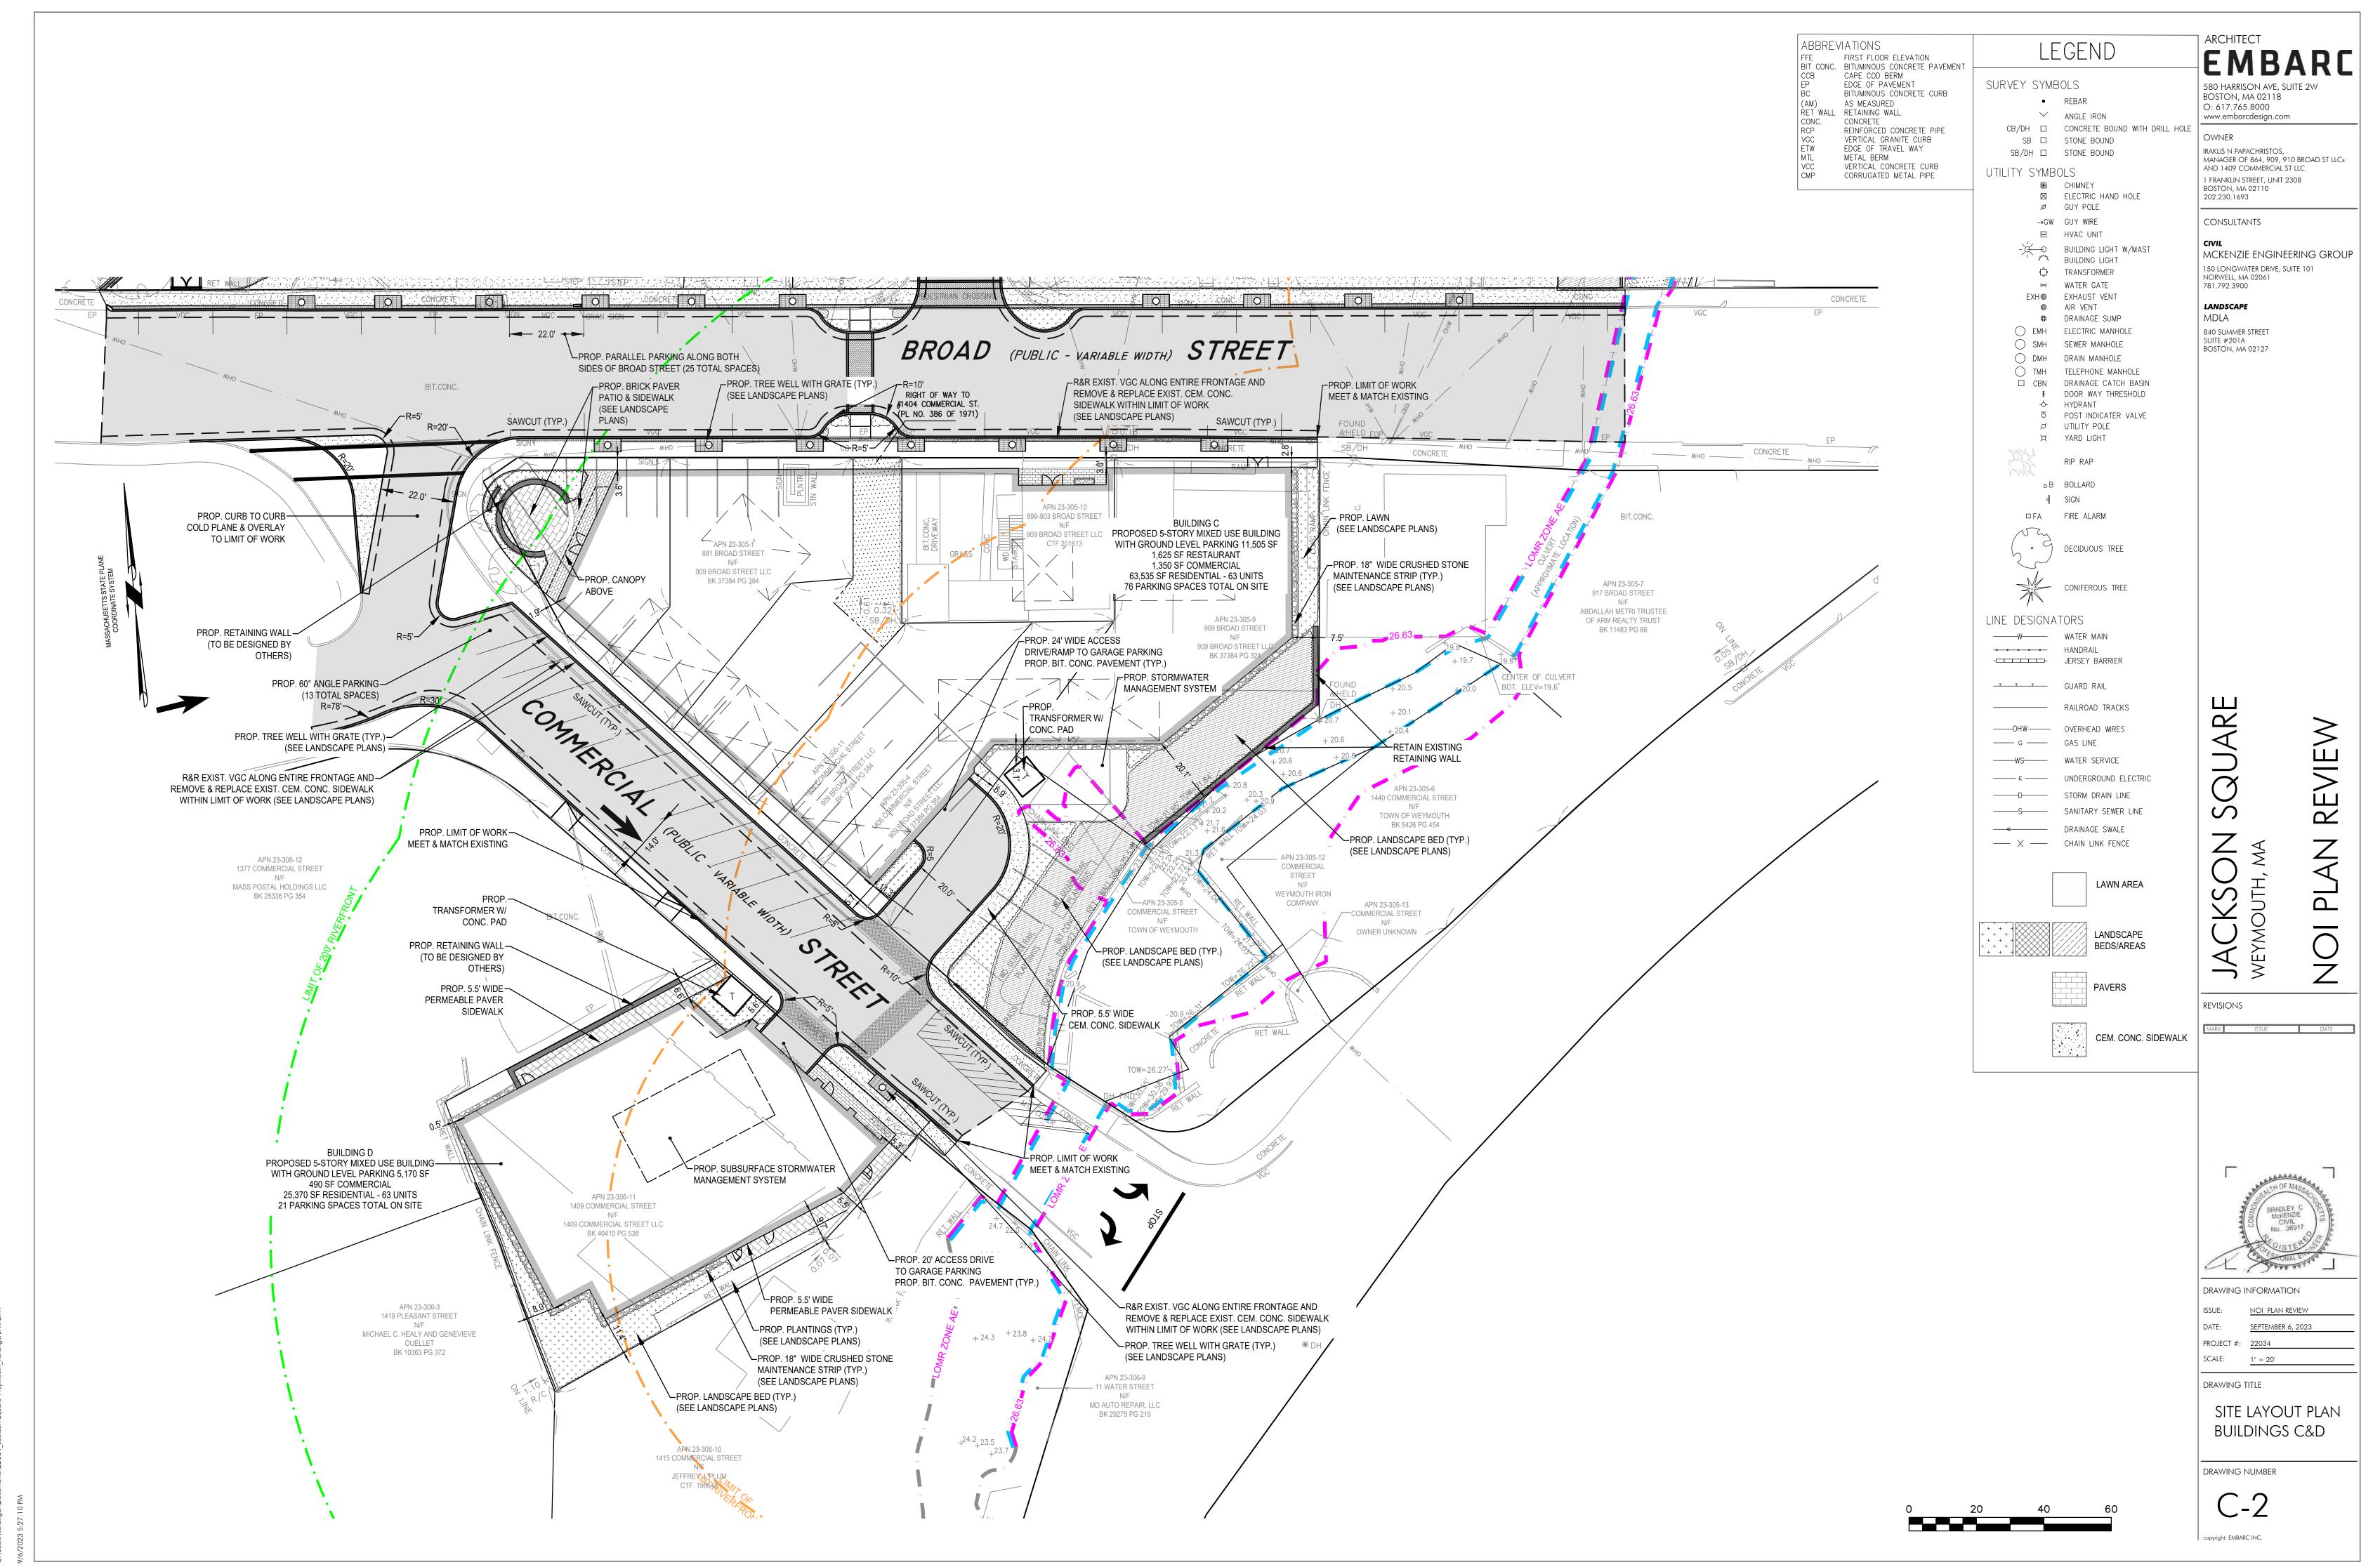



C:\Users\tloranger\Documents\22034_Jackson Square Weymouth_tlor

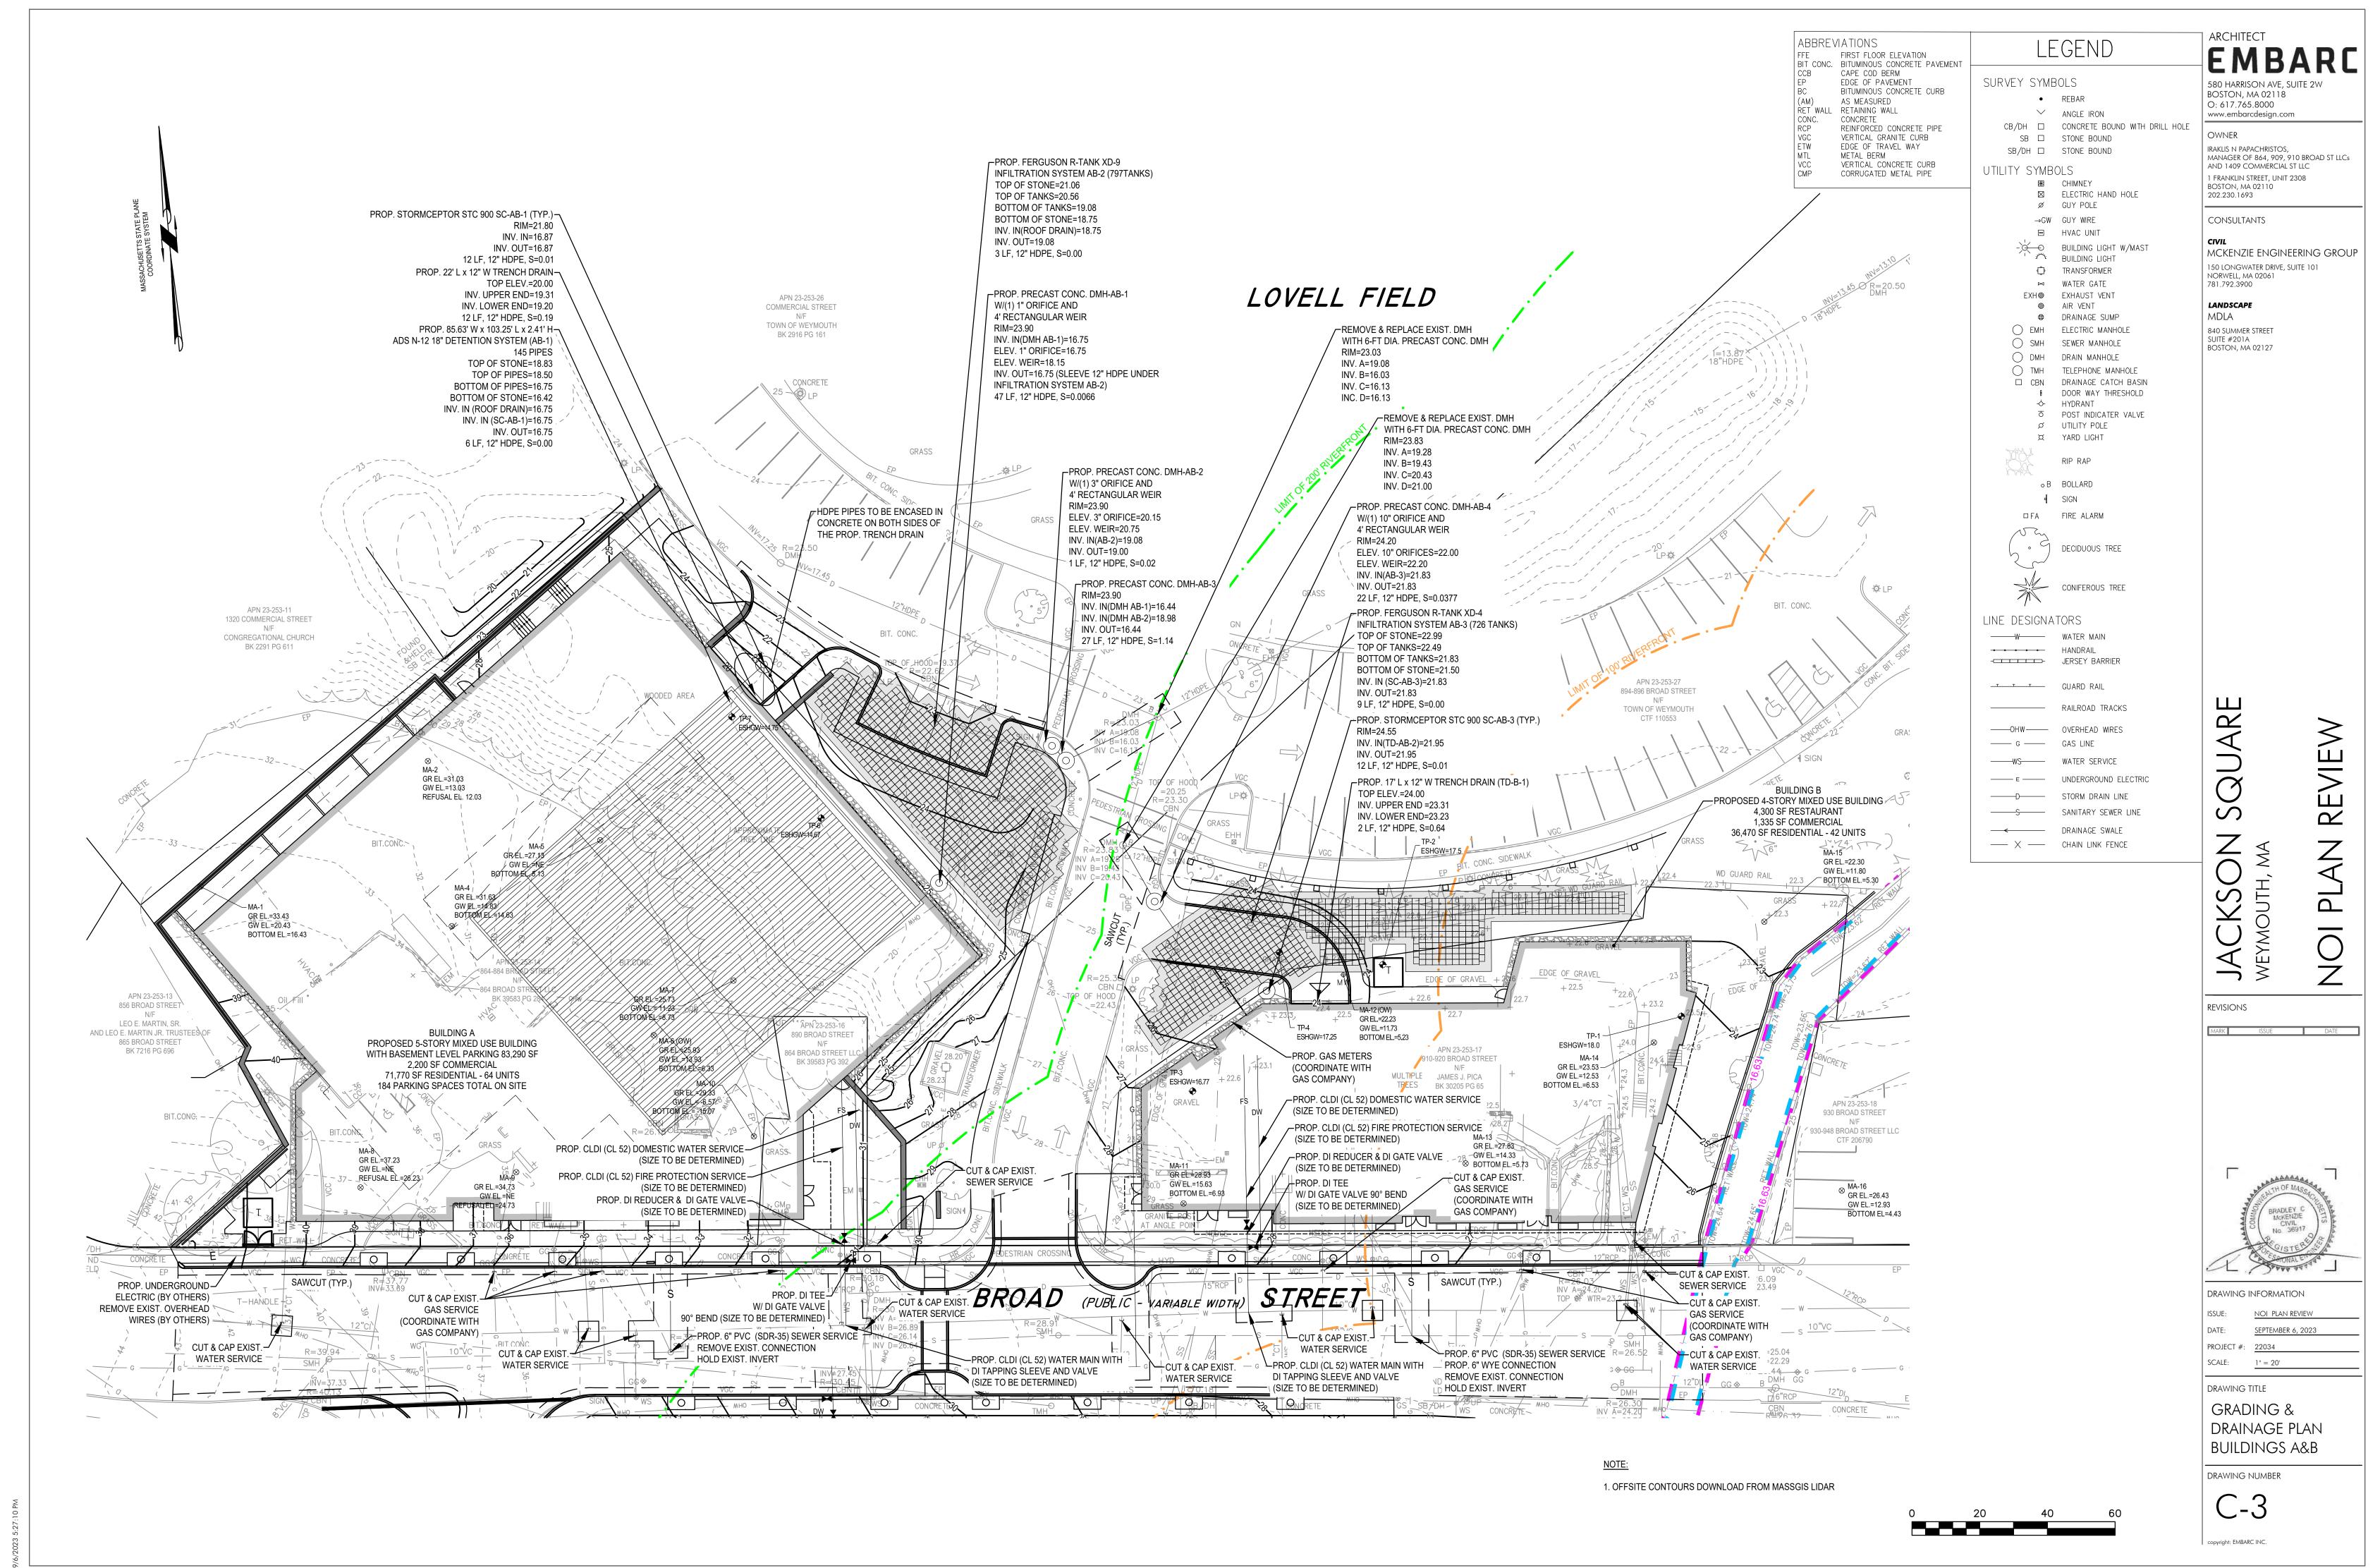


\Users\tloranger\Documents\22034_Jackson Square Weymouth_tloran

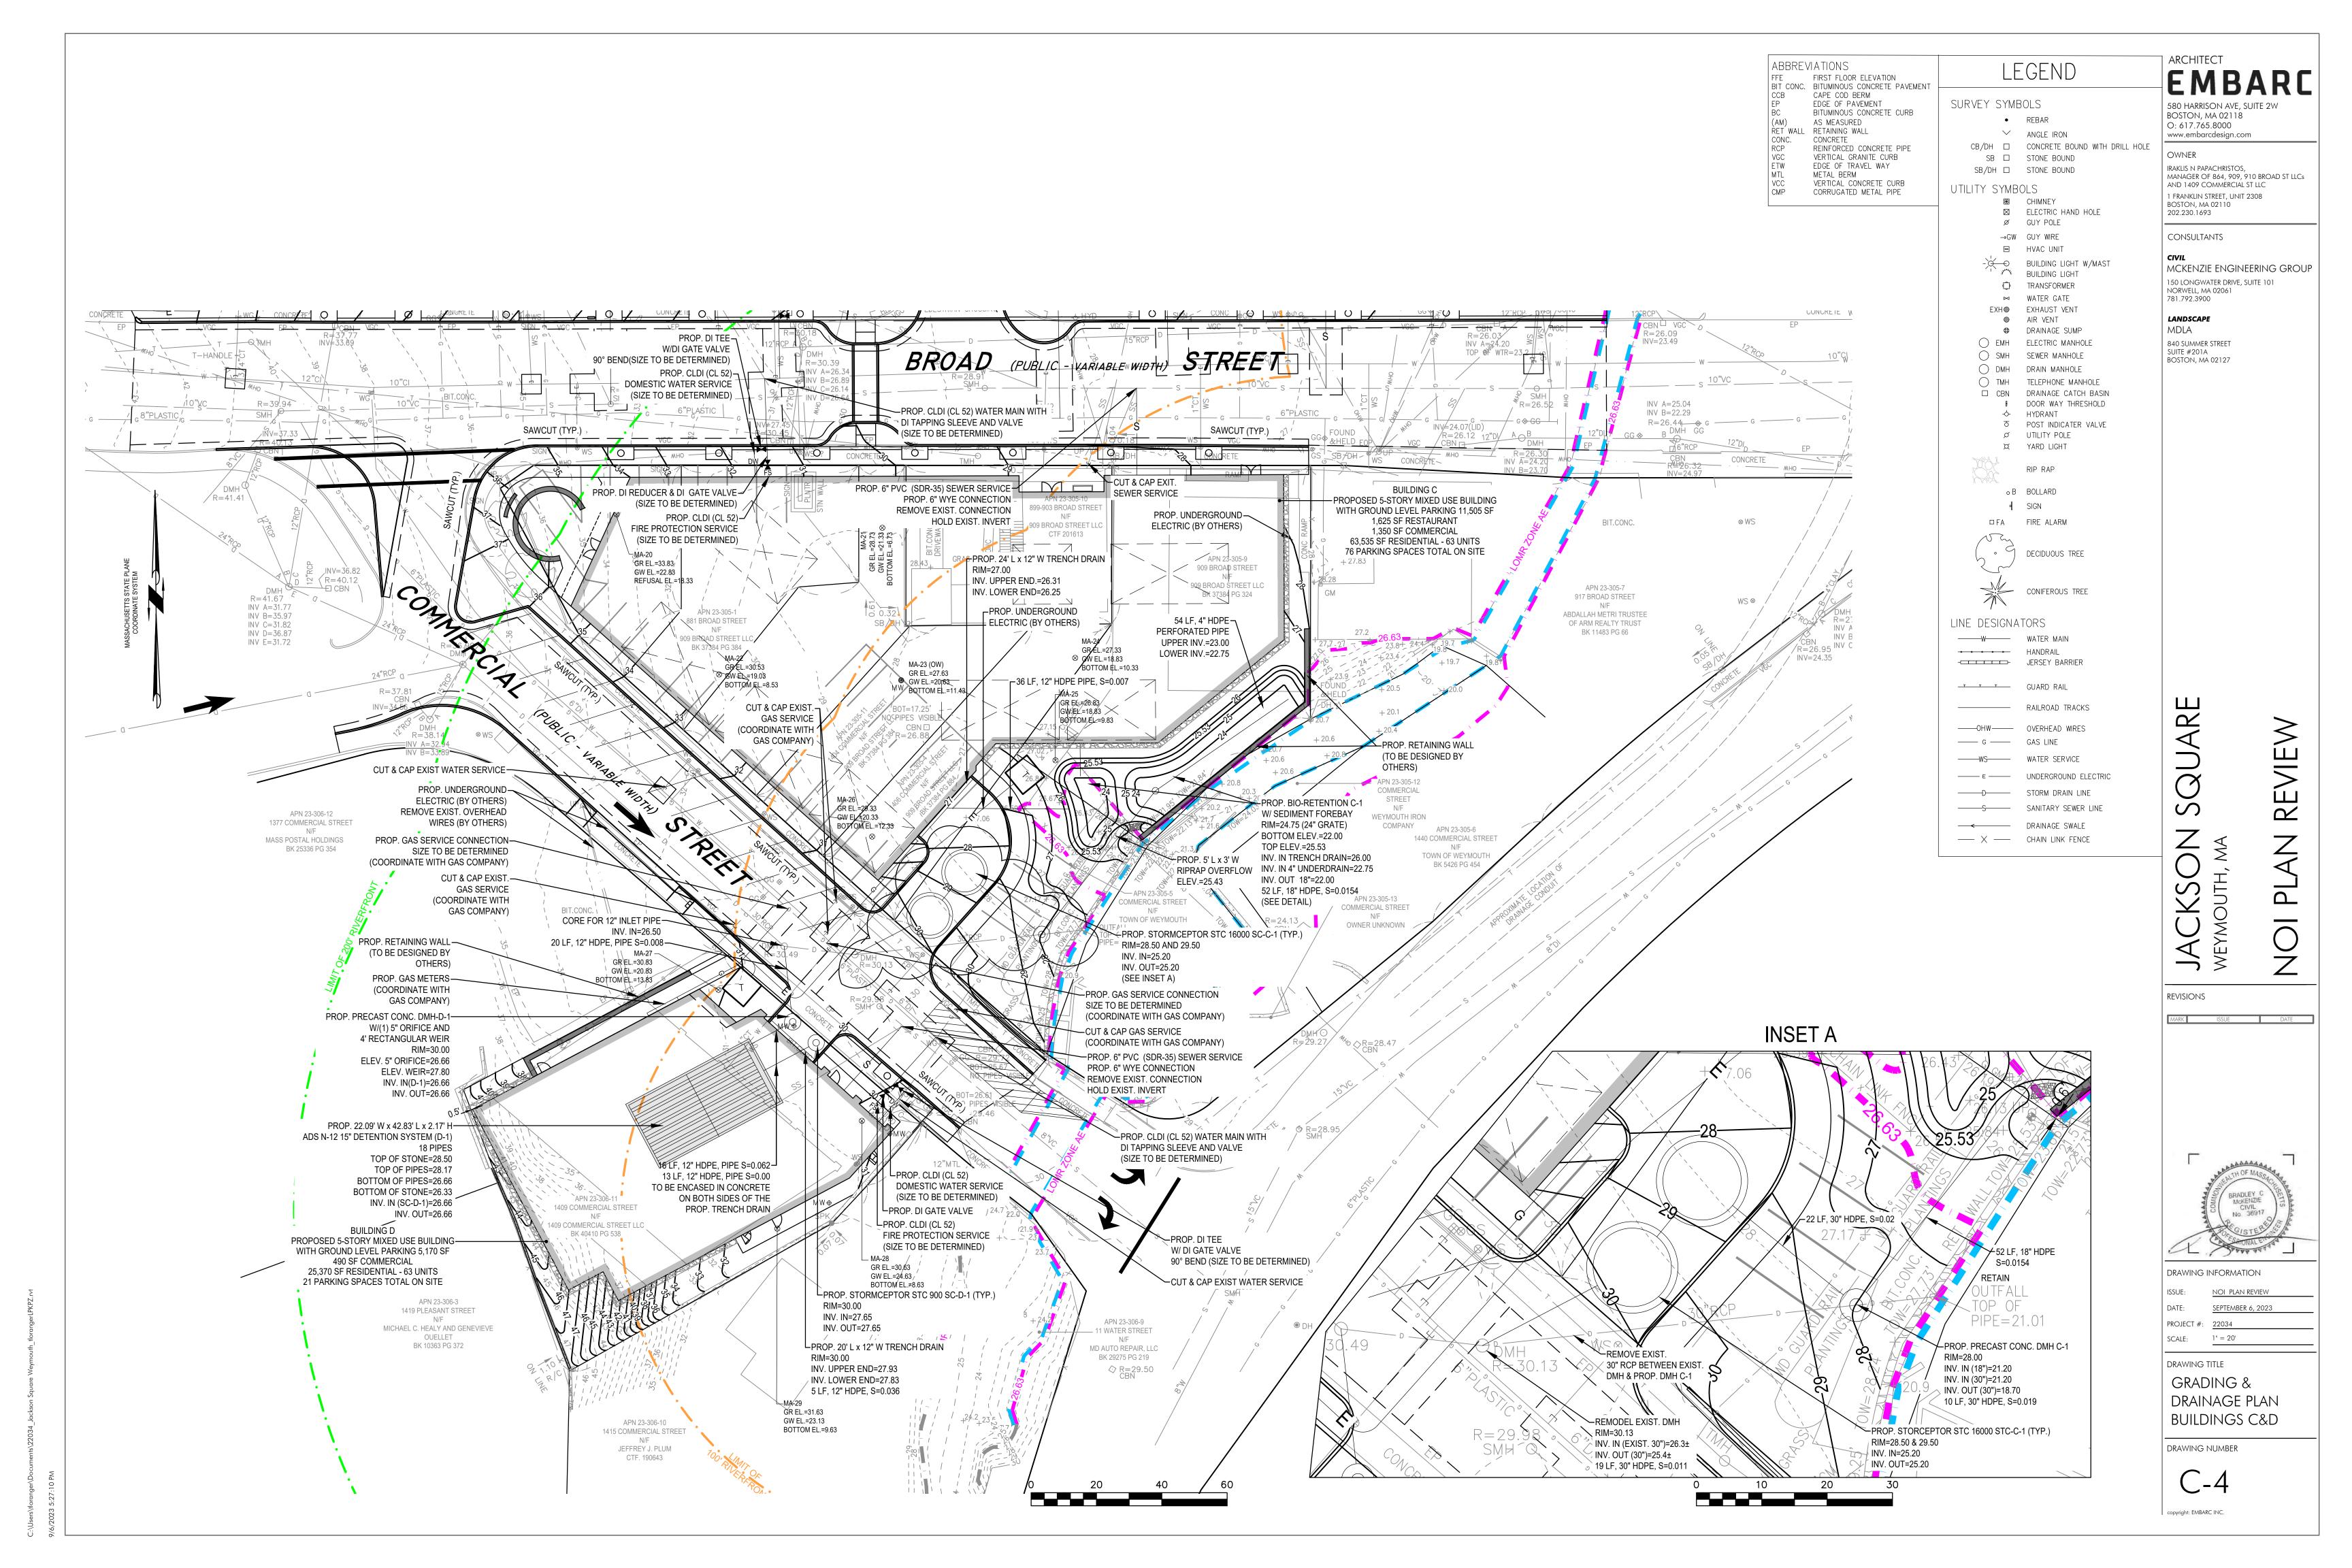


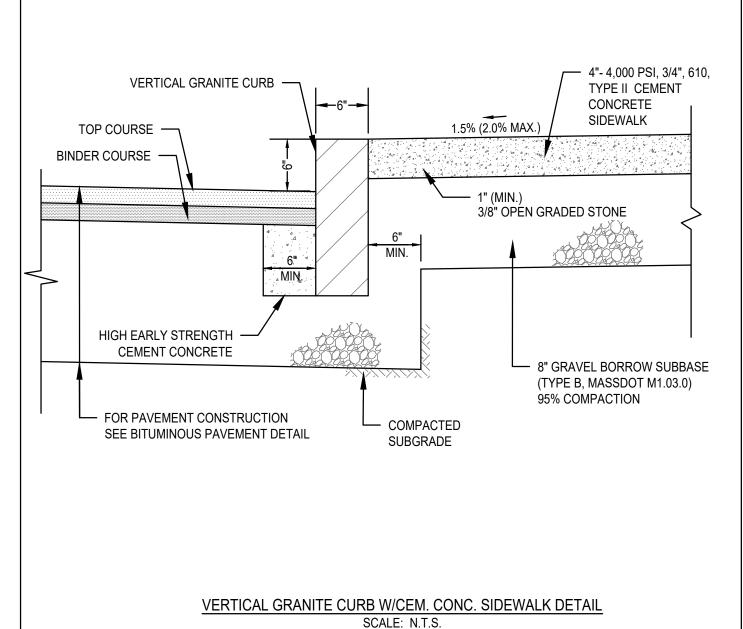


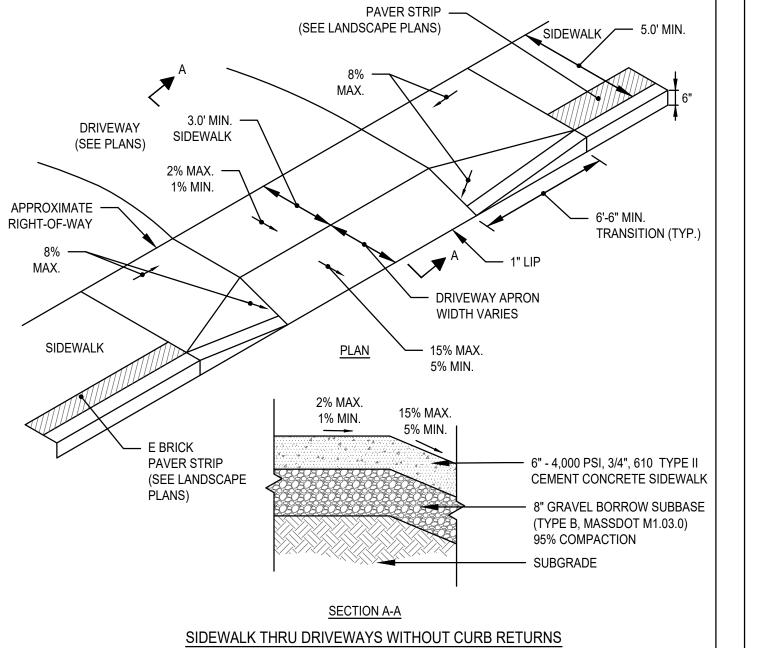

SCALE: N.T.S.

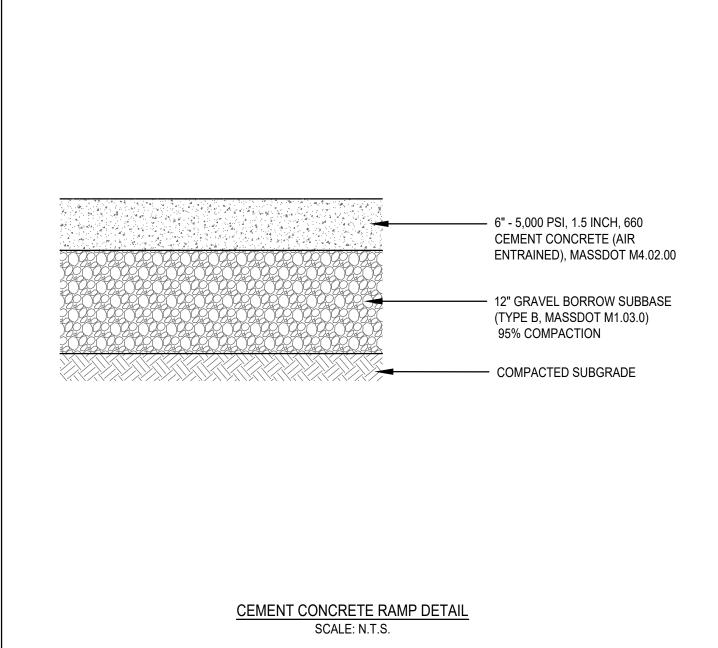

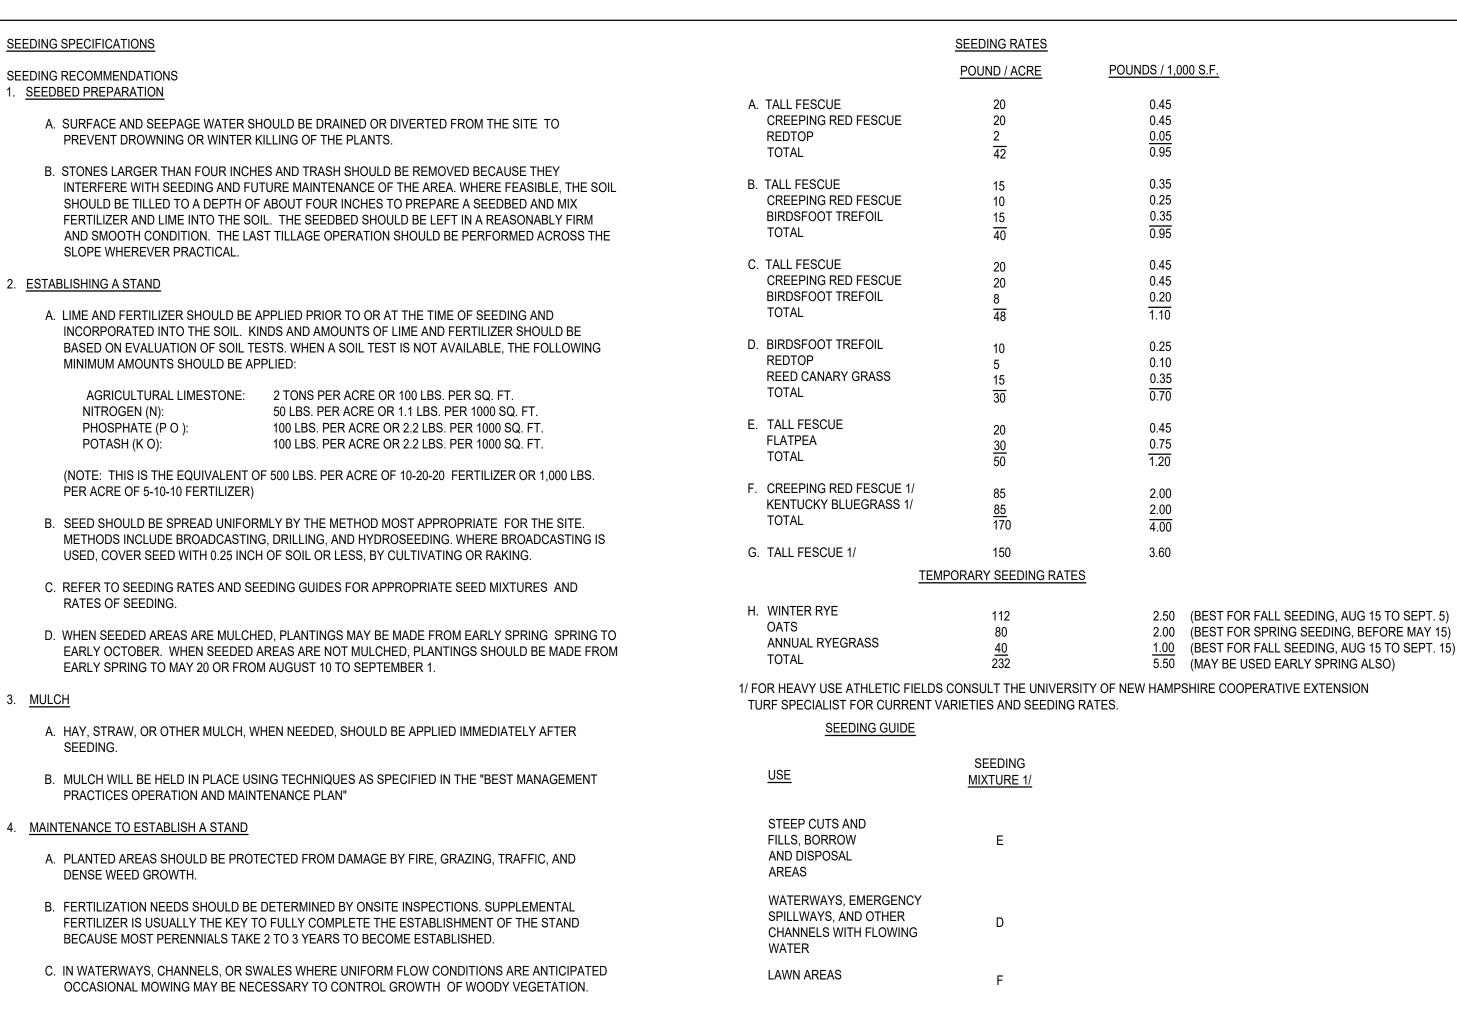


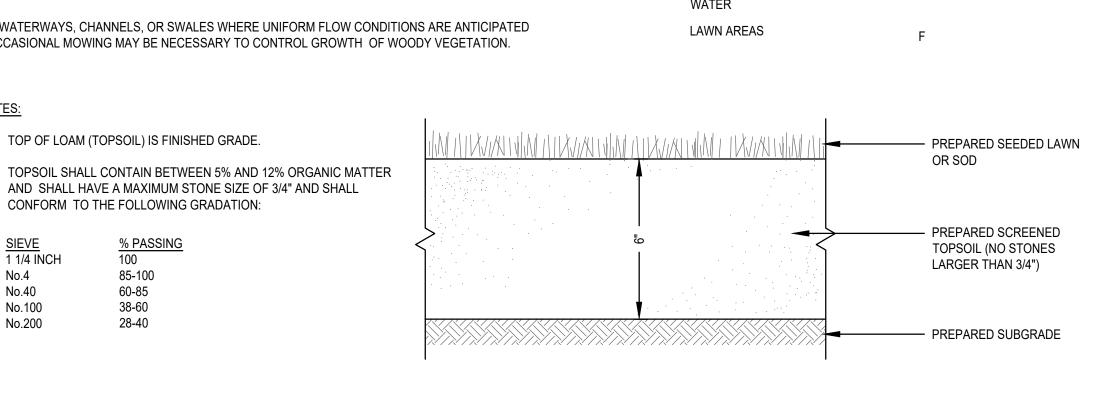



SEEDED OR SODDED LAWN DETAIL

SCALE: N.T.S.

CURB/EDGE OF PAVEMENT

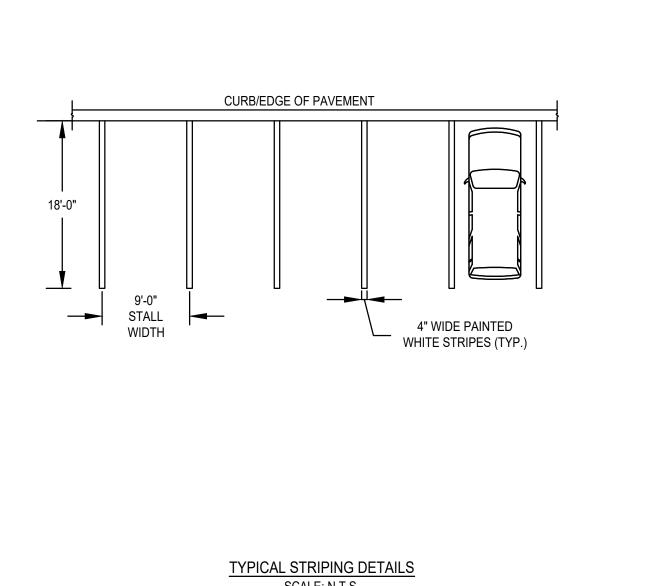

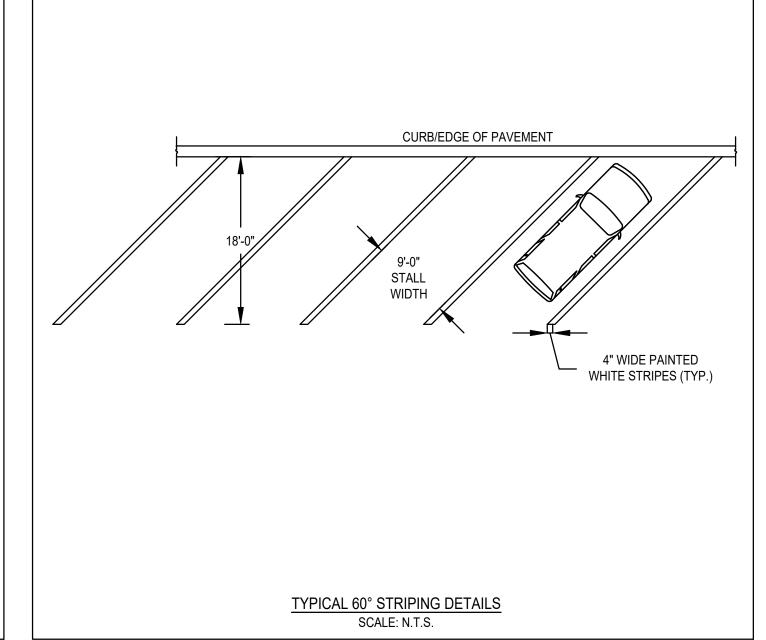

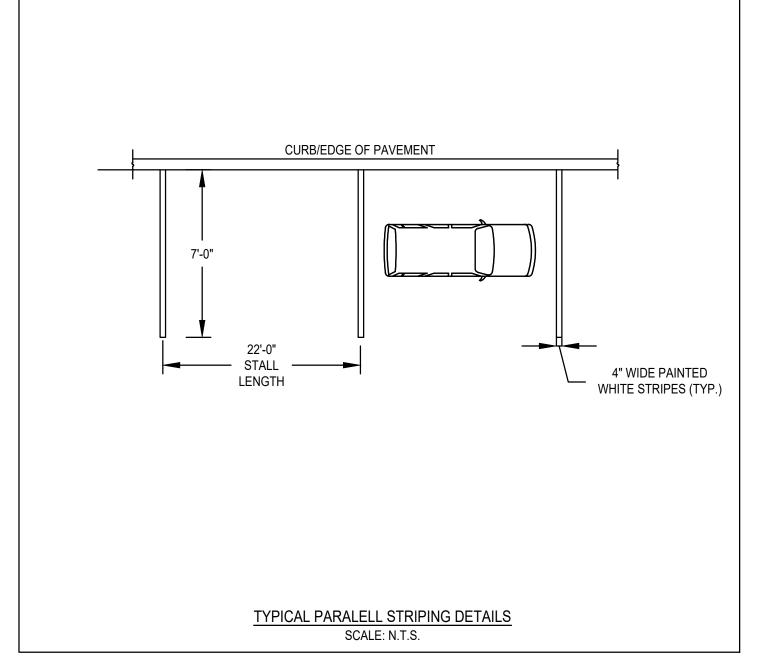

1. TOP OF LOAM (TOPSOIL) IS FINISHED GRADE.

1 1/4 INCH

No.4

No.40

No.100

No.200


CONFORM TO THE FOLLOWING GRADATION:

85-100 60-85

38-60

28-40

AND SHALL HAVE A MAXIMUM STONE SIZE OF 3/4" AND SHALL

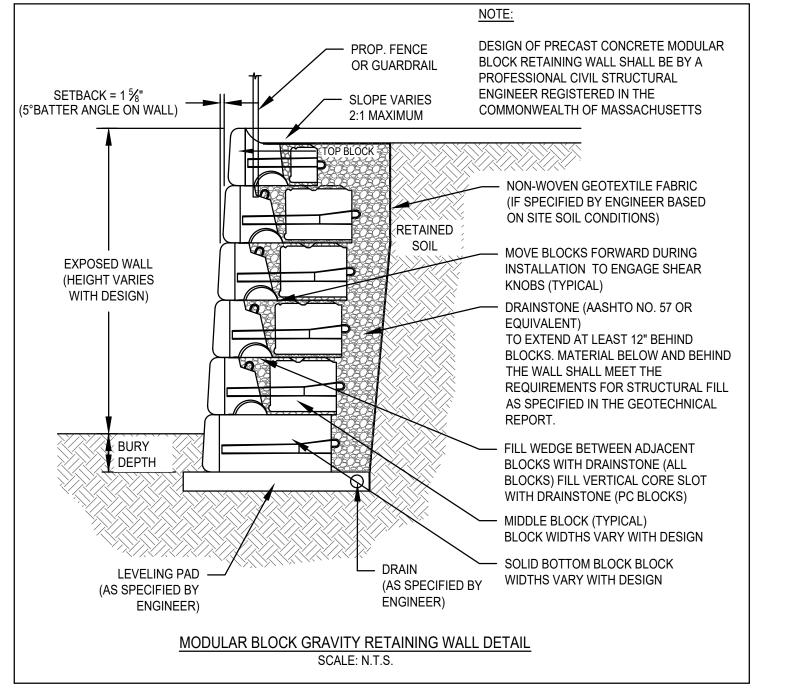

| ARCHITECT

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OWNER IRAKLIS N PAPACHRISTOS, MANAGER OF 864, 909, 910 BROAD ST LLCs AND 1409 COMMERCIAL ST LLC 1 Franklin Street, Unit 2308 BOSTON, MA 02110

CONSULTANTS

202.230.1693

MCKENZIE ENGINEERING GROUP 150 LONGWATER DRIVE, SUITE 101 NORWELL, MA 02061

LANDSCAPE MDLA 840 SUMMER STREET

781.792.3900

SUITE #201A

BOSTON, MA 02127

1.00 (BEST FOR FALL SEEDING, AUG 15 TO SEPT. 15)

5.50 (MAY BE USED EARLY SPRING ALSO)

REVISIONS

DRAWING INFORMATION NOI PLAN REVIEW SEPTEMBER 6, 2023

PROJECT #: 22034

NOT TO SCALE DRAWING TITLE

CONSTRUCTION DETAILS

DRAWING NUMBER

- THE CONTRACTOR IS SPECIFICALLY CAUTIONED THAT THE LOCATION AND/OR ELEVATION OF EXISTING UTILITIES.
- THE CONTRACTOR SHALL BE RESPONSIBLE FOR ESTABLISHING AND MAINTAINING ALL CONTROL POINTS AND BENCHMARKS NECESSARY FOR THE WORK.
- THE CONTRACTOR SHALL EXCAVATE TEST PITS PRIOR TO INSTALLING THE WATER SERVICE TO VERIFY THE SIZE, ELEVATIONS AND LOCATIONS OF EXISTING UTILITIES. THE CONTRACTOR SHALL PROVIDE THE OWNER AND ENGINEER WITH THE RESULTS PRIOR TO COMMENCING ANY WORK.
- THE CONTRACTOR SHALL EXCAVATE TEST PITS AT THE PROPOSED UTILITY CONNECTION LOCATIONS SHOWN ON THE PLAN PRIOR TO COMMENCING WORK TO VERIFY THE ELEVATIONS AND LOCATIONS OF EXISTING UTILITIES. THE CONTRACTOR SHALL PROVIDE THE OWNER AND ENGINEER WITH THE RESULTS PRIOR TO COMMENCING ANY
- ALL WATER SERVICES SHALL BE INSTALLED WITH 5' OF COVER EXCEPT AS NOTED OR DETAILED OTHERWISE.
- THE FIRE SERVICE SHALL BE CEMENT LINED DUCTILE IRON PIPE (C.L.D.I.) AND SHALL BE INSTALLED WITH APPROPRIATELY SIZED GATE VALVES AND BOXES.
- ALL WATER AND FIRE SERVICE APPURTENANCES, MATERIALS, METHODS OF INSTALLATION SHALL MEET OR EXCEED ALL LOCAL MUNICIPAL REQUIREMENTS.
- THE DOMESTIC WATER SERVICE SHALL BE ADEQUATELY PROTECTED AGAINST BACKFLOW (BACKFLOW
- AFTER PRESSURE TESTING AND CHLORINATION IS COMPLETED, SAMPLES SHALL BE TAKEN FROM THE DOMESTIC WATER SERVICE AND SHALL BE TESTED AT 200 PSI FOR A MINIMUM OF 2 HOURS. THE CONTRACTOR IS REQUIRED TO NOTIFY THE SALISBURY DEPARTMENT OF PUBLIC WORKS AT LEAST 24 HOURS PRIOR TO THE TESTING.
- THE DOMESTIC WATER SERVICE SHALL BE TESTED IN ACCORDANCE WITH DEPARTMENT OF ENVIRONMENTAL PROTECTION REGULATIONS. A MINIMUM OF 2 SEPARATE WATER SAMPLES SHALL BE TESTED AT A STATE CERTIFIED LABORATORY.
- A MINIMUM OF 10 FEET CLEAR HORIZONTALLY SHALL BE MAINTAINED BETWEEN SANITARY SEWER SERVICES AND WATER SERVICES. WHENEVER CONDITIONS PREVENT A LATERAL SEPARATION OF 10 FEET TO A WATER SERVICE. THE ELEVATION OF THE CROWN OF THE SEWER SHALL BE AT LEAST 18 INCHES BELOW THE INVERT OF THE
- 12. ALL GRAVITY SEWER PIPE SHALL BE POLYVINYL CHLORIDE (PVC) SDR-35 UNLESS OTHERWISE NOTED.
- WHERE SANITARY SEWERS CROSS WATER MAINS, THE SEWER SHALL BE LAID AT SUCH AN ELEVATION THAT THE CROWN OF THE SEWER IS AT LEAST 18 INCHES BELOW THE INVERT OF THE WATER MAIN. IF THE ELEVATION OF THE SEWER CANNOT BE VARIED TO MEET THIS REQUIREMENT, THE WATER MAIN SHALL BE RELOCATED TO PROVIDE THIS SEPARATION OR CONSTRUCTED WITH MECHANICAL-JOINT PIPE FOR A DISTANCE OF 10 FEET ON EACH SIDE OF THE SEWER. ONE FULL LENGTH OF WATER MAIN SHALL BE CENTERED OVER THE SEWER SO THAT BOTH JOINTS WILL BE AS FAR FROM THE SEWER AS POSSIBLE. WHENEVER IT IS IMPOSSIBLE TO OBTAIN VERTICAL SEPARATION AS STIPULATED ABOVE, BOTH THE WATER MAIN AND THE SEWER MAIN SHALL BE ENCASED IN CONCRETE FOR A MINIMUM DISTANCE OF 10 FEET FROM THE CROSSING POINT OF THE OTHER PIPE AS MEASURED NORMALLY FROM ALL POINTS ALONG THE PIPE.
- THE LOCATIONS OF PROPOSED ELECTRIC, TELEPHONE AND COMMUNICATION (E.T.C.) SERVICES ARE APPROXIMATE. THE PROJECT ELECTRICAL ENGINEER SHALL VERIFY THESE LOCATIONS PRIOR TO THE START OF CONSTRUCTION. COORDINATE ALL E.T.C. WORK WITH THE APPROPRIATE UTILITY COMPANIES.
- ALL WORK WITHIN THE STATE HIGHWAY LAYOUT SHALL BE PERFORMED IN ACCORDANCE WITH MASSACHUSETTS DEPARTMENT OF PUBLIC WORKS SPECIFICATIONS.

STANDARD DUCTILE IRON — GRATE #EG14161DIA TOP OF GRATE ELEV.=XX

ECONODRAIN® SERIES #12 -

ADD REBAR AS REQUIRED.

EXPANSION /

CONTRACTION

TRENCH SYSTEM

- IF THE NEED FOR EXCAVATION DEWATERING ARISES DURING THE CONSTRUCTION PROCESS A DEWATERING FILTER PIT SHALL BE CONSTRUCTED IN ACCORDANCE WITH APPROPRIATE STORMWATER MANAGEMENT AND ENGINEERING PRACTICES.
- WORK ASSOCIATED WITH THE RETIREMENT OF EXISTING NATURAL GAS SERVICES AND CONSTRUCTION OF NEW SERVICES SHALL BE COORDINATED WITH NATIONAL GRID.

12" NOM

MONOLITHIC POUR INSTALLATION DETAIL

2. SPECIFY REQUIRED DIMENSIONS (LABELED WITH *) USING 6" EACH SIDE OF STEEL

4. EXPANSION / CONTRACTION JOINT PER LOCAL ENGINEERING REGULATIONS AND

FRAME AND BELOW EPS FORM AS A RECOMMENDED MINIMUM.

3. SHOW TOP OF GRATE ELEVATION IN PLAN VIEW.


5. STANDARD CHANNEL LENGTH IS 8'-0" (96").


6. STANDARD CHANNEL SLOPE IS 0.5%.


— CLAMPING BOLT

#5 REBARS

(2) CONTINUOUS

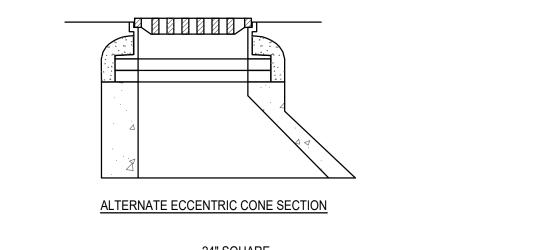

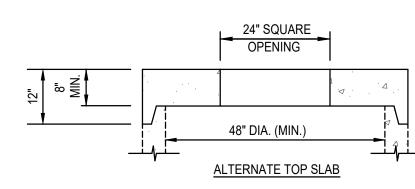

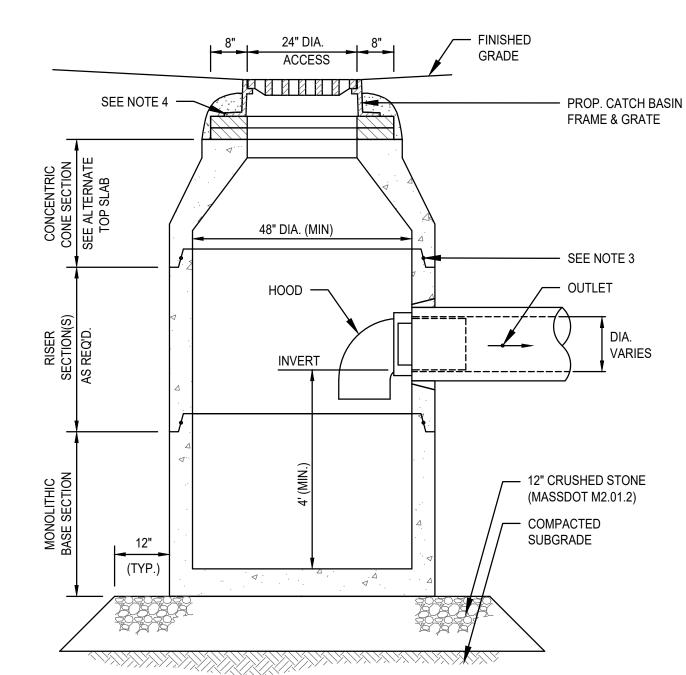

NOTES:


FLOW GPM

EPS FORM CHART

ECONODRAIN® SERIES #12 TRENCH DRAIN

SCALE: N.T.S.

- 1. ALL SECTIONS SHALL BE DESIGNED FOR HS-20 LOADING.
- 2. PROVIDE "V" KNOCKOUTS FOR PIPES WITH 2" MAX. CLEARANCE TO OUTSIDE OF PIPE. MORTAR ALL PIPE CONNECTIONS.
- 3. MORTAR ALL PIPE CONNECTIONS. JOINT SEALANT BETWEEN PRECAST SECTIONS SHALL BE PREFORMED BUTYL RUBBER.
- 4 CATCH BASIN FRAME AND GRATE SHALL BE SET IN FULL MORTAR BED. ADJUST TO GRADE WITH CLAY BRICK AND MORTAR (2 BRICK COURSES TYPICALLY, 5 BRICK COURSES MAXIMUM).

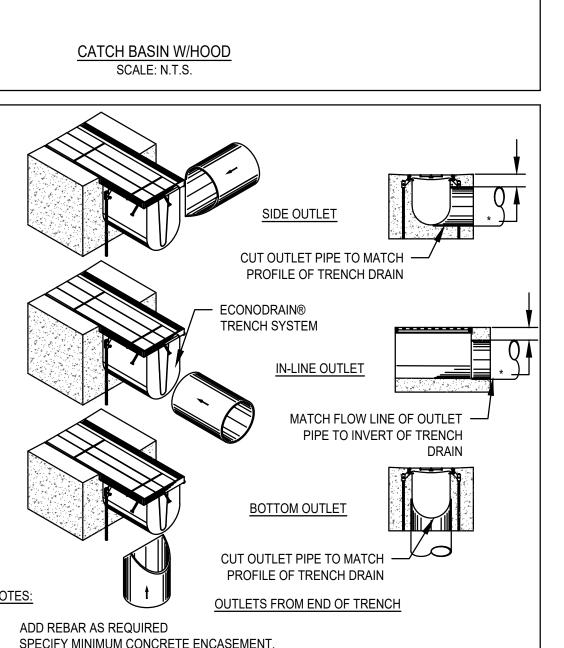


SPECIFY MINIMUM CONCRETE ENCASEMENT. 4" MINIMUM CONCRETE COVERAGE OF OUTLET PIPE IS RECOMMENDED (LABELED WITH *).

CONSTRUCTION NOTES:

INSTALLATION TO BE COMPLETE IN ACCORDANCE WITH MANUFACTURES SPECIFICATIONS. SECURE OUTLET PIPE PRIOR TO CONCRETE OPERATIONS. 3. FOR ILLUSTRATION ONLY - DO NOT SCALE

4. FINAL CONCRETE THICKNESS PER LOCAL ENGINEERING REGULATIONS AND GUIDELINES.

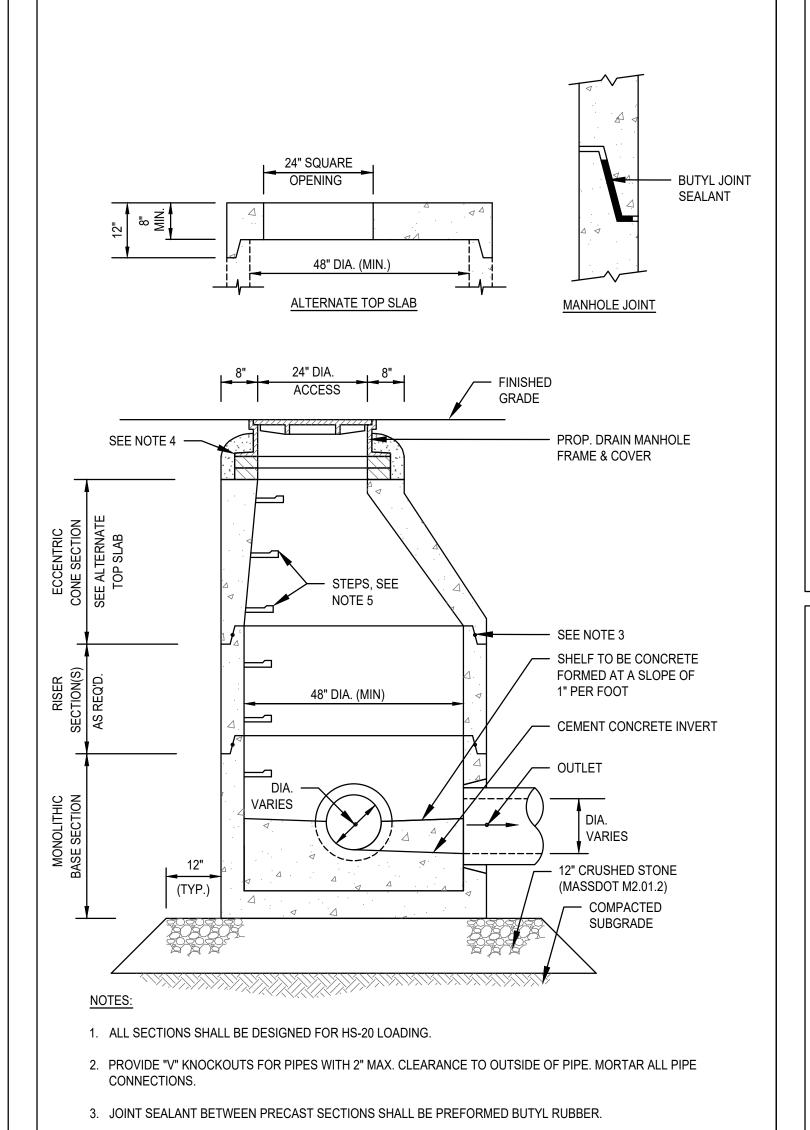

- TRENCH WIDTH AND DEPTH TO BE IN AS APPLICABLE


4. DRAIN MANHOLE FRAME AND COVER SHALL BE SET IN FULL MORTAR BED. ADJUST TO GRADE WITH CLAY

5. COPOLYMER MANHOLE STEPS SHALL BE INSTALLED AT 12" O.C. FOR THE FULL DEPTH OF THE STRUCTURE.


BRICK AND MORTAR (2 BRICK COURSES TYPICALLY, 5 BRICK COURSES MAXIMUM).

DRAIN MANHOLE DETAIL


SCALE: N.T.S.

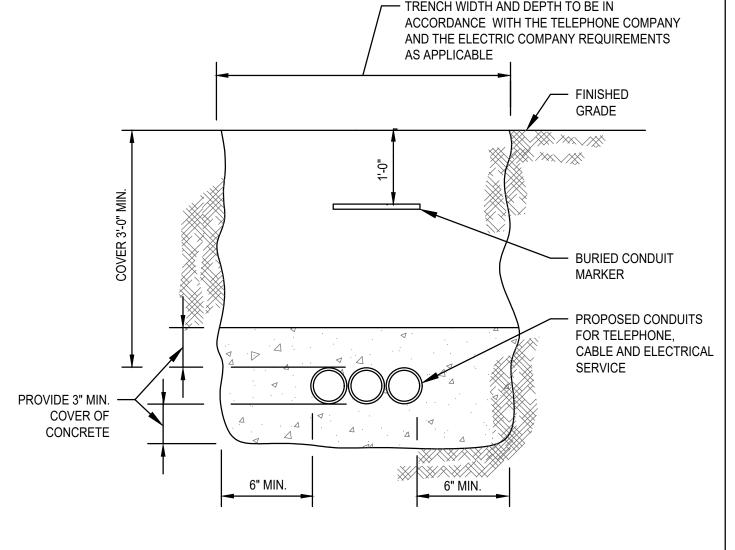

TYPICAL ELECTRIC/TELEPHONE/CABLE CONDUIT (US-UTILITY SERVICE)

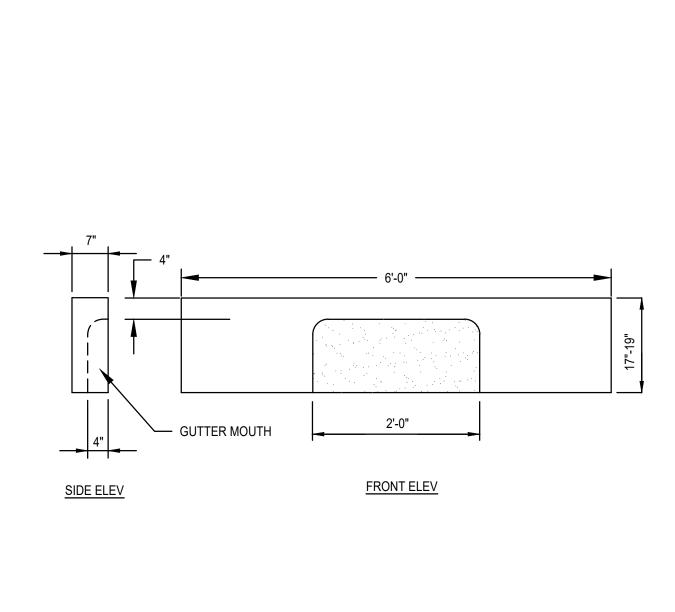

GRANITE CURB INLET SCALE: N.T.S.

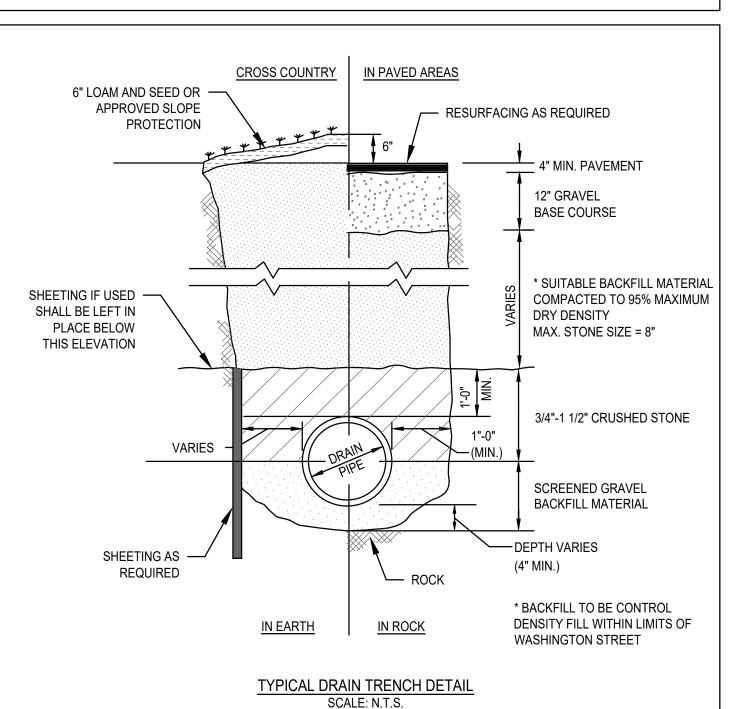

| ARCHITECT

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CONSULTANTS

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LANDSCAPE MDLA 840 SUMMER STREET SUITE #201A

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BOSTON, MA 02127

Δ_

REVISIONS




DRAWING INFORMATION SEPTEMBER 6, 2023

PROJECT #: 22034

DRAWING TITLE CONSTRUCTION DETAILS

DRAWING NUMBER

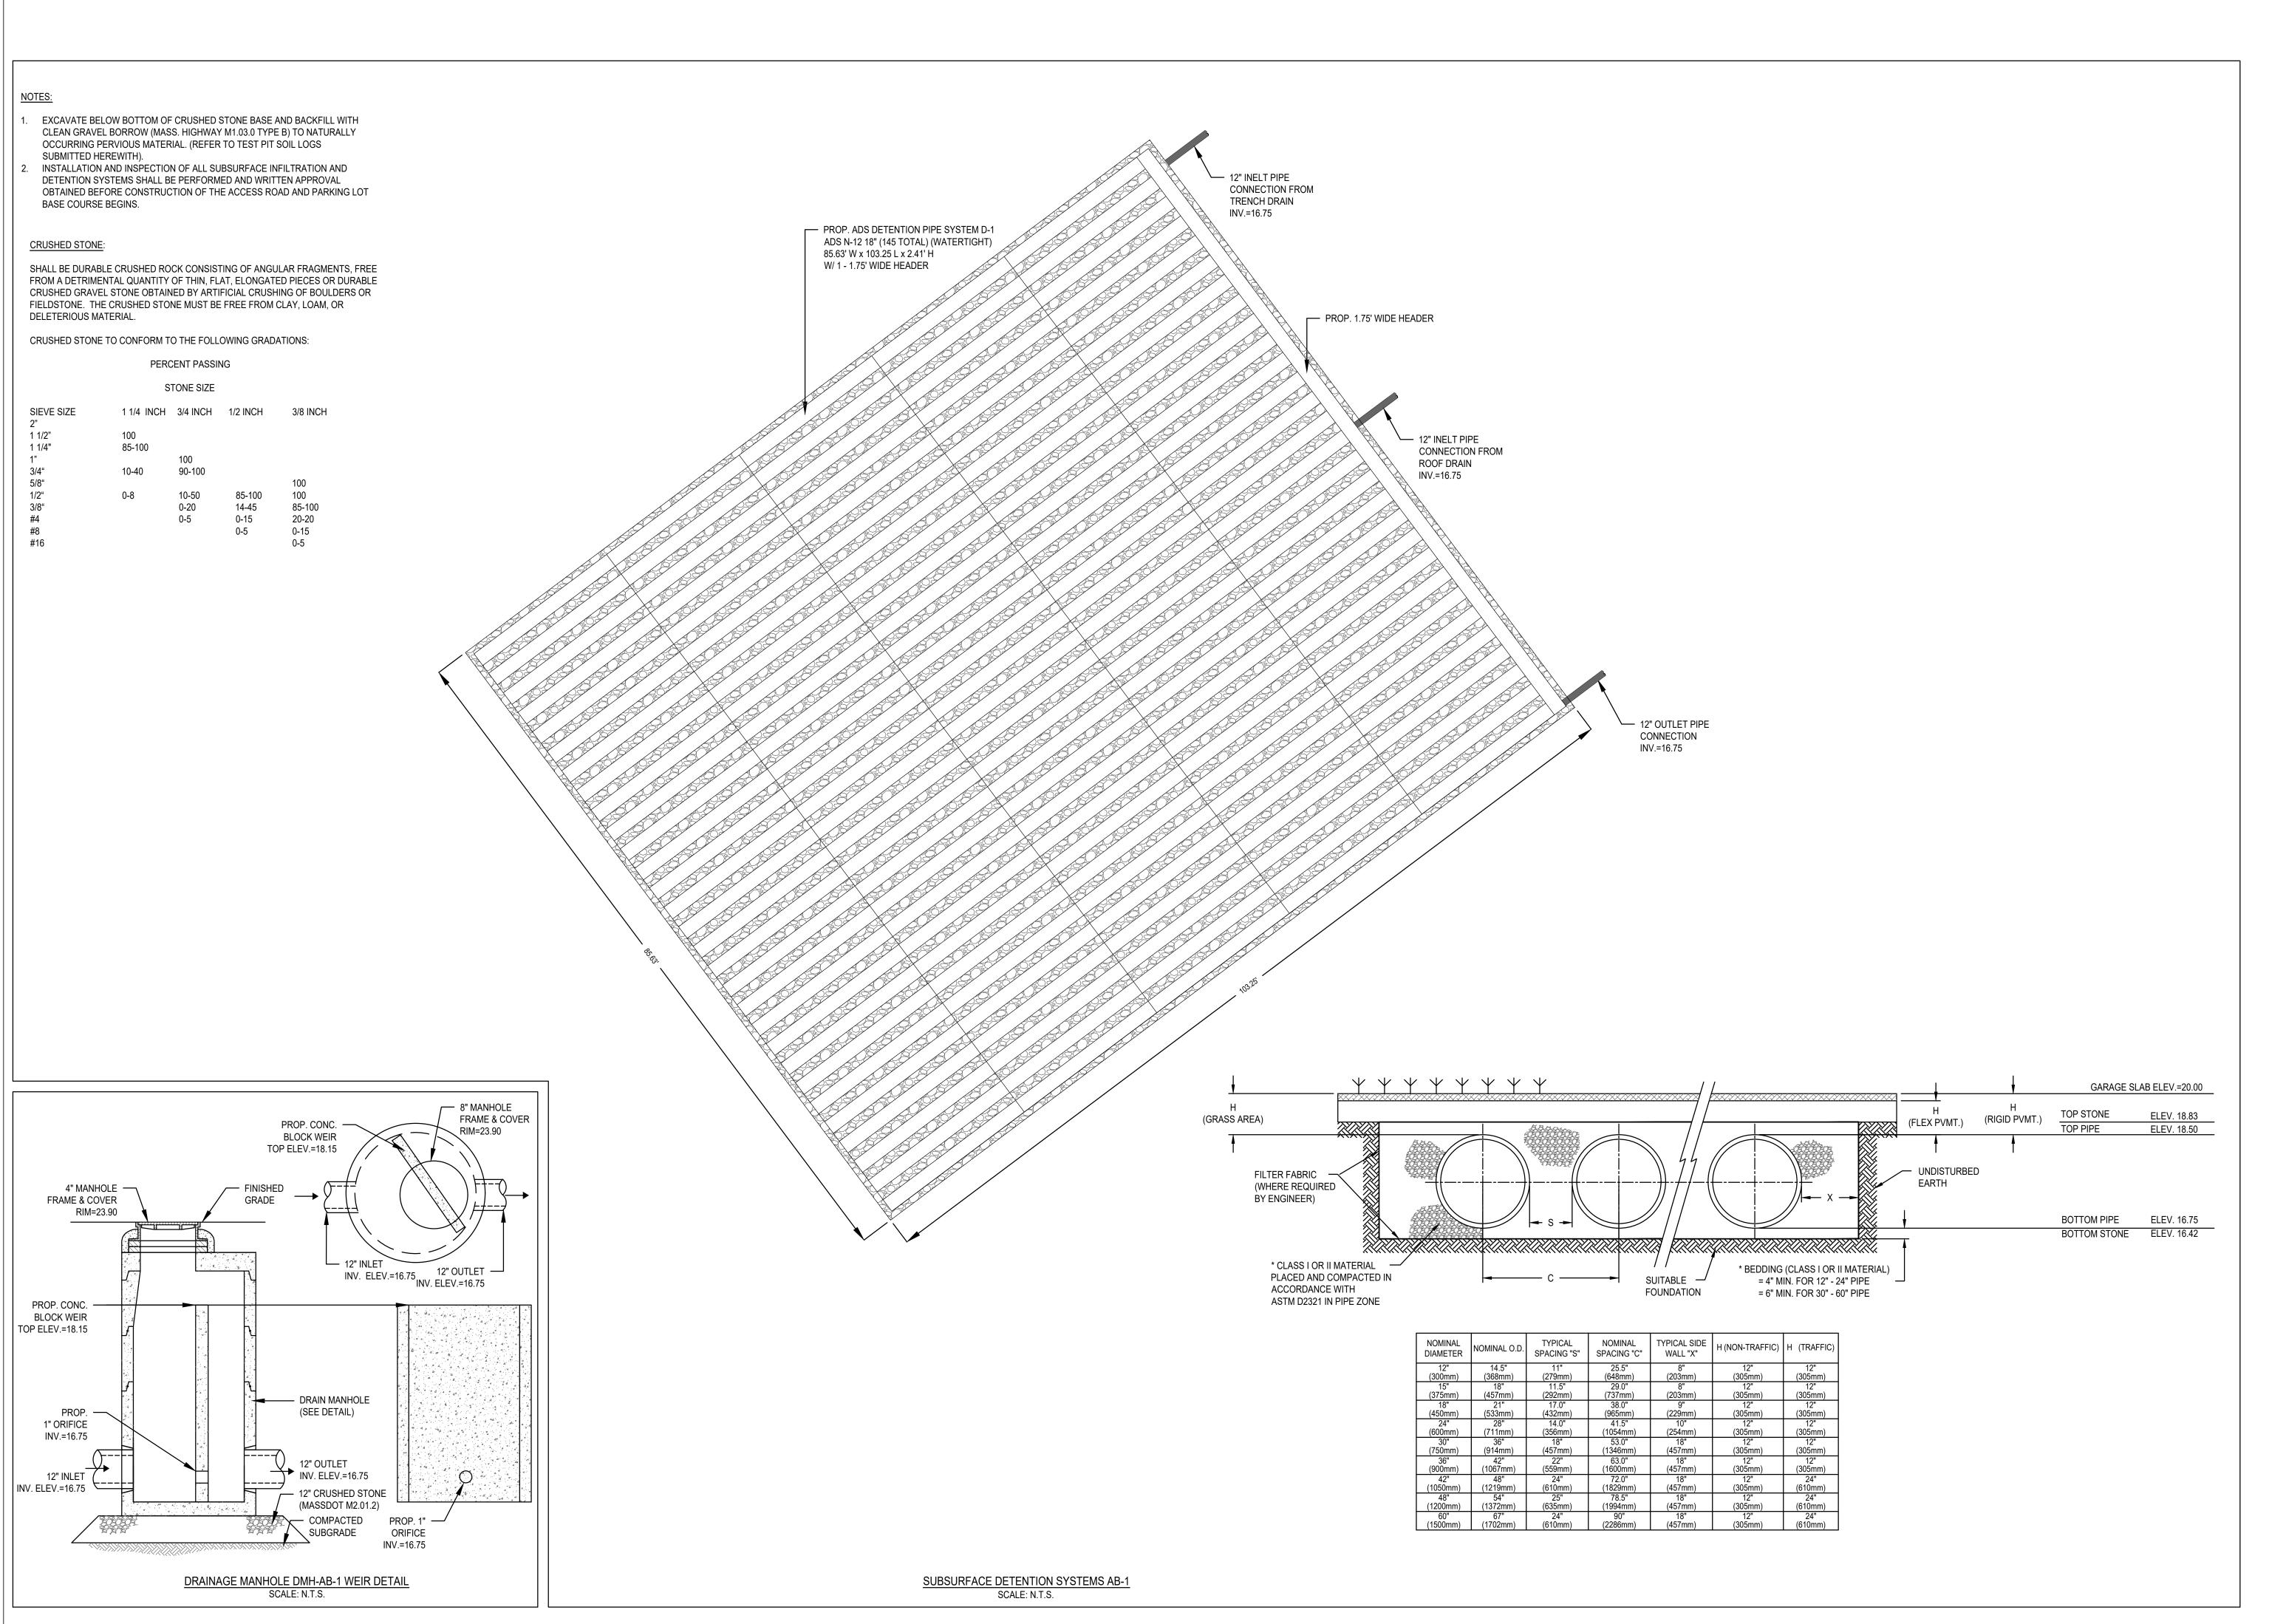

| ARCHITECT

BOSTON, MA 02118 O: 617.765.8000

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IRAKLIS N PAPACHRISTOS, MANAGER OF 864, 909, 910 BROAD ST LLCs AND 1409 COMMERCIAL ST LLC 1 Franklin Street, Unit 2308 BOSTON, MA 02110

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LANDSCAPE MDLA

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REVISIONS




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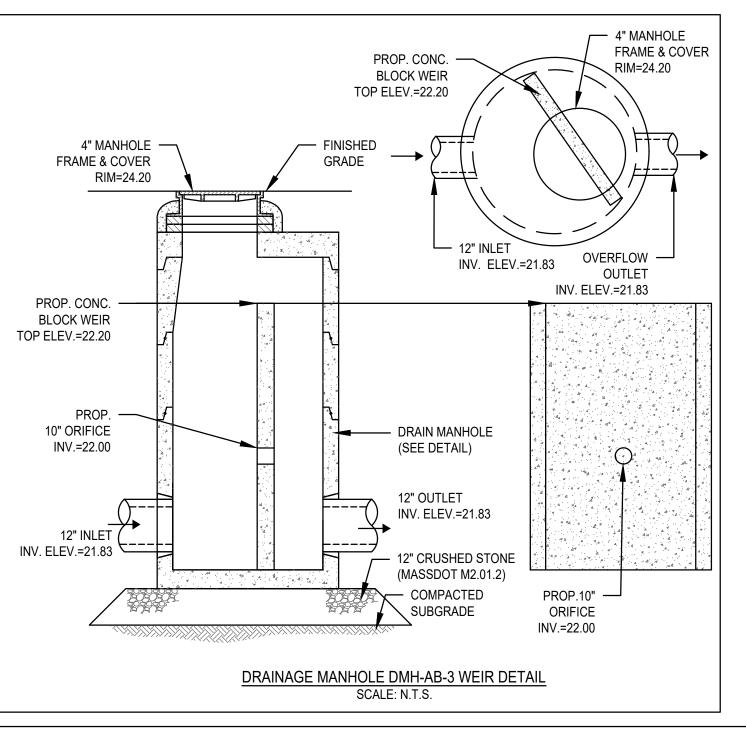
DRAWING INFORMATION

PROJECT #:

NOT TO SCALE

DRAWING TITLE CONSTRUCTION

DETAILS

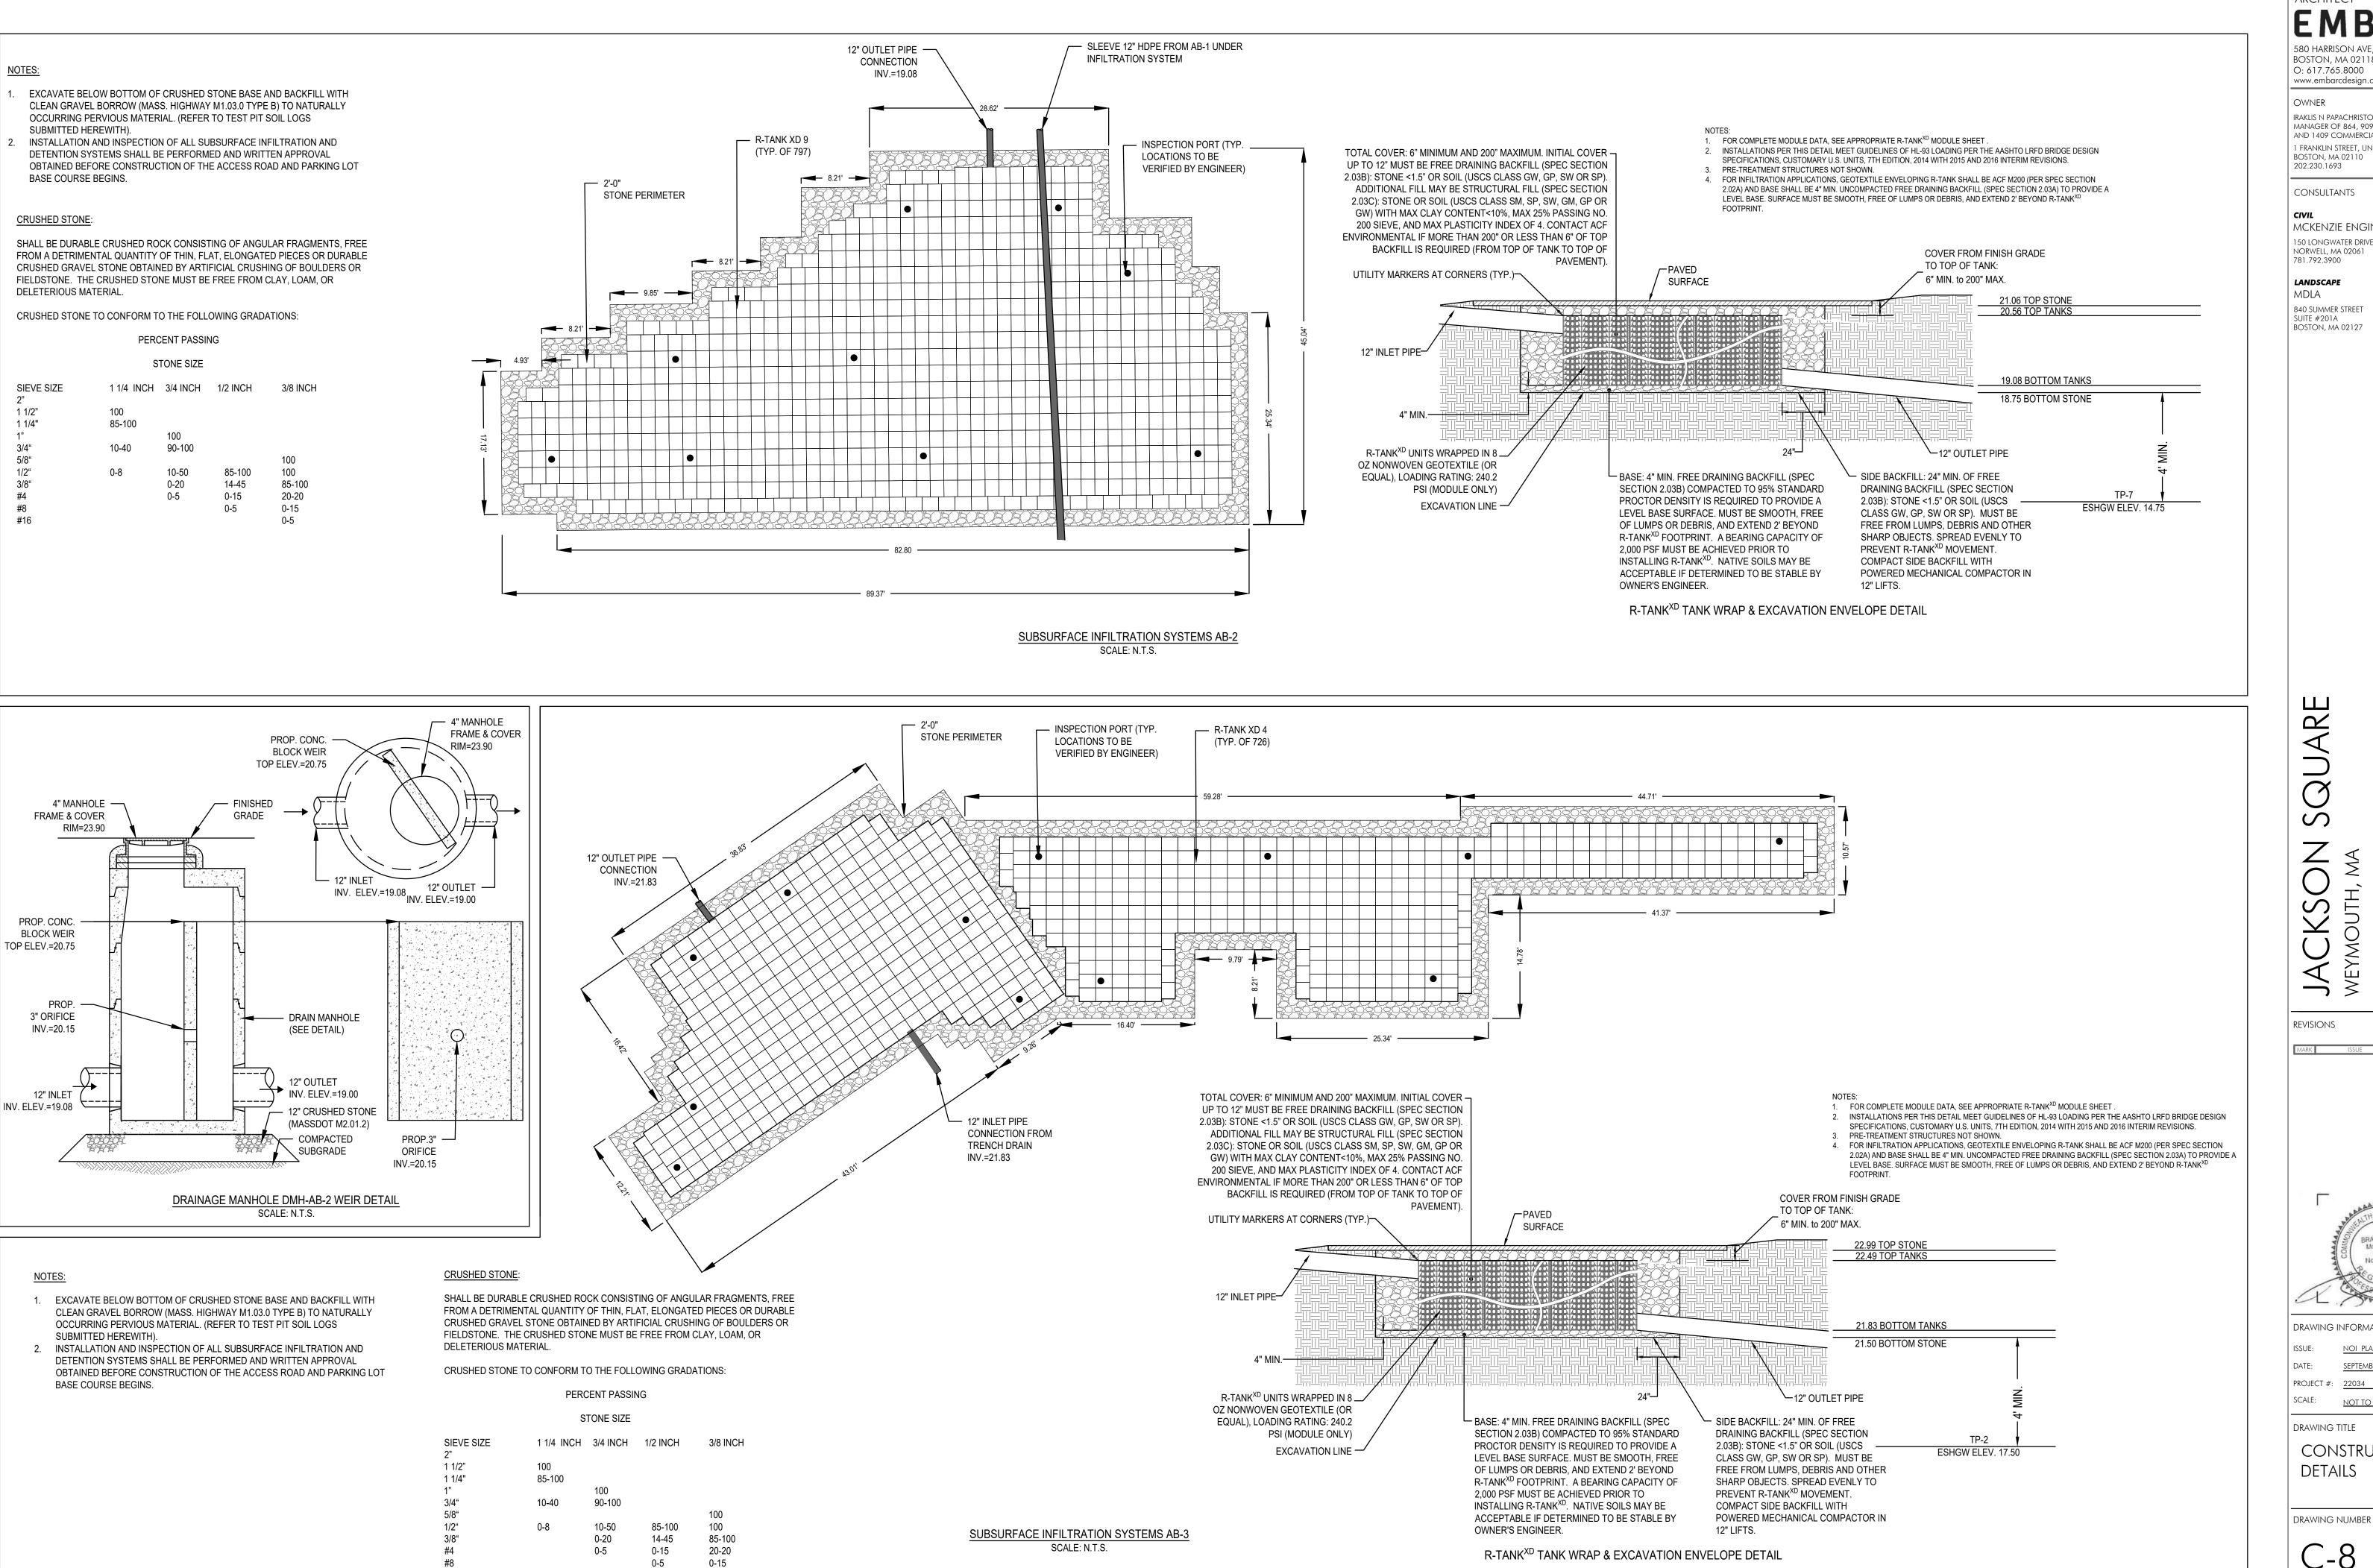

EXCAVATE BELOW BOTTOM OF CRUSHED STONE BASE AND BACKFILL WITH

CLEAN GRAVEL BORROW (MASS. HIGHWAY M1.03.0 TYPE B) TO NATURALLY

INSTALLATION AND INSPECTION OF ALL SUBSURFACE INFILTRATION AND

OBTAINED BEFORE CONSTRUCTION OF THE ACCESS ROAD AND PARKING LOT

SHALL BE DURABLE CRUSHED ROCK CONSISTING OF ANGULAR FRAGMENTS, FREE

FROM A DETRIMENTAL QUANTITY OF THIN, FLAT, ELONGATED PIECES OR DURABLE

CRUSHED GRAVEL STONE OBTAINED BY ARTIFICIAL CRUSHING OF BOULDERS OR

FIELDSTONE. THE CRUSHED STONE MUST BE FREE FROM CLAY, LOAM, OR

PERCENT PASSING

STONE SIZE

1 1/4 INCH 3/4 INCH 1/2 INCH

90-100

10-50

0-20


CRUSHED STONE TO CONFORM TO THE FOLLOWING GRADATIONS:


85-100

10-40

DETENTION SYSTEMS SHALL BE PERFORMED AND WRITTEN APPROVAL

OCCURRING PERVIOUS MATERIAL. (REFER TO TEST PIT SOIL LOGS

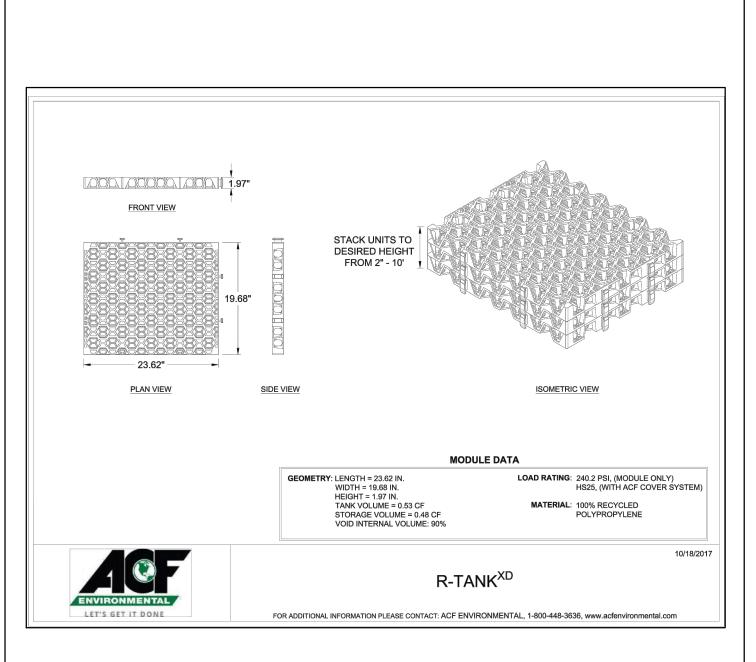

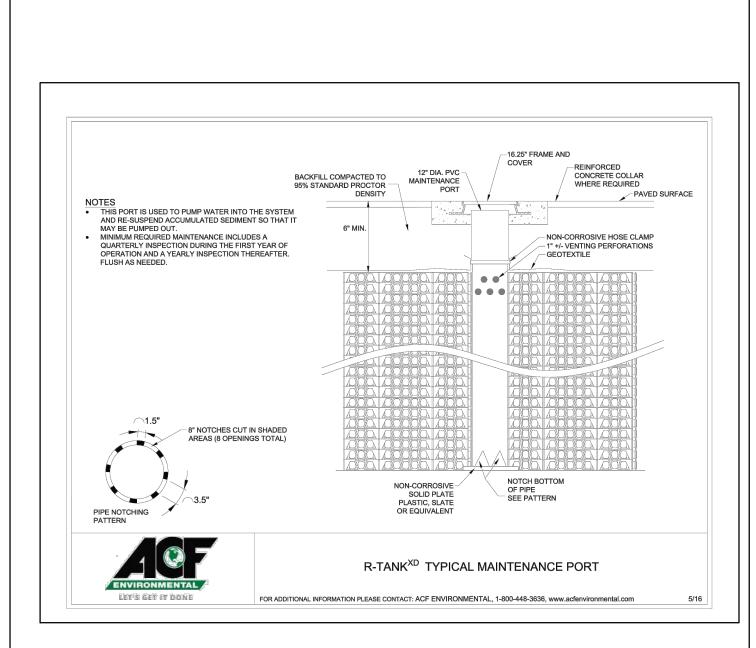


(GRASS AREA)

FILTER FABRIC

BY ENGINEER)

(WHERE REQUIRED

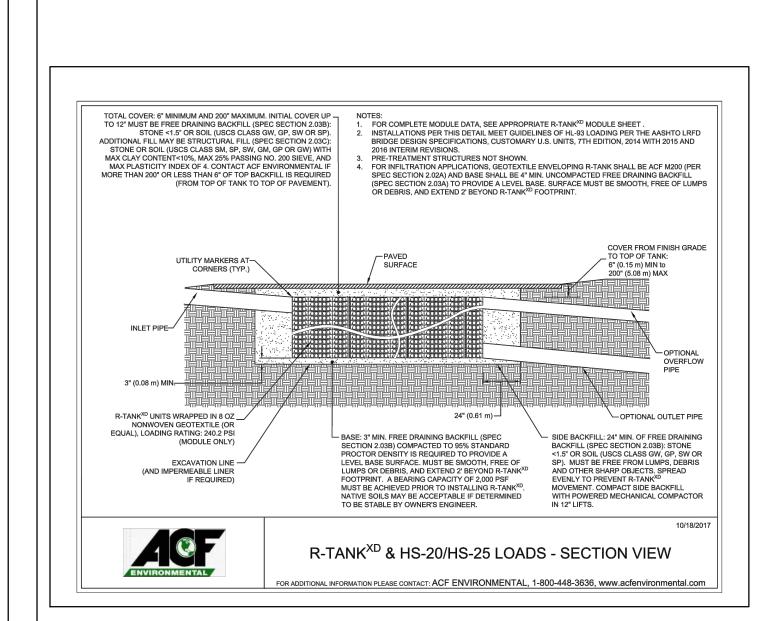



SYSTEM NO. D-1

ELEV. 28.50

ELEV. 28.17

ELEV. 26.66

BOTTOM STONE ELEV. 26.33

TOP STONE

BOTTOM PIPE

4 GENERAL UPDATES AND RENAMED TJR 02/19/16
REV. DESCRIPTION BY MW/DD/YY

(RIGID PVMT.)

(FLEX PVMT.)

UNDISTURBED


EARTH


* BEDDING (CLASS I OR II MATERIAL) = 4" MIN. FOR 12" - 24" HDPE PIPE = 6" MIN. FOR 30"-80" HDPE PIPE

= 4" MIN. FOR 12" - 24" HDPE PIPE = 6" MIN. FOR 30"-60" HDPE PIPE



Z

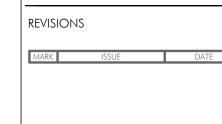

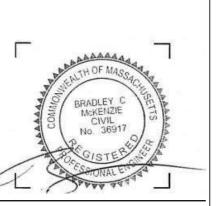


Æ,	SOONAL ELIGIBLE
PRAWING I	NFORMATION
SSUE:	noi plan review
ATE:	SEPTEMBER 6, 2023


PROJECT #: 22034 NOT TO SCALE


DRAWING TITLE CONSTRUCTION

DETAILS

DRAWING NUMBER

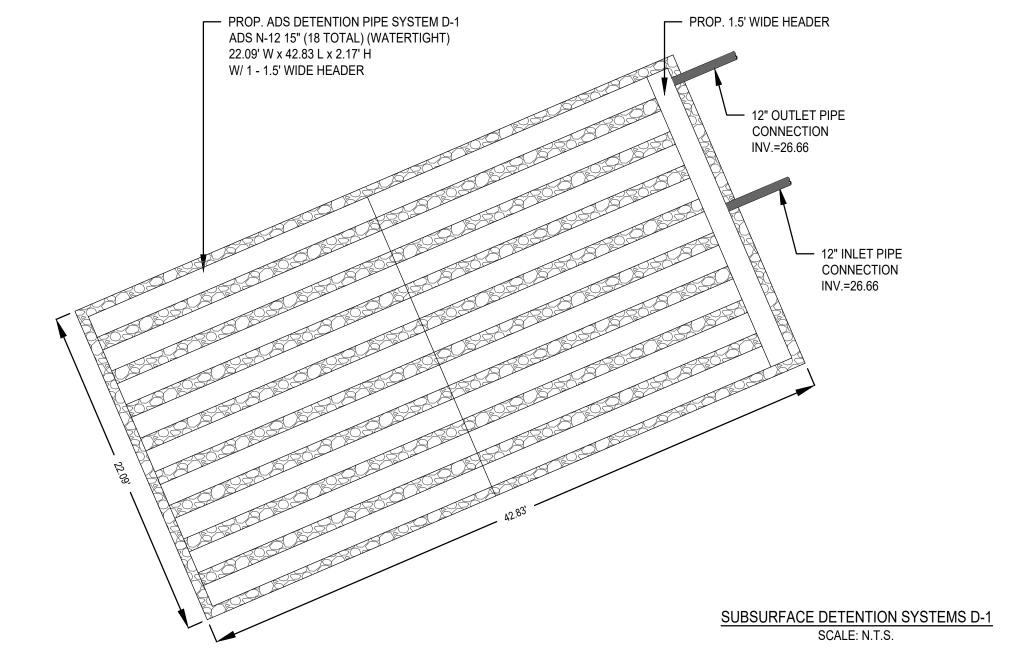

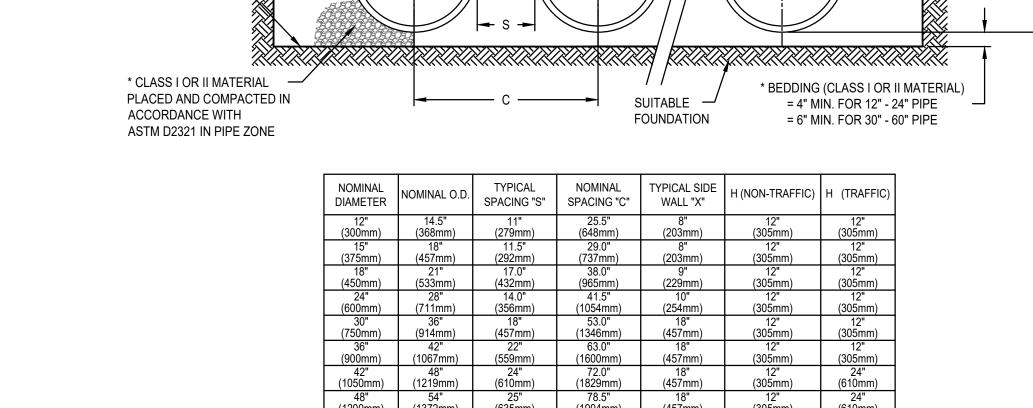

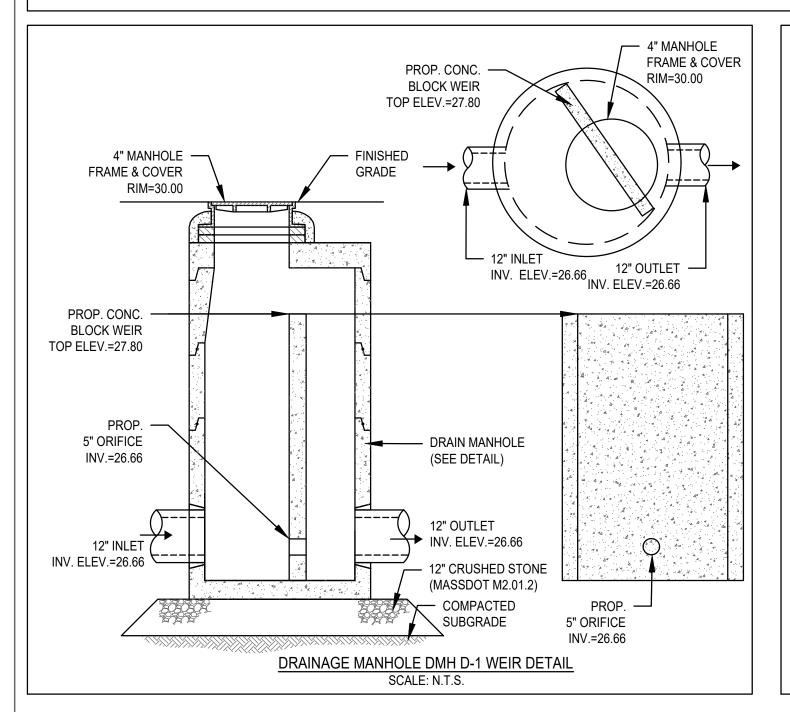


3/8 INCH


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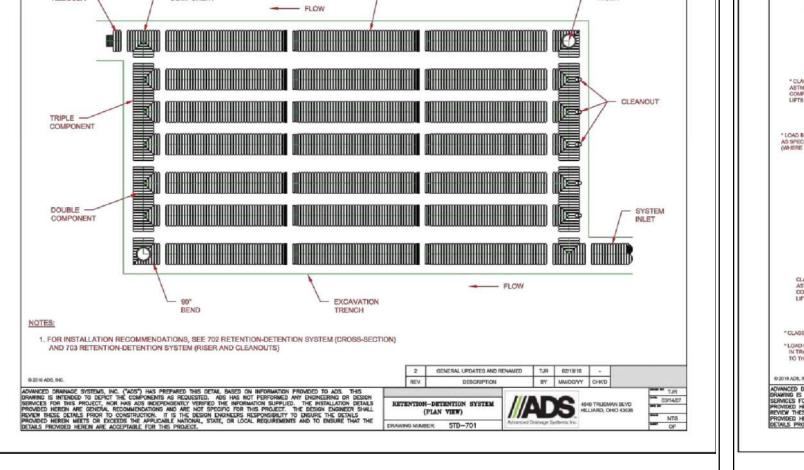
20-20 0-15

14-45

0-15



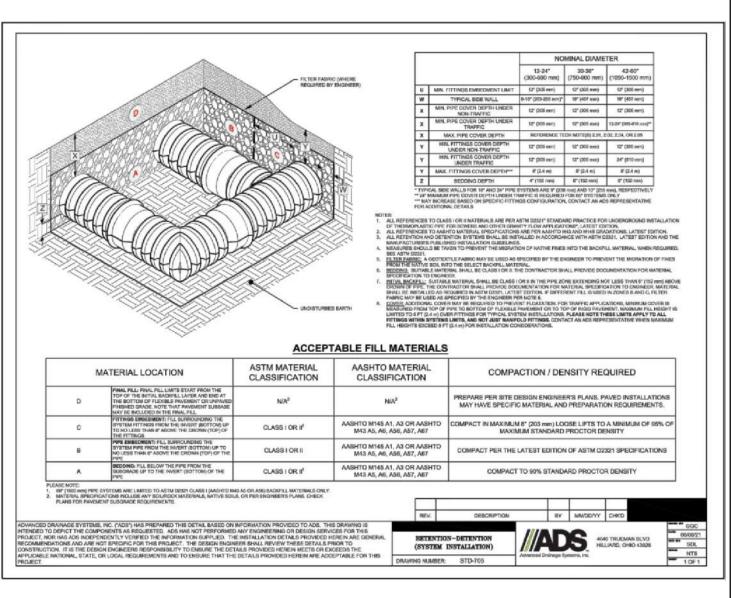

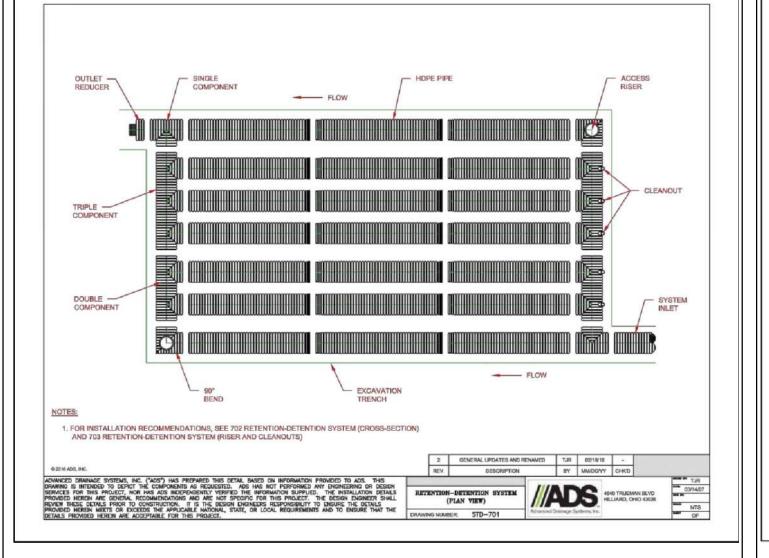

NOTES:


BASE COURSE BEGINS.


CRUSHED STONE:


SIEVE SIZE

1 1/2" 1 1/4"

DELETERIOUS MATERIAL.

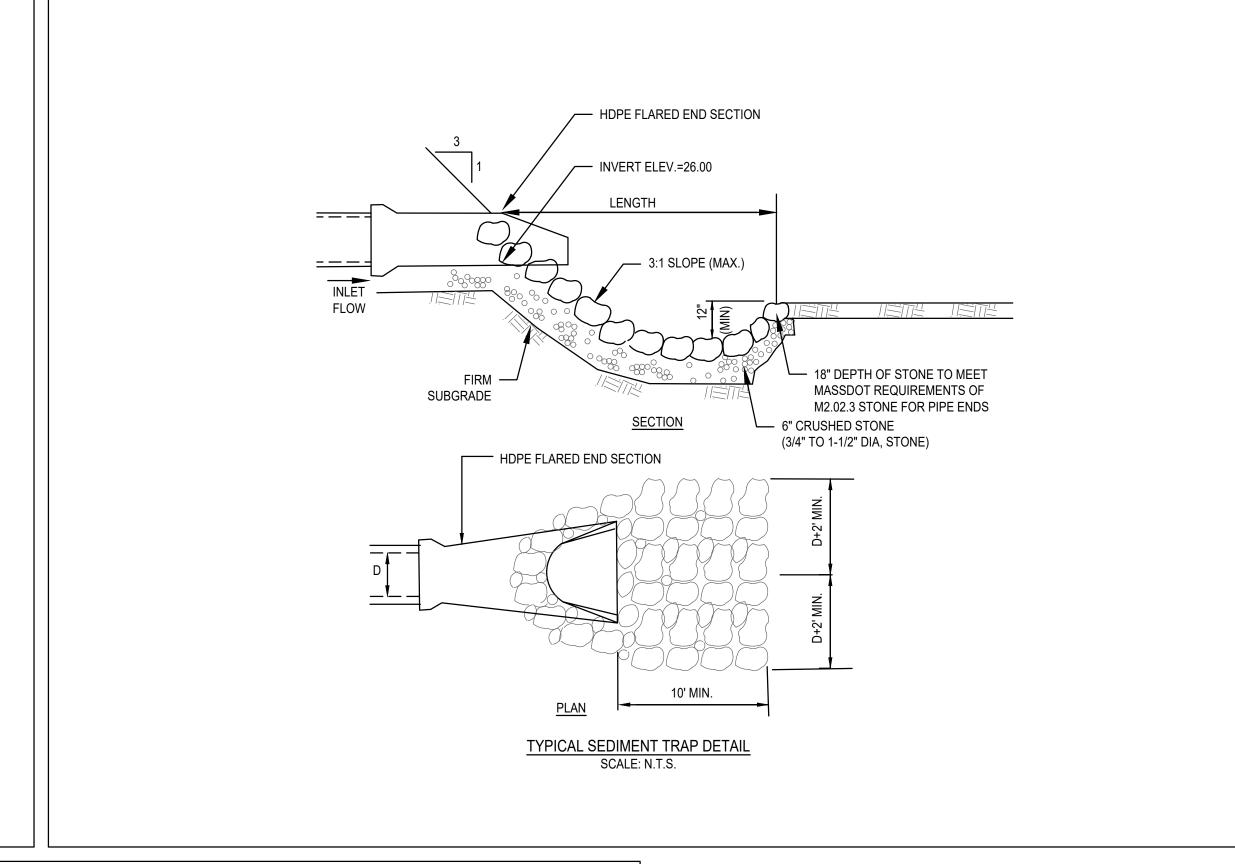

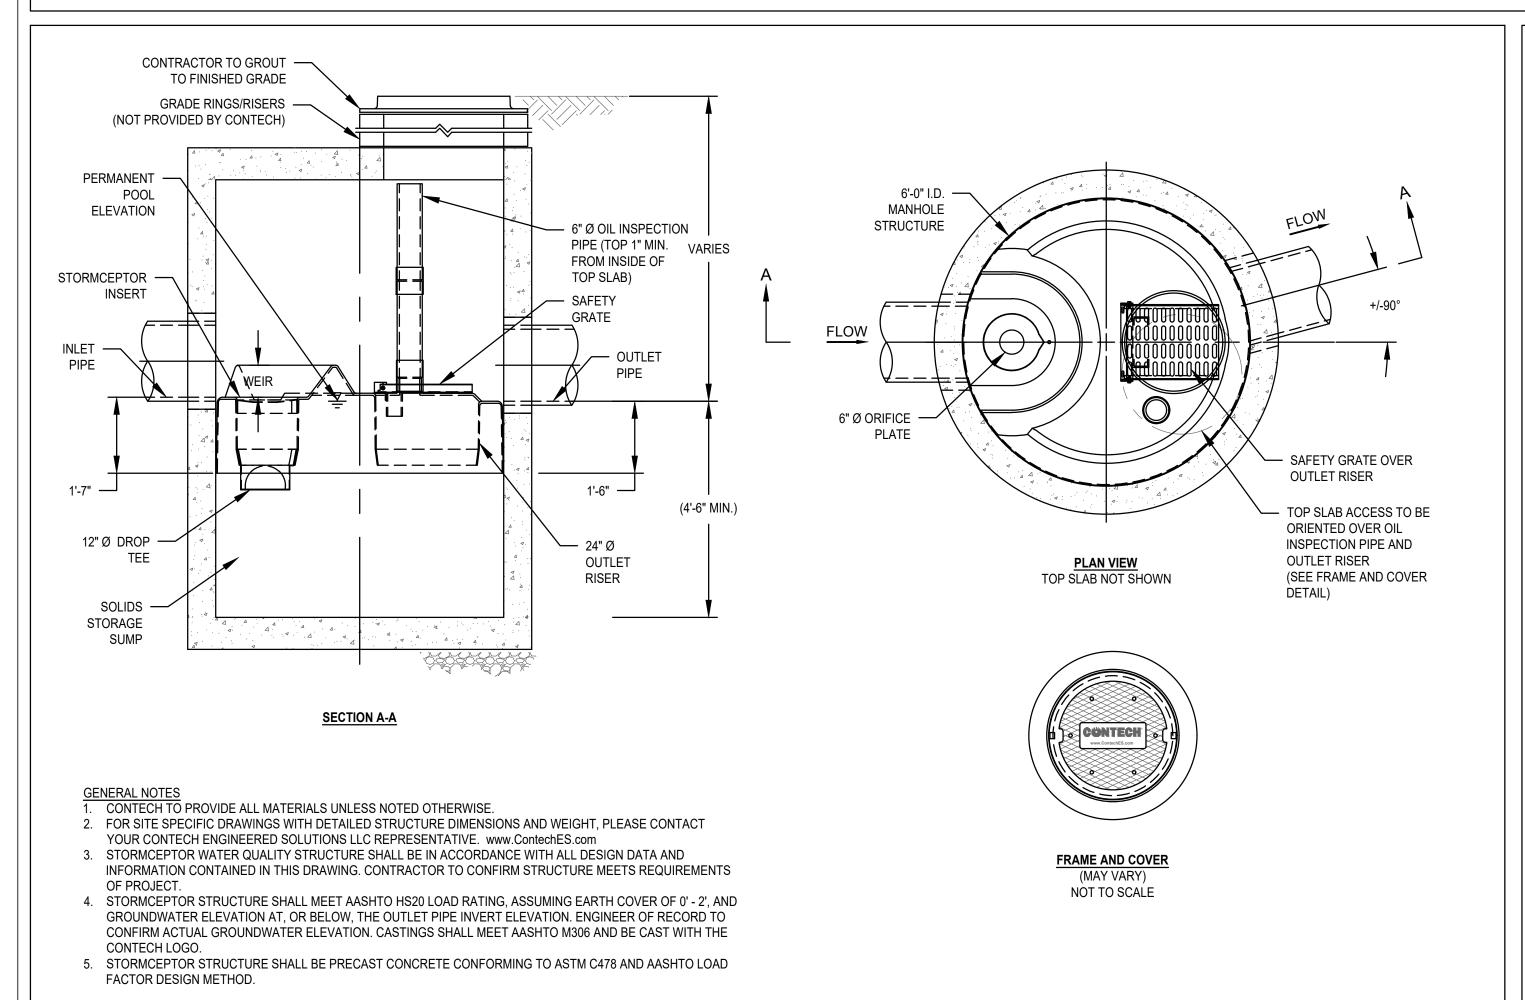

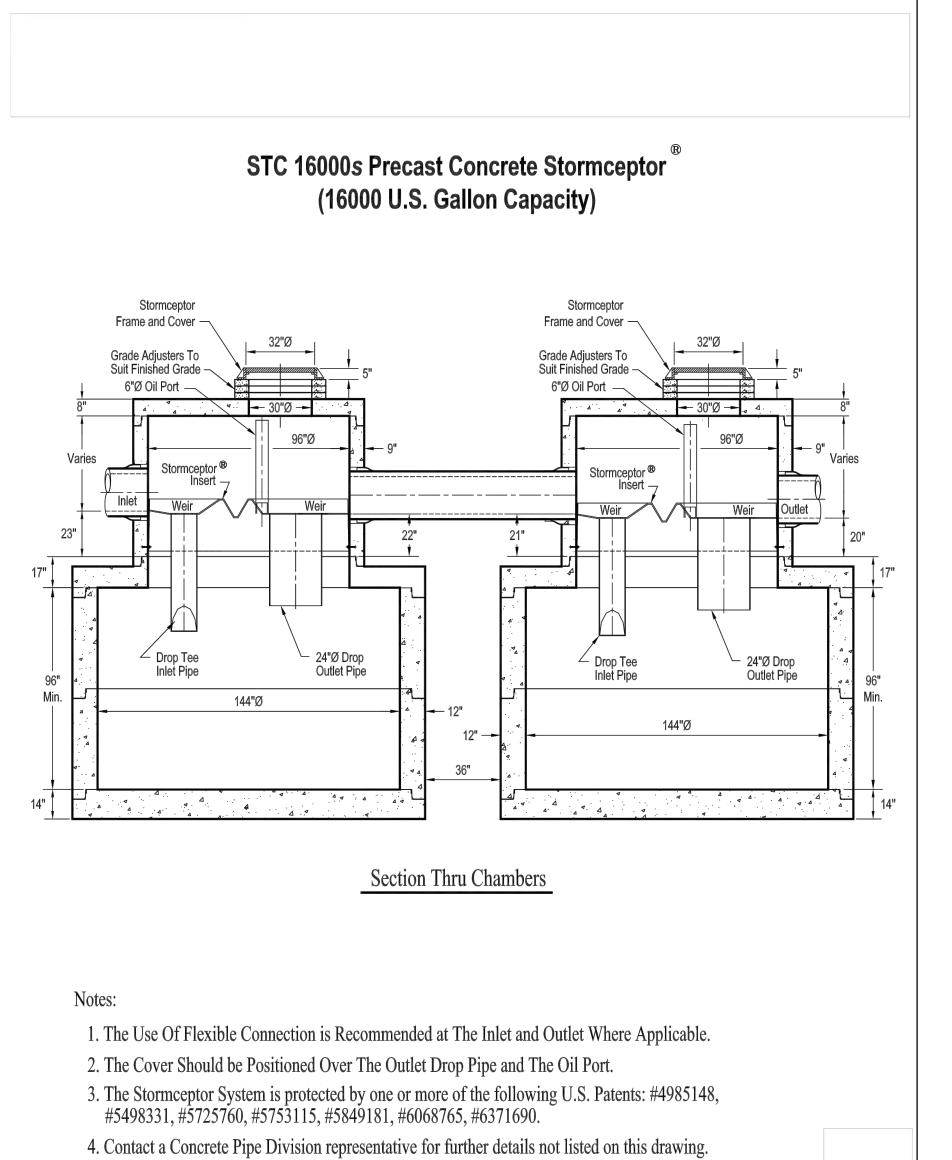

| ARCHITECT BOSTON, MA 02118

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OWNER

MCKENZIE ENGINEERING GROUP 150 LONGWATER DRIVE, SUITE 101 NORWELL, MA 02061

LANDSCAPE MDLA 840 SUMMER STREET

SUITE #201A BOSTON, MA 02127

revisions



DRAWING INFORMATION

NOI PLAN REVIEW

PROJECT #: 22034

SEPTEMBER 6, 2023

DRAWING TITLE CONSTRUCTION

DRAWING NUMBER

DETAILS

copyright: EMBARC INC.

STC 900 STORMCEPTOR STANDARD DETAIL SCALE: N.T.S.

A. ANY SUB-BASE, BACKFILL DEPTH, AND/OR ANTI-FLOTATION PROVISIONS ARE SITE-SPECIFIC DESIGN

ELEVATIONS SHOWN. ALL PIPE CENTERLINES TO MATCH PIPE OPENING CENTERLINES.

B. CONTRACTOR TO PROVIDE EQUIPMENT WITH SUFFICIENT LIFTING AND REACH CAPACITY TO LIFT AND SET THE


C. CONTRACTOR TO INSTALL JOINT SEALANT BETWEEN ALL STRUCTURE SECTIONS AND ASSEMBLE STRUCTURE.


D. CONTRACTOR TO PROVIDE, INSTALL, AND GROUT INLET AND OUTLET PIPE(S). MATCH PIPE INVERTS WITH


E. CONTRACTOR TO TAKE APPROPRIATE MEASURES TO ASSURE UNIT IS WATER TIGHT, HOLDING WATER TO FLOWLINE INVERT MINIMUM. IT IS SUGGESTED THAT ALL JOINTS BELOW PIPE INVERTS ARE GROUTED.


CONSIDERATIONS AND SHALL BE SPECIFIED BY ENGINEER OF RECORD.


STORMCEPTOR MANHOLE STRUCTURE.

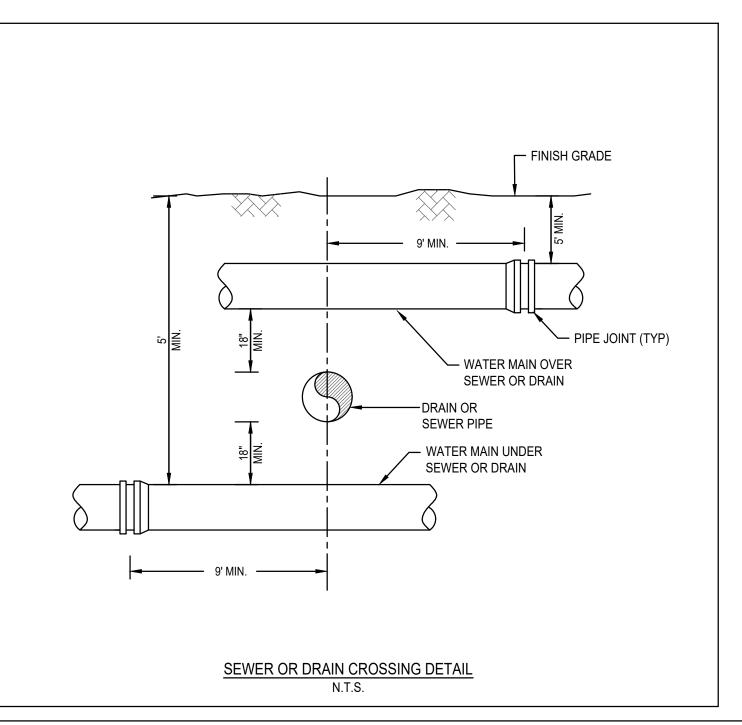


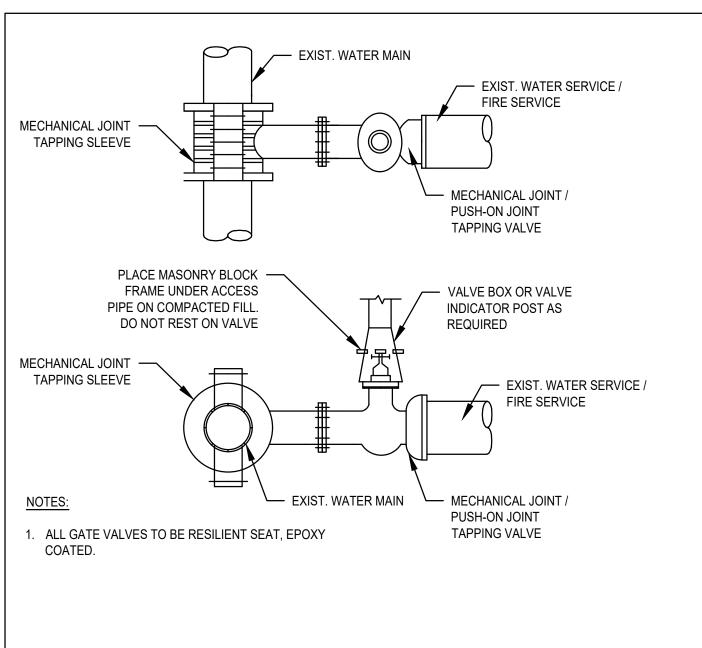


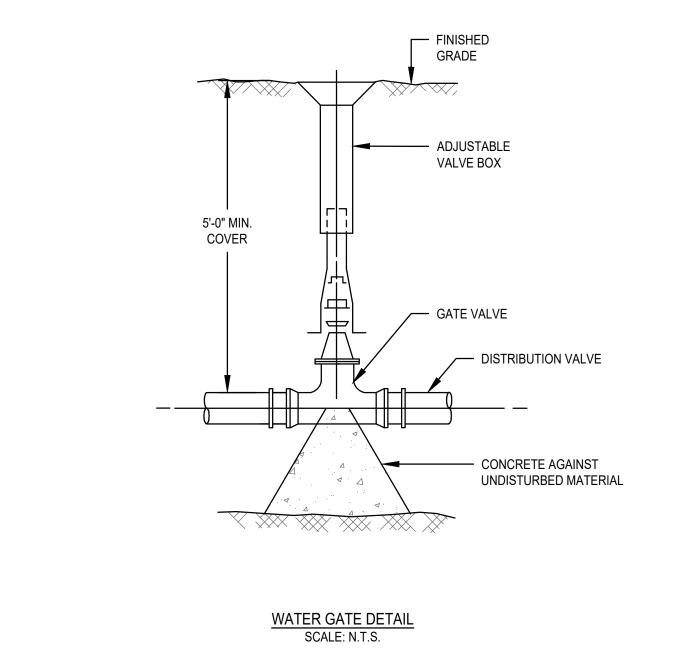


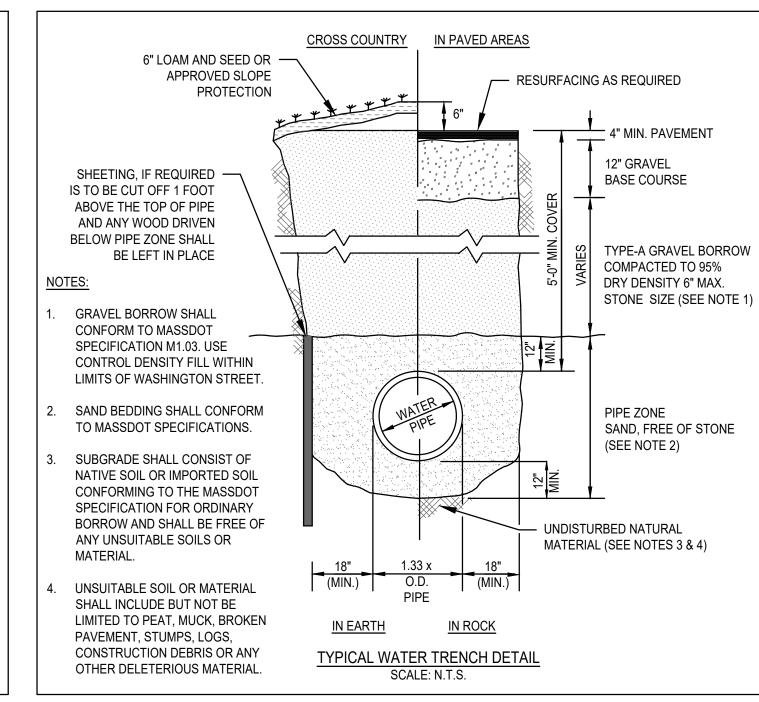

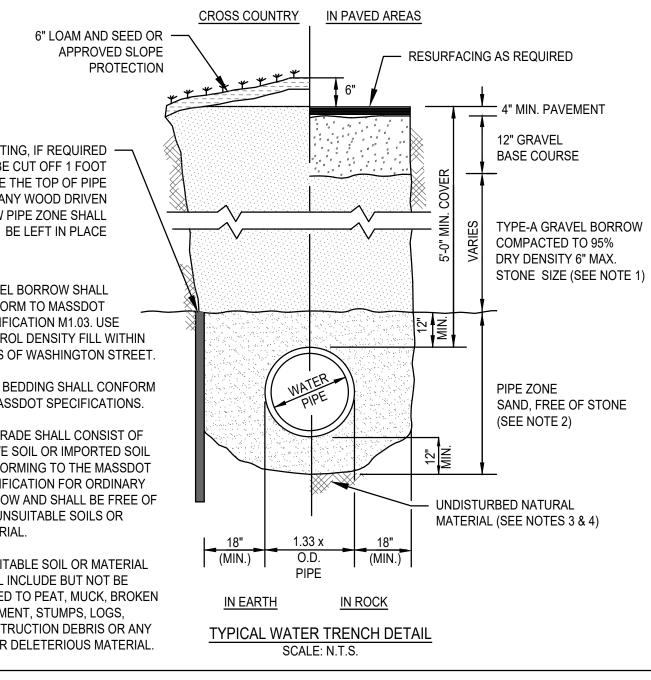


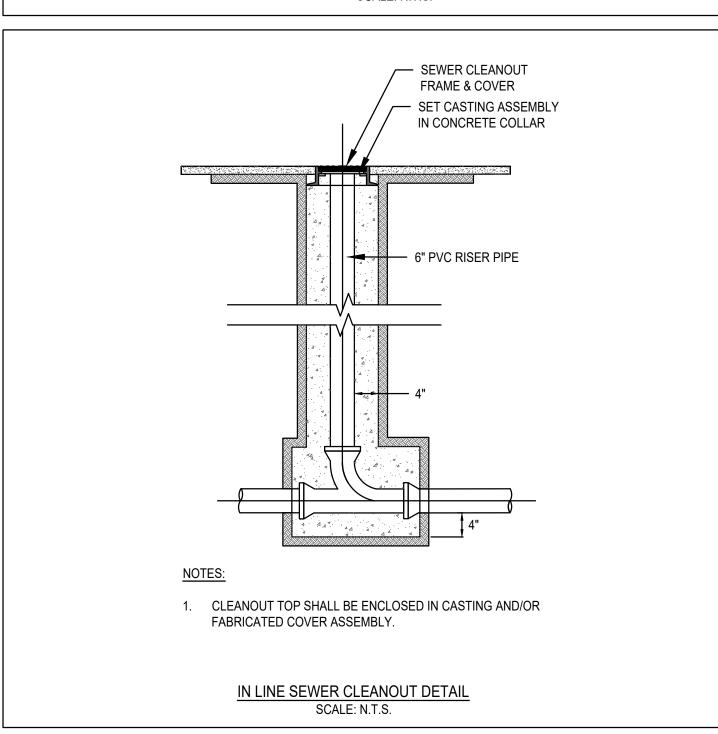

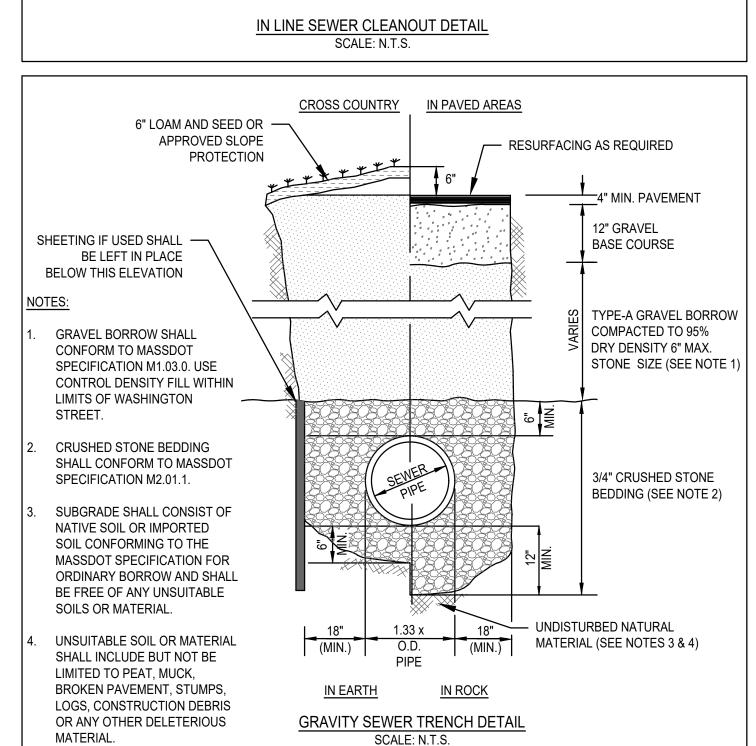

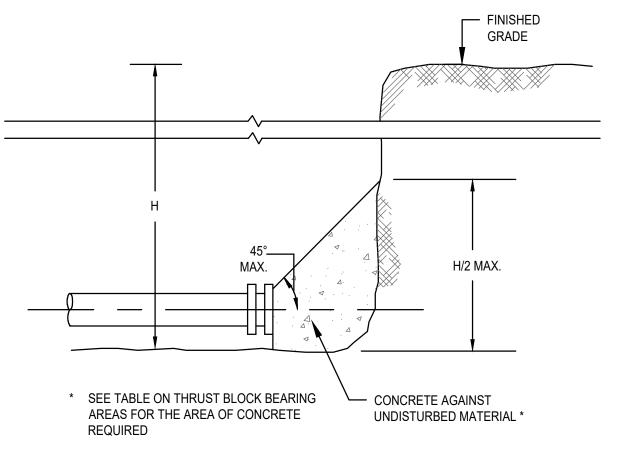


THRUST WATER MAIN PLUG SCALE: N.T.S.

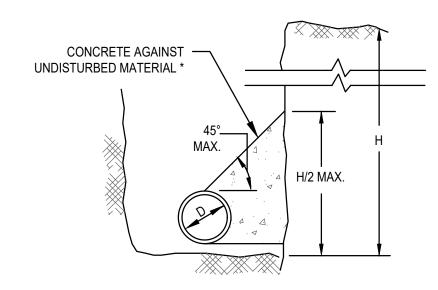

THRUST WATER MAIN THRUST BLOCK SECTION DETAIL SCALE: N.T.S.

THRUST BLOCK BEARING AREAS FOR WATER PIPE

	SQ. FT. AGAINST UNDIS FER MAIN FITTINGS*	TURBED	
SIZE OF MAIN (IN.)	90° BEND	TEES AND PLUGS	45° BEND
6	4	2.5	2
8	6	4	3
12	12	9	7
16	21	16	12

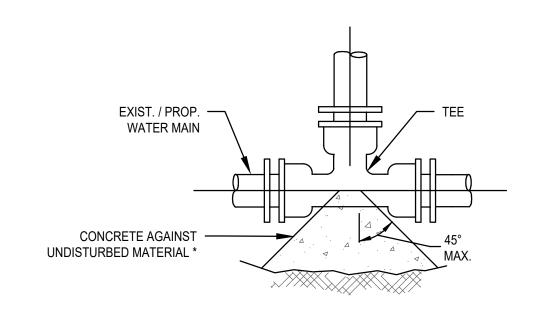


TYPICAL TAPPING SLEEVE AND VALVE DETAIL

SCALE: N.T.S.

* SEE TABLE ON THRUST BLOCK BEARING AREAS FOR THE AREA OF CONCRETE REQUIRED

TYPICAL WATER MAIN TEE THRUST BLOCK DETAIL

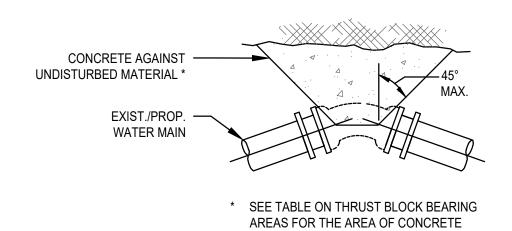

REQUIRED

THRUST WATER MAIN BEND THRUST BLOCK DETAIL SCALE: N.T.S.


NOTES:


- 1. FOR FITTINGS WITH LESS THAN 45° DEFLECTION, USE BEARING AREAS FOR 45° BEND.
- 2. BEARING AREAS BASED ON HORIZONTAL PASSIVE SOIL PRESSURE OF 2000 P.S.F. AND INTERNAL WATER PRESSURE OF 150 P.S.I.G. JOINTS SHALL NOT BE ENCASED IN CONCRETE. BEARING AREAS MAY BE DIREGARDED FOR TRENCHES IN ROCK WHERE THE TOP OF THE ROCK FACE IS AT OR ABOVE THE CROWN OF THE PIPE. HOWEVER, CONCRETE BACKING SHALL BE PLACED BETWEEN THE PIPE AND THE ROCK FACE.
- 3. THE CONTRACTOR SHALL SUBMIT 2 WEEKS IN ADVANCE OF PLACEMENT, WORKING DRAWINGS FOR EACH THRUST BLOCK TO THE ENGINEER FOR APPROVAL PRIOR TO INSTALLATION.
- 4. ALL VALVES AND FITTINGS SHALL BE RODDED TOGETHER.

ASSUMPTIONS:

* TYPE OF SOIL IS MEDIUM CLAYEY, 6 OR MORE BLOWS PER FOOT, OR LOOSE GRANULAR, 9 OR MORE BLOWS PER FOOT. SOIL CONDITIONS OTHER THAN THOSE GIVEN WILL REQUIRE LARGER BEARING AREAS.

THRUST BLOCK DETAILS SCALE: N.T.S.

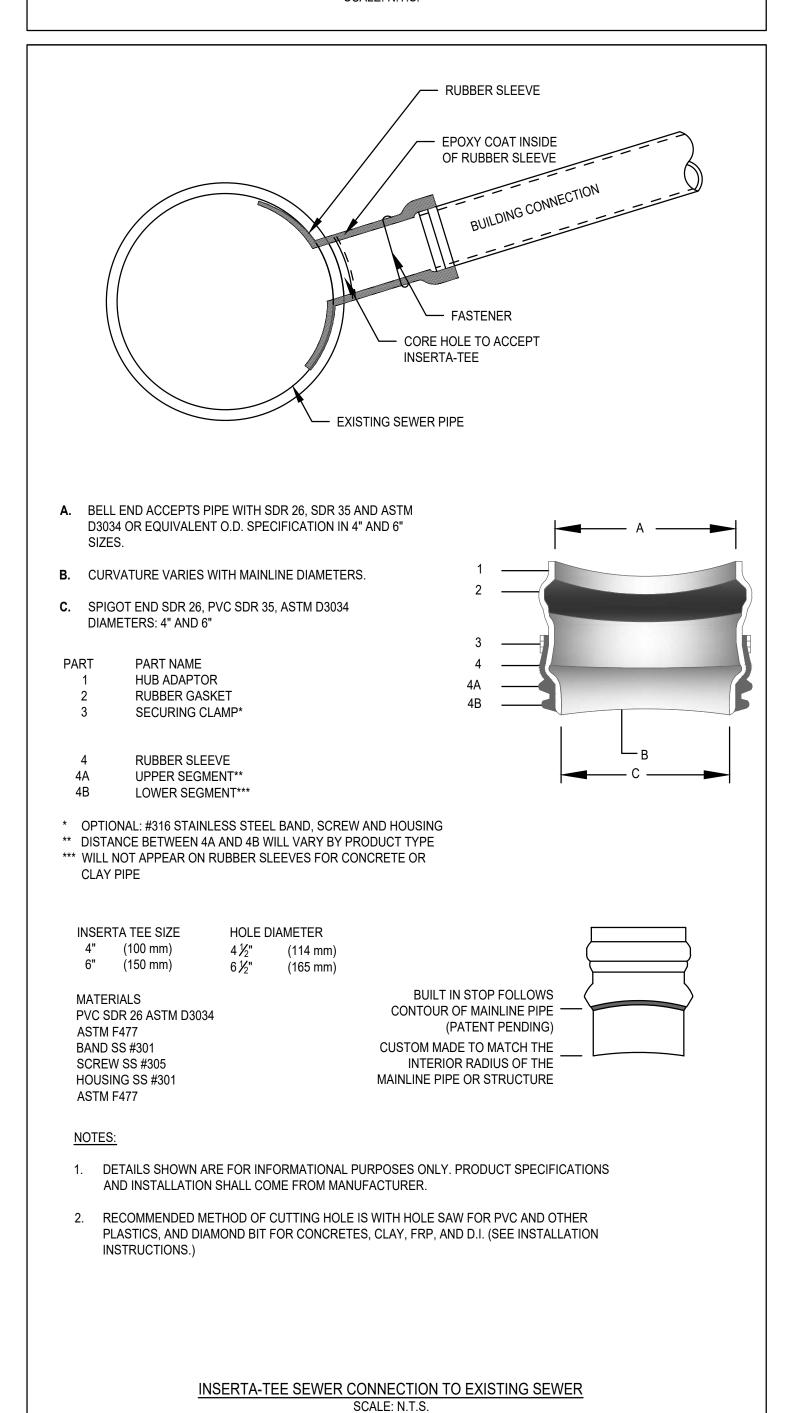

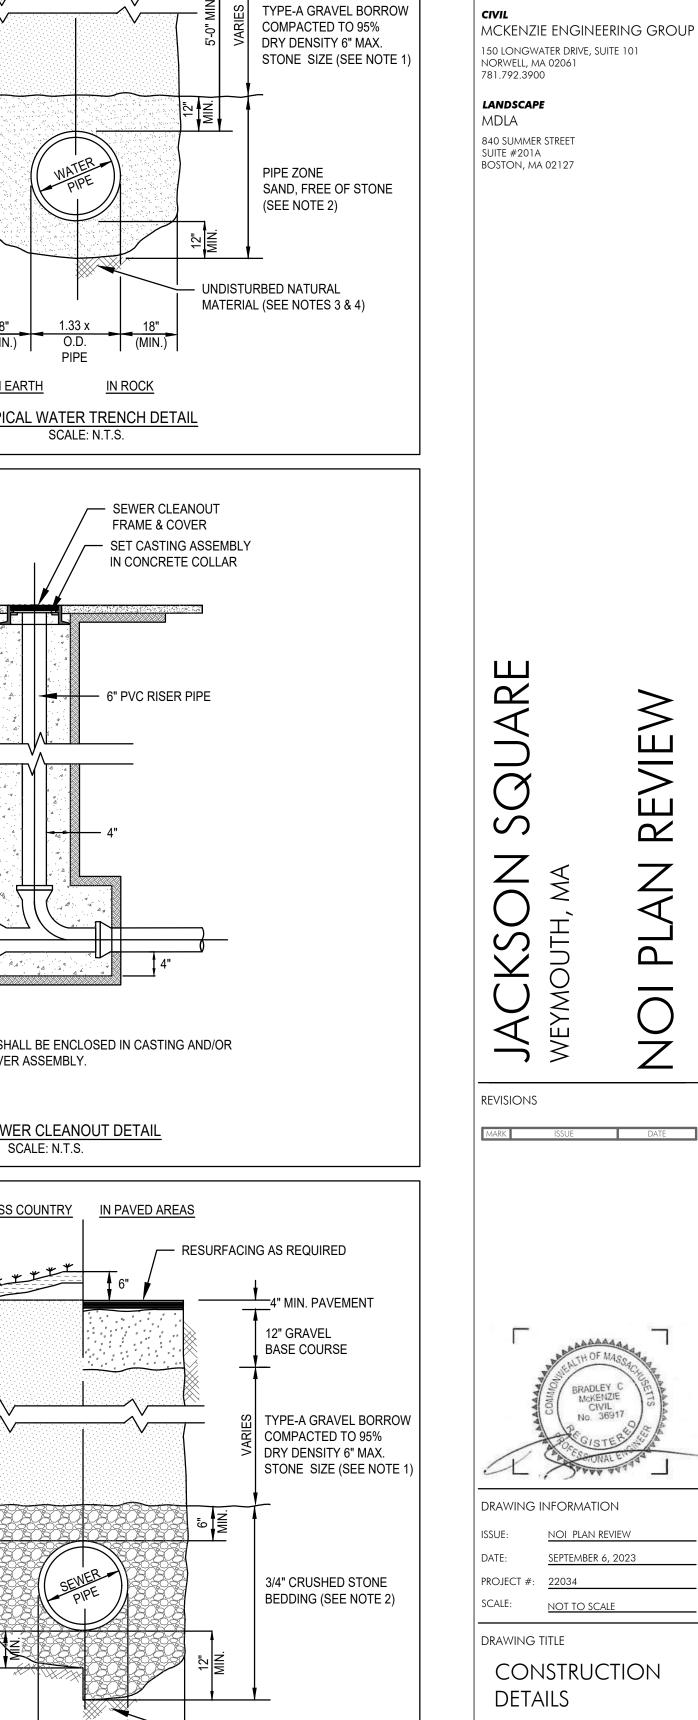

| ARCHITECT

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AND 1409 COMMERCIAL ST LLC

1 FRANKLIN STREET, UNIT 2308

MANAGER OF 864, 909, 910 BROAD ST LLCs


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DRAWING NUMBER


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OWNER



onts\22034_Jackson Square Weymouth_tlorangerLPKPZ.rvt

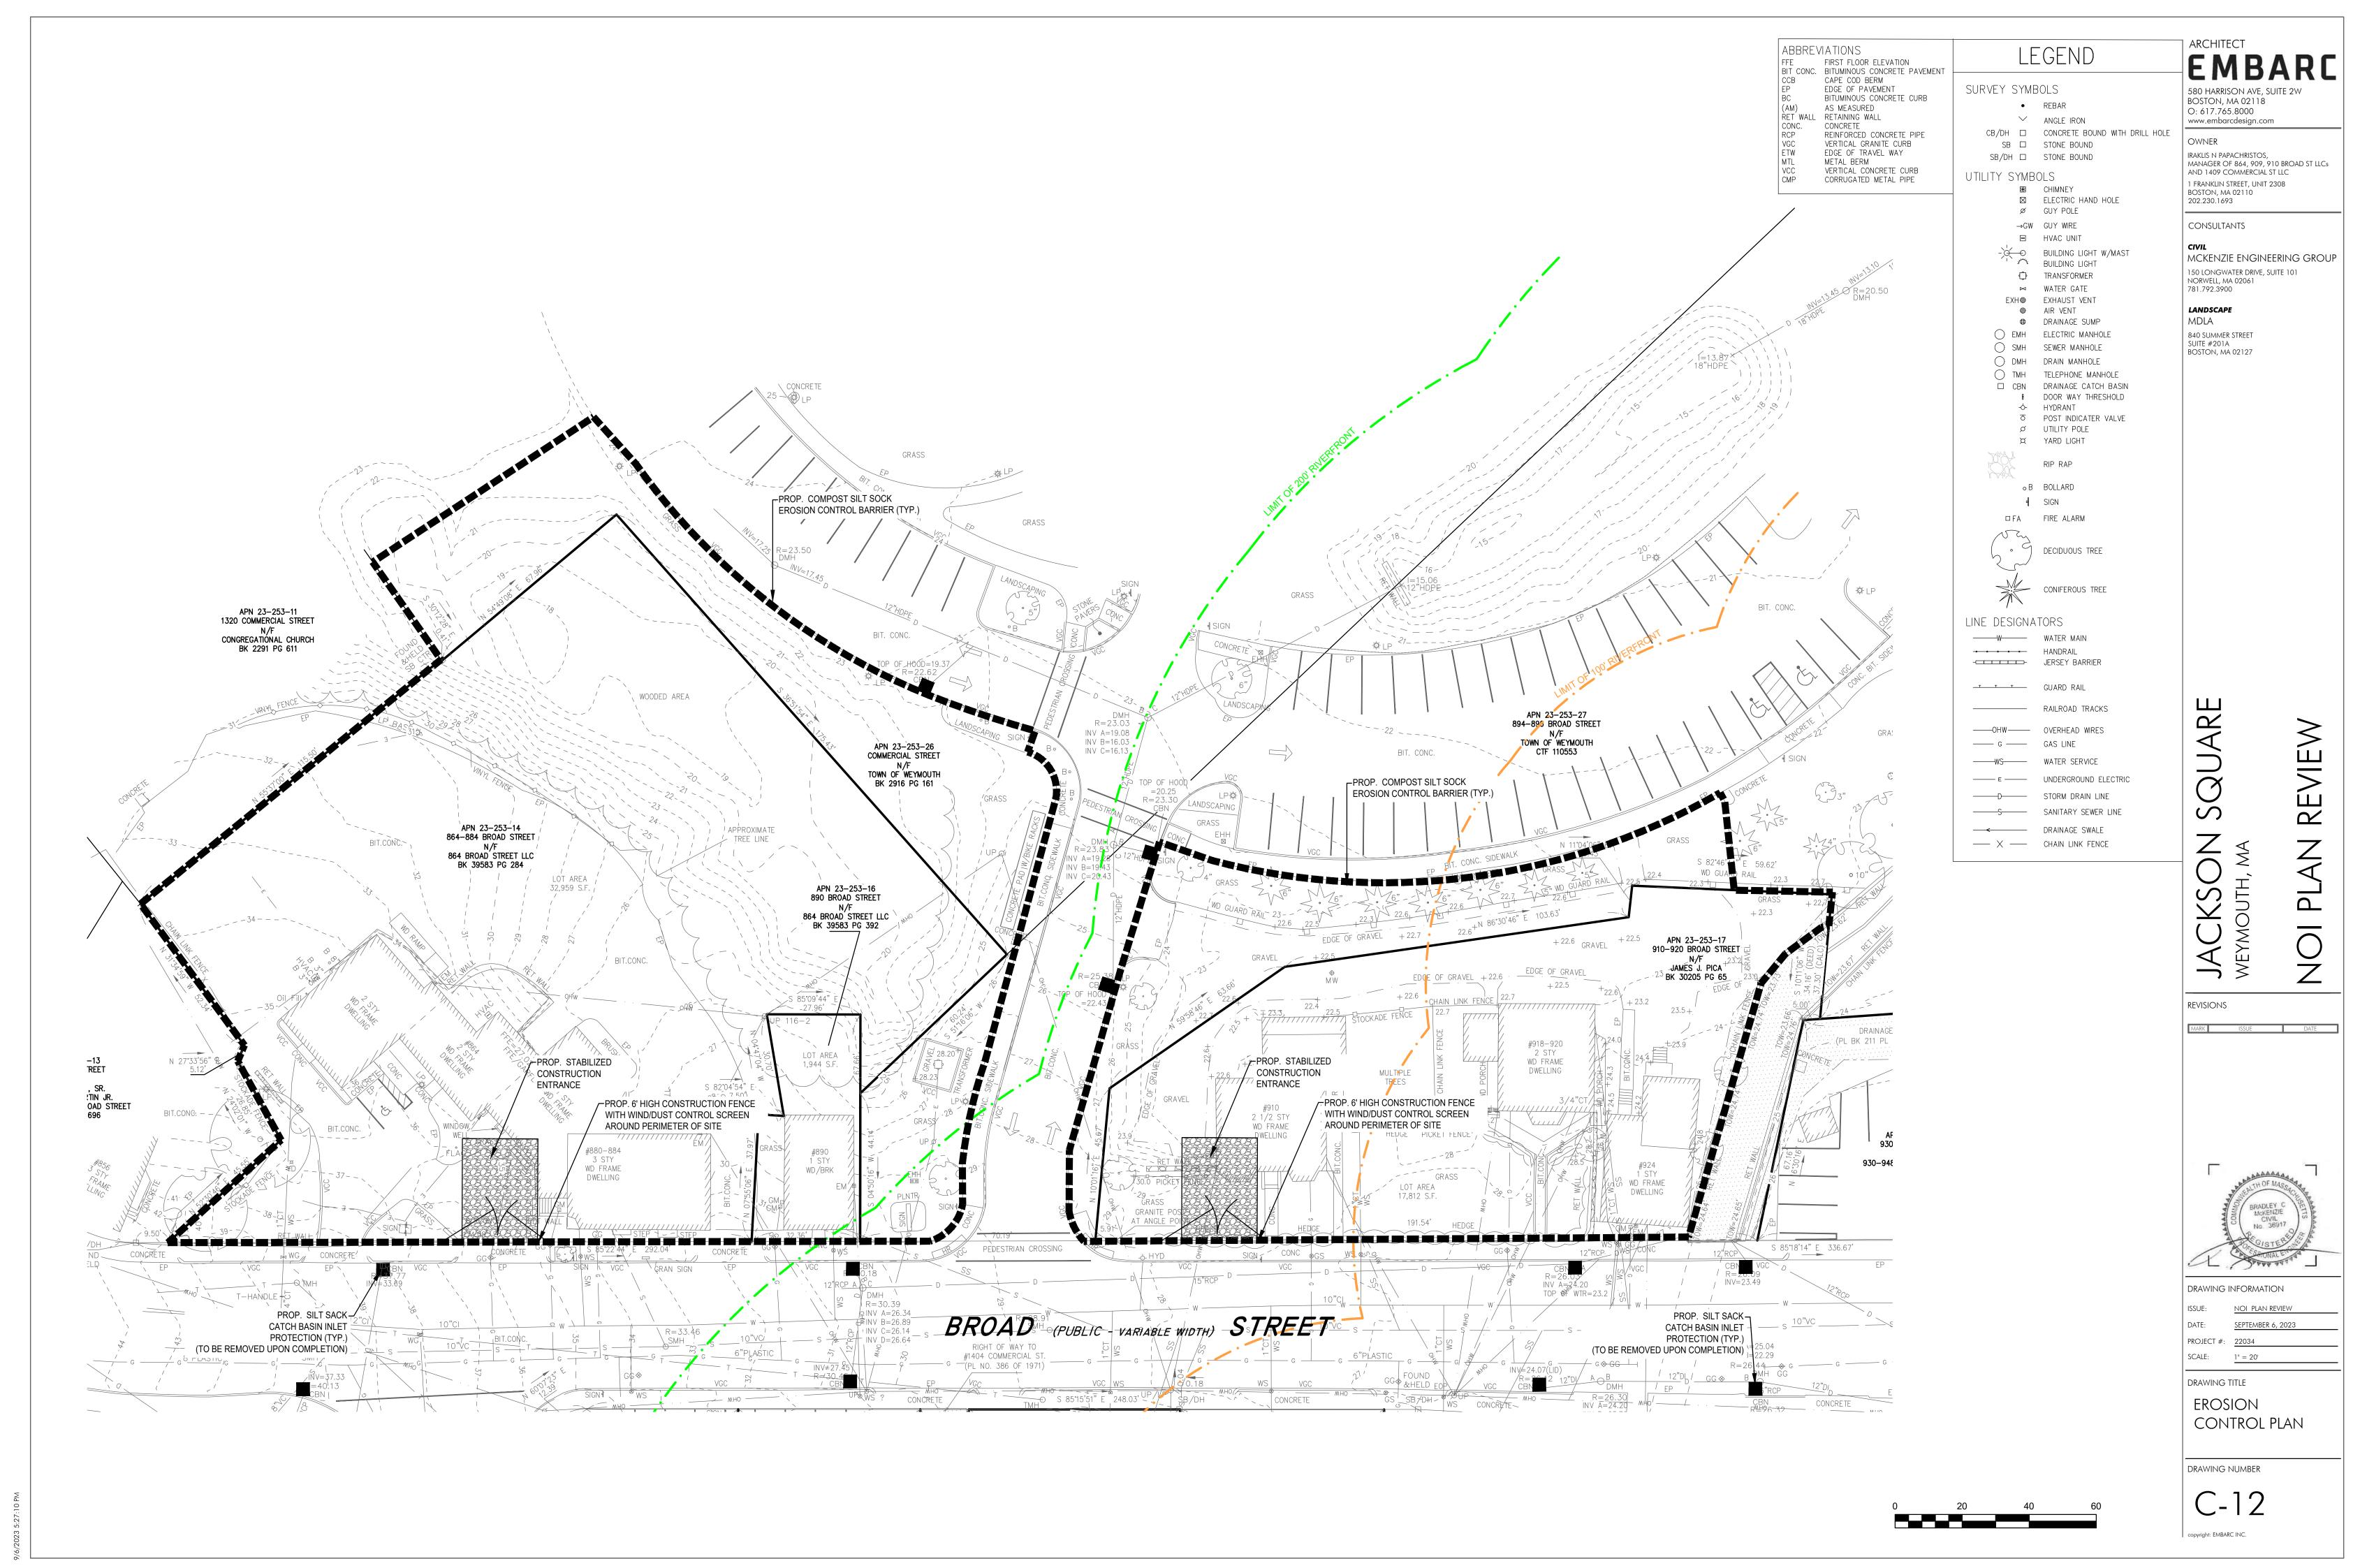


TO PREVENT EXCESSIVE EROSION AND SILTING, THE FOLLOWING CONSTRUCTION SEQUENCE COUPLED WITH OTHER WIDELY ACCEPTED PRINCIPALS FOR REDUCING EROSION AND SEDIMENTATION SHALL BE IMPLEMENTED IN THE DEVELOPMENT OF THE SITE.

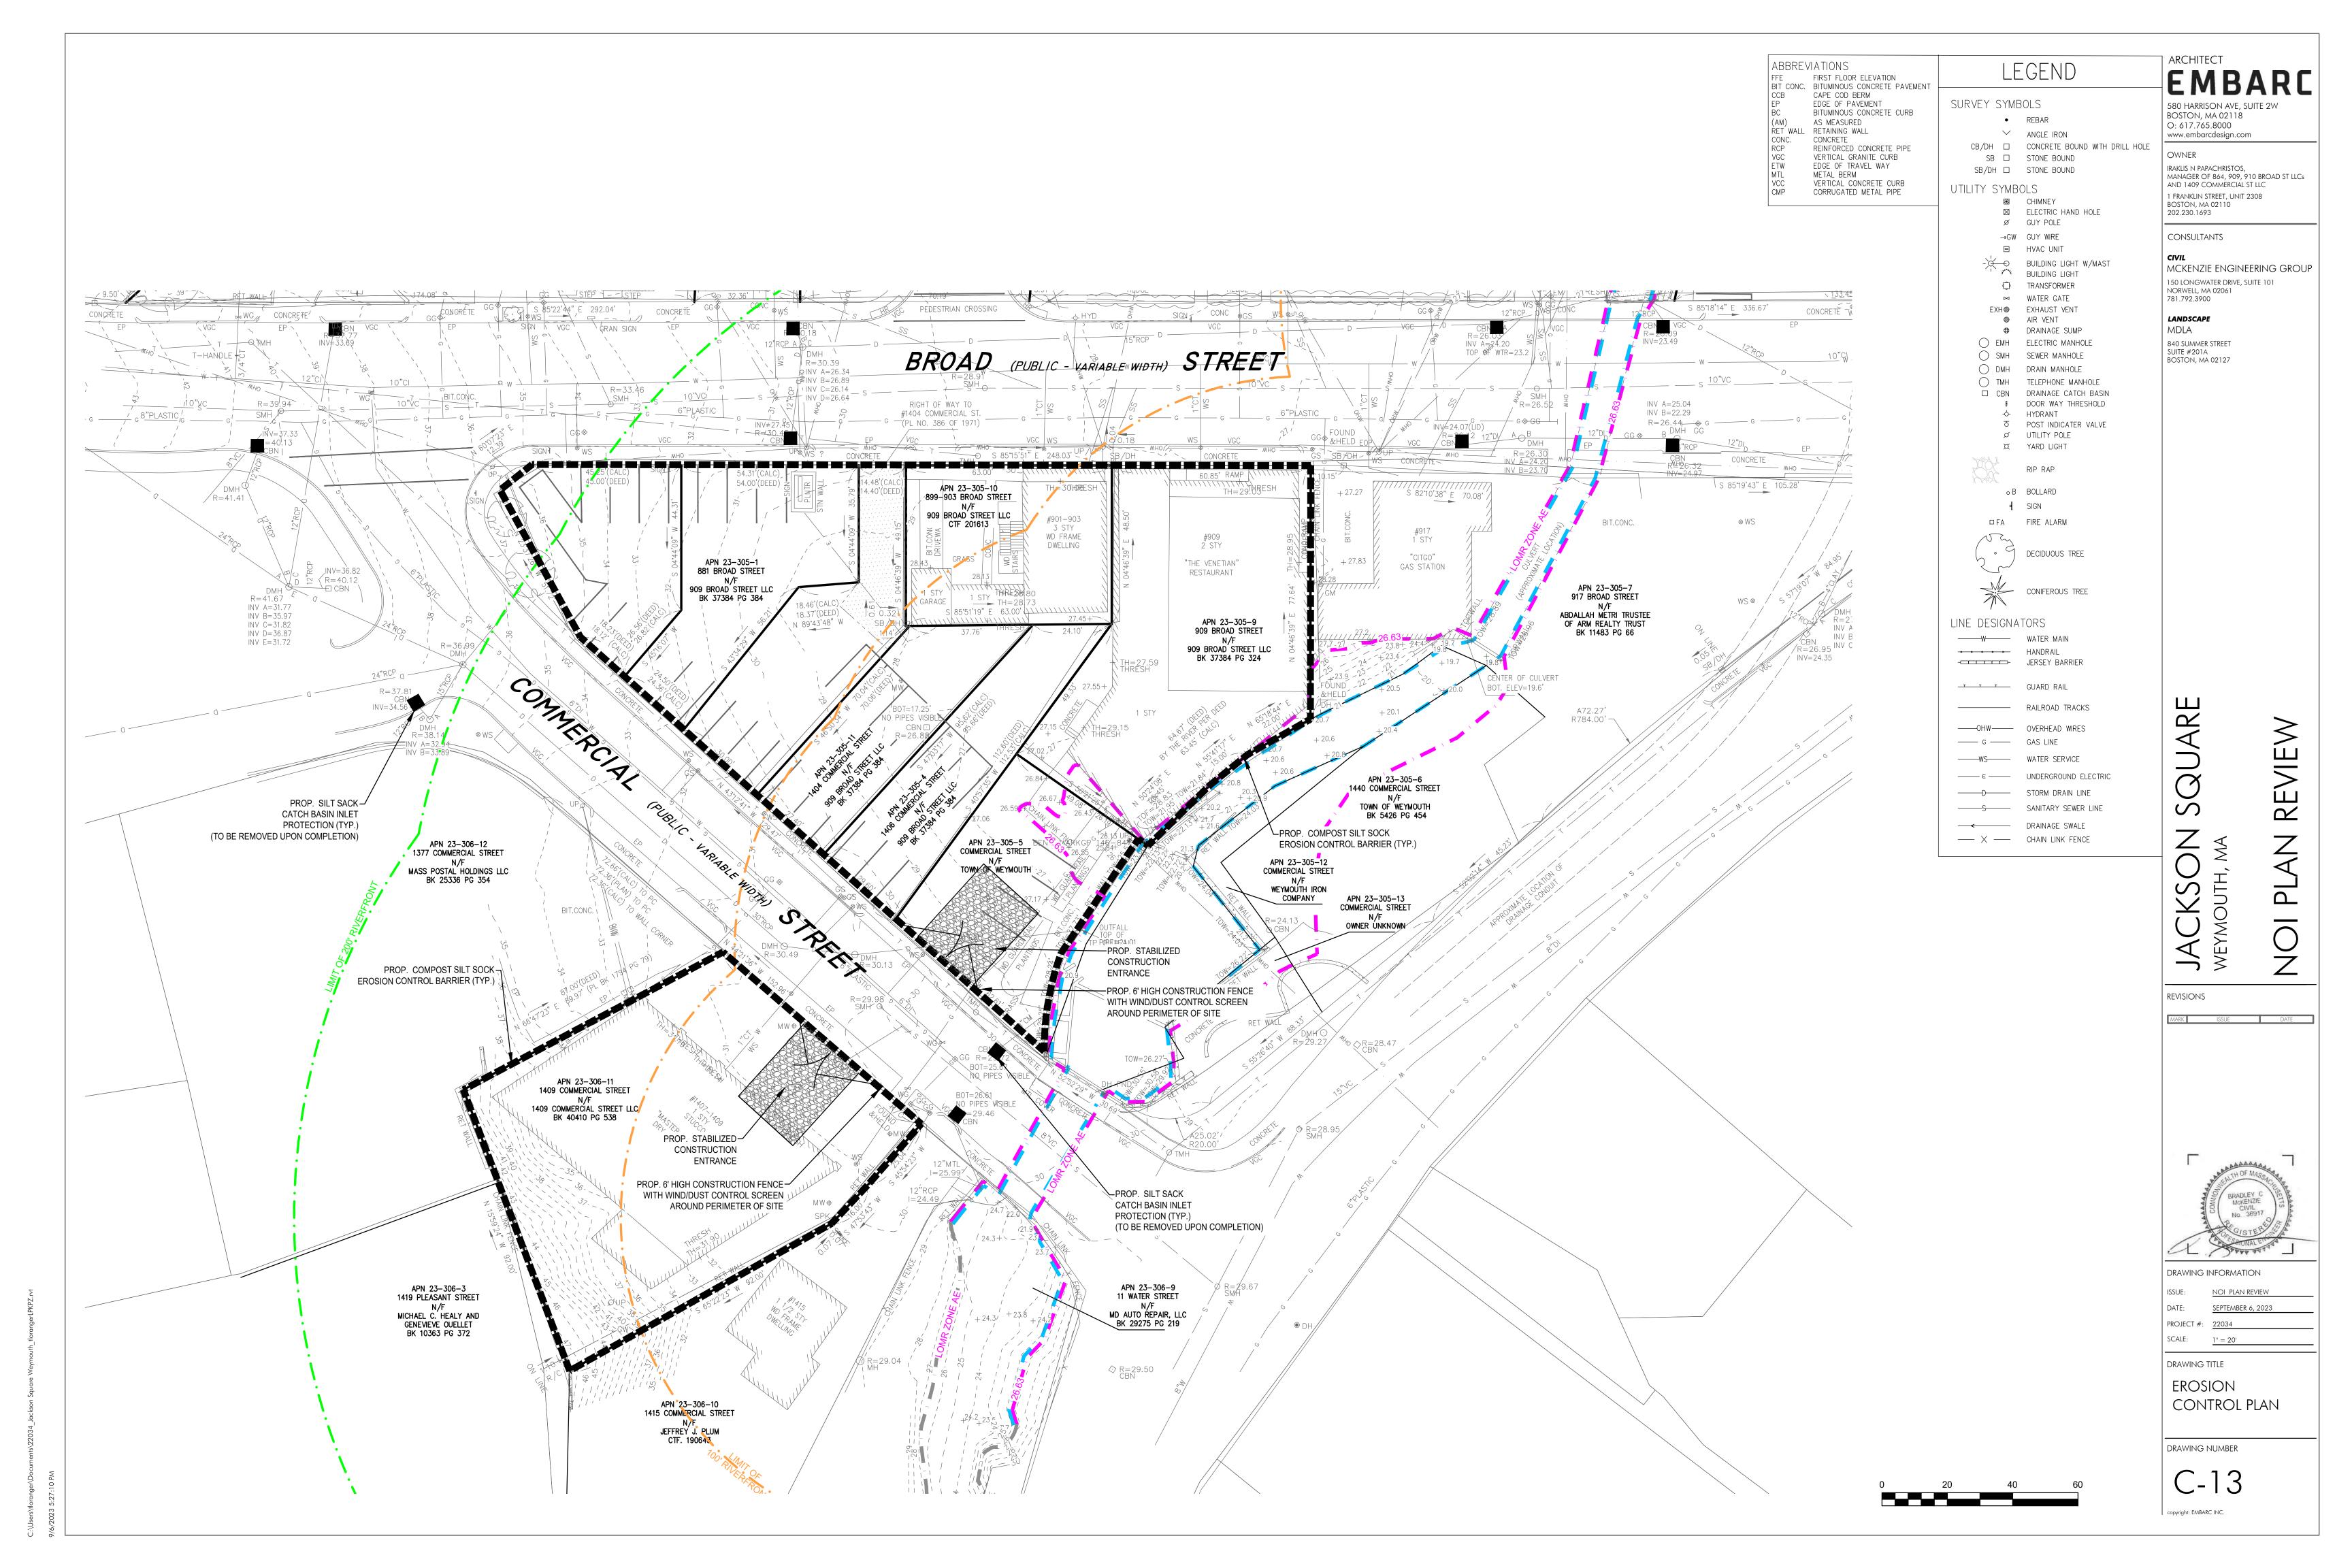- 1. THE CONTRACTOR SHALL COORDINATE A PRE-CONSTRUCTION MEETING PRIOR TO ANY CONSTRUCTION ACTIVITY.
- 2. STABILIZATION PRACTICES FOR EROSION AND SEDIMENT CONTROL SHALL BE INSTALLED PRIOR TO COMMENCING CONSTRUCTION ACTIVITIES. REFER TO "EROSION AND SEDIMENTATION CONTROL" SECTION OF THIS PLAN. CONSTRUCT STABILIZED CONSTRUCTION ENTRANCE AT BROAD STREET AND COMMERCIAL STREET.
- 3. CLEAR AND GRUB UP AS REQUIRED FOR THE CONSTRUCTION OF THE BUILDING AND RELATED INFRASTRUCTURE.
- 4. EXCAVATE TOPSOIL AND SUBSOIL FROM CUT AND FILL AREAS AND STOCKPILE OFF SITE.
- 5. CONSTRUCT CUT AND FILL AREAS. ALL FILL WILL BE INSTALLED USING 12" MAXIMUM COMPACTION LIFTS. PLACE ALL SLOPE PROTECTION WHERE INDICATED ON THE PLAN.
- 6. INSTALL CLOSED DRAINAGE SYSTEM AND OTHER UTILITIES. ALL CATCH BASINS SHALL BE COVERED WITH SILT SACK OR EQUIVALENT INLET PROTECTION.
- 7. GRADE SITE TO SUBGRADE ELEVATIONS AND CONSTRUCT SIDE SLOPES. APPLY TEMPORARY STABILIZATION MEASURES WHERE WARRANTED. REFER TO "EROSION AND SEDIMENTATION CONTROL" SECTION OF THIS PLAN.
- 8. GRADE SLOPES AND STABILIZE CUT AREAS AT TOE OF SLOPES. BLEND ALL INTO EXITING TOPOGRAPHY AND LOAM AND SEED ALL DISTURBED AREAS. SLOPES GREATER THAN 3:1 SHALL BE STABILIZED WITH JUTE MESH.
- 9. COMPLETE FINE GRADING OF SITE AND SIDEWALK CONSTRUCTION.
- 10. REMOVE TEMPORARY EROSION CONTROL DEVICES ONCE ADEQUATE GROWTH IS ESTABLISHED. ADEQUATE GROWTH IS DEFINED AS VEGETATION COVERING 75% OR MORE OF THE GROUND SURFACE

EROSION AND SEDIMENTATION CONTROL

REFER TO MASS DEP STORMWATER MANAGEMENT HANDBOOK FOR SPECIFICATIONS AND STRUCTURAL AND DUST CONTROL EROSION BEST MANAGEMENT PRACTICES.

- 1. STRUCTURAL PRACTICES UTILIZED FOR THE PROJECT WILL INCLUDE SILT SOCK BARRIER CONTROLS, STABILIZED CONSTRUCTION ENTRANCE, TEMPORARY DIVERSION SWALES WITH STONE CHECK DAMS, SEDIMENT BASINS, AND INLET PROTECTION SUBJECT TO CITY OF WEYMOUTH ENGINEERING APPROVAL.
- 2. STABILIZATION PRACTICES UTILIZED FOR THE PROJECT WILL INCLUDE TEMPORARY SEEDING, GEOTEXTILES (JUTE MESH), MULCHING, AND PERMANENT SEEDING.
- 3. IN GENERAL, THE SMALLEST POSSIBLE AREA OF LAND SHOULD BE EXPOSED AT ONE TIME. WHEN LAND IS EXPOSED DURING DEVELOPMENT, THE EXPOSURE SHALL BE CONFINED TO A MAXIMUM PERIOD OF 3 MONTHS. LAND SHALL NOT BE EXPOSED DURING THE WINTER MONTHS. ANY DISTURBED AREAS WHICH ARE TO BE LEFT TEMPORARILY AND THAT WILL BE REGRADED AT A LATER DATE SHALL BE MACHINE HAY MULCHED AND SEEDED WITH WINTER RYE TO PREVENT EROSION.

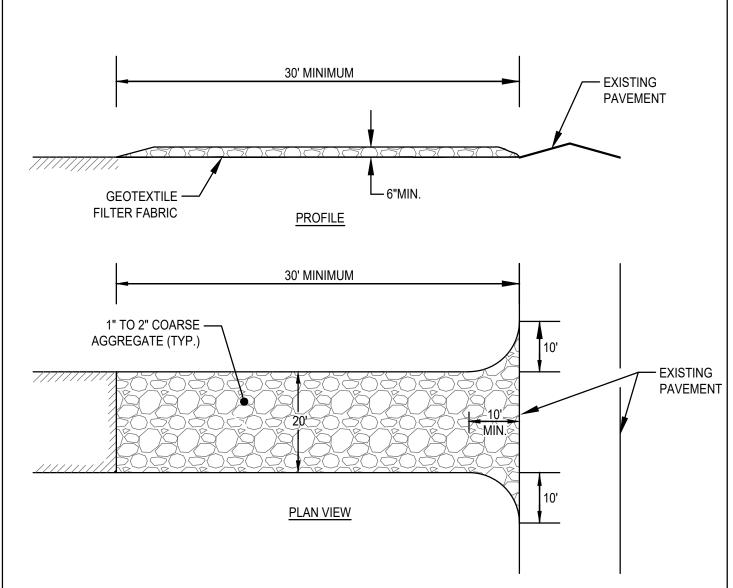


(SCE) CONSTRUCTION SPECIFICATIONS


- 1. STONE FOR A STABILIZATION CONSTRUCTION ENTRANCE SHALL BE 1 TO 2 INCH STONE, RECLAIMED STONE.
- 2. THE LENGTH OF THE STABILIZED ENTRANCE SHALL NOT BE LESS THAN 50 FEET, EXCEPT FOR A SINGLE RESIDENTIAL LOT A 30 FOOT MINIMUM LENGTH WOULD APPLY.
- EXCEPT FOR A SINGLE RESIDENTIAL LOT A 30 FOOT MINIMUM LENGTH WOULD APPLY.
 THE THICKNESS OF THE STONE FOR THE STABILIZED ENTRANCE SHALL NOT BE LESS THAN 6 INCHES.
- 4. THE WIDTH OF THE ENTRANCE SHALL NOT BE LESS THAN A FULL WIDTH OF THE ENTRANCE WHERE INGRESS OR EGRESS OCCURS OR 10 FEET, WHICH EVER IS GREATER.
- 5. GEOTEXTILE FILTER CLOTH SHALL BE PLACED OVER THE ENTIRE AREA PRIOR TO PLACING THE STONE.
- 6. ALL SURFACE WATER THAT IS FLOWING TO OR DEVERTED TOWARDS THE CONSTRUCTION ENTRANCE SHALL BE PIPED BENEATH THE ENTRANCE. IF PIPING IS IMPRACTICAL, A BERM WITH 5:1 SLOPES THAT CAN BE CROSSED BY VEHICLES MAY BE SUBSTITUTED FOR THE PIPE.
- 7. THE ENTRANCE SHALL BE MAINTAINED IN A CONDITION THAT WILL PREVENT TRACKING OR FLOWING OF SEDIMENT ONTO PUBLIC RIGHTS-OF-WAY. THIS MAY REQUIRE PERIODIC TOPDRESSING WITH ADDITIONAL STONE AS CONDITIONS DEMAND AND REPAIR AND/OR CLEANOUT OF ANY MEASURES USED TO TRAP SEDIMENT. SEDIMENT SPILLED, WASHED, OR TRACKED ONTO PUBLIC RIGHTS-OF-WAY MUST BE REMOVED PROMPTLY.


STABILIZED CONSTRUCTION ENTRANCE (SCE) DETAIL

CONSTRUCTION PHASE BMP OPERATION AND MAINTENANCE NOTES:

- 1. REFER TO THE STORMWATER POLLUTION PREVENTION PLAN (SWPPP) PREPARED UNDER THE E.P.A. GENERAL CONSTRUCTION PERMIT PROVISIONS FOR FURTHER DETAIL OF STRUCTURAL, STABILIZATION, DUST CONTROL AND EROSION AND SEDIMENTATION CONTROL MEASURES.
- STRUCTURAL PRACTICES UTILIZED FOR THE PROJECT WILL INCLUDE EROSION CONTROL BARRIERS, STABILIZED CONSTRUCTION ENTRANCES, TEMPORARY DIVERSION SWALES WITH CHECK DAMS, SEDIMENT BASINS, AND INLET PROTECTION.
- 3. STABILIZATION PRACTICES UTILIZED FOR THE PROJECT WILL INCLUDE TEMPORARY SEEDING, GEOTEXTILES (JUTE MESH), MULCHING, AND PERMANENT SEEDING.
- 4. OPERATOR PERSONNEL MUST INSPECT THE CONSTRUCTION SITE AT LEAST ONCE EVERY 14 CALENDAR DAYS AND WITHIN 24 HOURS OF A STORM EVENT OF 1/2 INCH OR GREATER. THE INSPECTOR SHOULD REVIEW THE EROSION AND SEDIMENT CONTROLS WITH RESPECT TO THE FOLLOWING:
- A. WHETHER OR NOT THE MEASURE WAS INSTALLED/PERFORMED CORRECTLY.
 B. WHETHER OR NOT THERE HAS BEEN DAMAGE TO THE MEASURE SINCE IT INSTALLED OR PERFORMED.
- C. WHAT SHOULD BE DONE TO CORRECT ANY PROBLEMS WITH THE MEASURE.
- 5. THE INSPECTOR SHALL COMPLETE THE INSPECTION SCHEDULE AND EVALUATION CHECKLIST FOR FINDINGS AND SHOULD REQUEST THE REQUIRED MAINTENANCE OR REPAIR. THE CHECKLIST IS PROVIDED WITHIN THE OPERATION AND MAINTENANCE PLAN.
- 6. THE TEMPORARY BASINS SHALL BE INSPECTED AND CLEANED IF REQUIRED PRIOR TO ANY PREDICTED LARGE STORM EVENT.

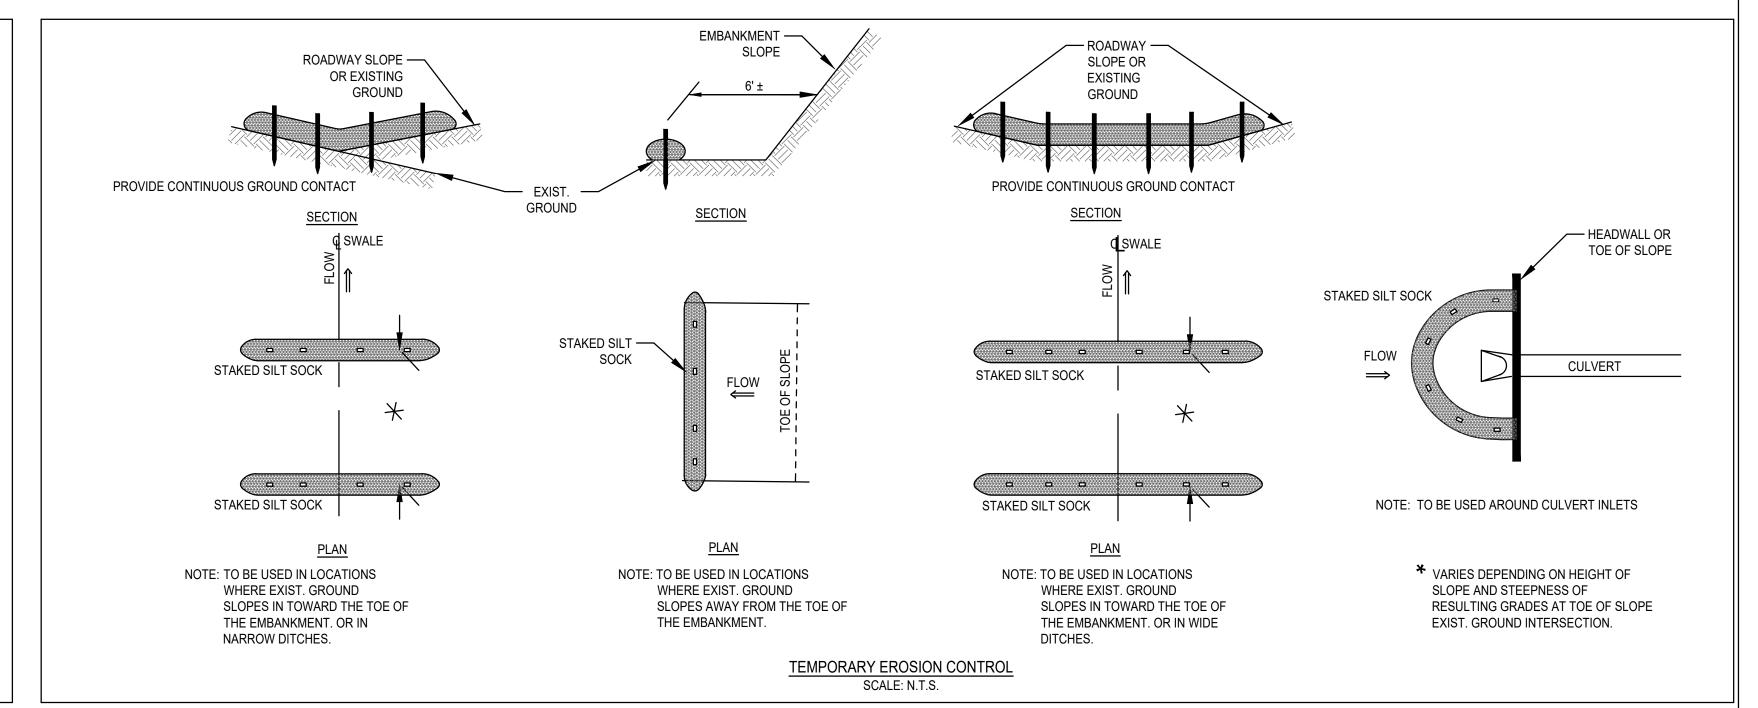

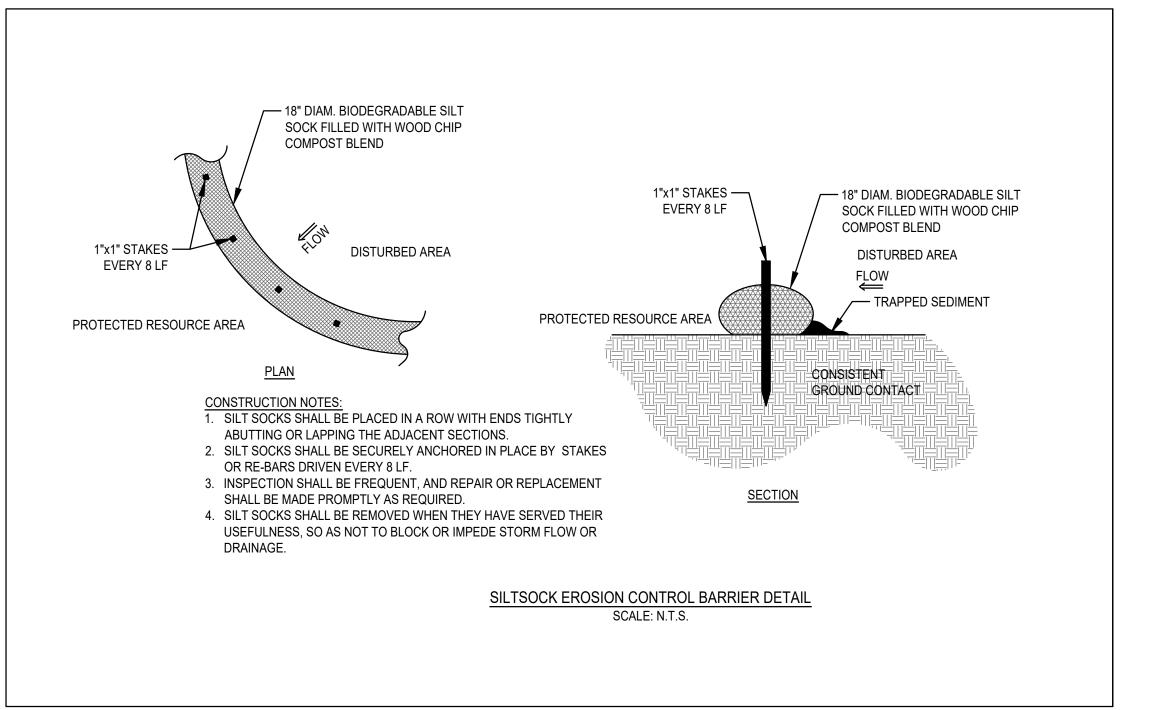

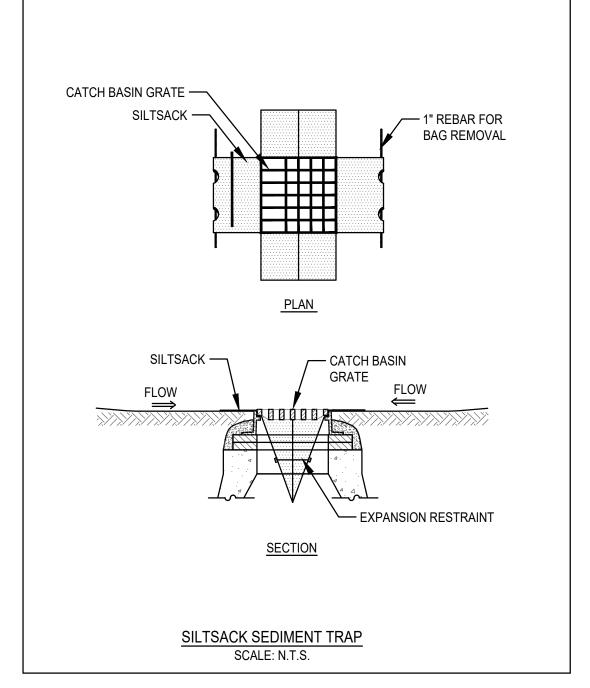

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CONSULTANTS

OWNER

MCKENZIE ENGINEERING GROUP

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NORWELL, MA 02061

781.792.3900

LANDSCAPE
MDLA

840 SUMMER STREET
SUITE #2014

840 SUMMER STREET SUITE #201A BOSTON, MA 02127



DRAWING INFORMATION

ISSUE: NOI PLAN REVIEW

DATE: SEPTEMBER 6, 2023

PROJECT #: 22034
SCALE: AS NOTED

DRAWING TITLE

EROSION

CONTROL PLAN

DRAWING NUMBER

C-14

copyright: EMBARC INC.

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TOWN STANDARDS

FLUSH GRANITE CURB BORDER


SYM.	QTY.	LATIN NAME	COMMON NAME	SIZE	NOTES
TREE	S				
		T	1	I	
AF	17	ACER X FREEMANII 'ARMSTRONG'	ARMSTRONG RED MAPLE	2.5"-3" CAL.	B&B, 6' CLEAR BRANCHING
AR	5	ACER RUBRUM 'RED SUNSET'	RED SUNSET MAPLE	2.5"-3" CAL.	B&B, 6' CLEAR BRANCHING
AS	16	AMELANCHIER 'AUTUMN BRILLIANCE'	SERVICEBERRY	6-7' TALL	B&B, MULTI-STEM
BN	2	BETULA NIGRA 'HERITAGE'	HERITAGE RIVER BIRCH	8-10' TALL	B&B, MULTI-STEM
<u>CB</u>	7	CARPINUS BETULUS 'FRANS FONTAINE'	FRANS FONTAINE HORNBEAM	6-7' TALL	B&B, MATCHED
CC	7	CERCIS CANADENSIS	EASTERN REDBUD	6-7' TALL	B&B, SINGLE AND MULTI-STEN
GT	6	GLEDITSEA TRICANTHOS 'SKYLINE'	SKYLINE HONEYLOCUST	2.5"-3" CAL.	B&B, 6' CLEAR BRANCHING
JV	2	JUNIPERUS VIRGINIANA	EASTERN RED CEDAR	8'-10' TALL	B&B, MATCHED
LT	2	LIRIODENDRON TULIPIFERA	TULIP TREE	2.5"-3" CAL.	B&B, 6' CLEAR BRANCHING
NS	2	NYSSA SYLVATICA	BLACK GUM	2.5"-3" CAL.	B&B, 6' CLEAR BRANCHING
PS	7	PINUS STROBUS	EASTERN WHITE PINE	8'-10' TALL	B&B, MATCHED
QB	3	QUERCUS BICOLOR	SWAMP WHITE OAK	2.5"-3" CAL.	B&B, 6' CLEAR BRANCHING
QP	1	QUERCUS PALUSTRIS 'PRINGREEN'	GREEN PILLAR OAK	2.5"-3" CAL.	B&B, 6' CLEAR BRANCHING
QR	3	QUERCUS RUBRA	RED OAK	2.5"-3" CAL.	B&B, MATCHED
SA	4	SWIDA ALTERNIFOLIA	PAGODA DOGWOOD	8'-10' TALL	B&B, MATCHED
TO	42	THUJA OCCIDENTALIS 'EMERALD GREEN'	EMERALD GREEN ARBORVITAE	8'-10' TALL	B&B, MATCHED
TP	3	THUJA OCCIDENTALIS 'GREEN GIANT'	GREEN GIANT ARBORVITAE	8'-10' TALL	B&B, MATCHED
SHRL	JBS PAL				
AM	11	ARONIA MELANOCARPA	BLACK CHOKEBERRY	3 GALLON	36" O.C. B&B
CA	32	CLETHERA ALNIFOLIA	SUMMERSWEET	3 GALLON	36" O.C. B&B
CO	22	COMPTONIA PEREGRINA	SWEET FERN	3 GALLON	36" O.C. B&B
CS	19	CORNUS SERICEA 'ARCTIC FIRE'	ARCTIC FIRE DOGWOOD	3 GALLON	36" O.C. B&B
IG	100	ILEX GLABRA	INKBERRY	3 GALLON	36" O.C. B&B
IV	56	ILEX VERTICILLATA	WINTERBERRY	3 GALLON	36" O.C. B&B
MP	49	MYRICA PENSYLVANICA	NORTHERN BAYBERRY	3 GALLON	36" O.C. B&B
RA	61	RHUS AROMATICA 'GRO LOW'	GRO LOW SUMAC	3 GALLON	36" O.C. B&B
TD	45	TAXUS X MEDIA 'DENSIFORMIS'	DENSIFORMIS YEW	3 GALLON	36" O.C. B&B
TM	33	TAXUS X MEDIA 'HICKSII'	HICKS YEW	3 GALLON	36" O.C. B&B
VA	20	VIBURNUM ACERIFOLIUM	MAPLE LEAF VIBURNUM	3 GALLON	36" O.C. B&B
VC	12	VACCINIUM CORYMBOSUM	HIGH BUSH BLUEBERRY	3 GALLON	36" O.C. B&B
VD	6	VIBURNUM DENTATUM	NORTHERN ARROWWOOD	3 GALLON	36" O.C. B&B
PERE	NNIALS	AND GRASSES PALETTE			
AC	92	ASTILBE CHINESIS 'VISION IN WHITE'	VISION IN WHITE ASTILBE	1 GAL	18" O.C. CONTAINER
CP	354	CAREX PENSYLVANICA	PENNSYLVANIA SEDGE	1 GAL	18" O.C. CONTAINER
DP	178	DENNSTAEDTIA PUNCTILOBULA	HAYCENTED FERN	1 GAL	18" O.C. CONTAINER
EP	117	ECHINACEA PURPUREA	PURPLE CONEFLOWER	1 GAL	18" O.C. CONTAINER
NW	9	NEPETA X FAASSENII 'WALKERS LOW'	CATMINT	1 GAL	18" O.C. CONTAINER
PH	237	PENNISETUM ALOPECUROIDES 'HAMELN'	DWARF FOUNTAIN GRASS	2 GAL	24" O.C. CONTAINER
PL	25	PEROVSKIA A. 'LITTLE SPIRE'	LITTLE SPIRE RUSSIAN SAGE	1 GAL	18" O.C. CONTAINER
PV	146	PANICUM VIRGATUM 'SHENANDOAH'	SWITCH GRASS	2 GAL	30" O.C. CONTAINER
RF	138	RUDBECKIA FULGIDA 'GOLDSTURM'	BLACK EYE SUSAN	1 GAL	18" O.C. CONTAINER
SN	190	SYMPHYOTRICHUM NOVAE-ANGLIAE	NEW ENGLAND ASTER	1 GAL	18" O.C. CONTAINER
_					

FINAL SELECTION OF PLANTINGS WILL BE MADE FROM THE SPECIES LISTED IN EACH CATEGORY OF PLANT TYPE ABOVE 2. PLANT TYPES NOTED WITH "*" ARE INCLUDED IN THE 20' WIDE LANDSCAPE BUFFER ALONG HERRING RUN BROOK, SEE PLANS FOR QUANTITIES.

LIGHT SCH	HEDULE					
SYMBOL	LABEL	MODEL	MOUNT	DESCRIPTION	OPTIONS	REP
	EX	COOPER LIGHTING - FIXTURE: ANE-10S-X-4-33-2 POLE/BASE: DEA714PU	CONCRETE FOOTING; KEEP 3" ABOVE GRADE	SINGLE	COLOR: BLK	ILLUMINATE 617-947-8996 STEVE PRUDHOMME
	SW1	MP LIGHTING - RECESSED WALL LIGHT L368-8W30HNC-S6	WALL LIGHT	SINGLE	COLOR: S.S.	
-	W1	BEGA LED WALL LUMINAIRES 24219-K3-BLK	BUILDING MOUNT	SINGLE	COLOR: BLK	
-	W2	BEGA LED WALL LUMINAIRES 24243-K3-BLK	BUILDING MOUNT	SINGLE	COLOR: BLK	

2. STREETSCAPE LIGHTING (FIXTURE "EX") TO BE COORDINATED WITH TOWN ENGINEER

LEGEND 100' RIVERFRONT AREA 200' RIVERFRONT AREA LIMIT OF HERRING BROOK FEMA 100-YEAR FLOODPLAIN PROPERTY LINE LIMIT OF WORK _____

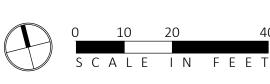

NOT FOR CONSTRUCTION

DRAWING NUMBER copyright: EMBARC INC.

DRAWING INFORMATION

DRAWING TITLE

LANDSCAPE

PLANTING AND

LIGHTING PLAN

REVISIONS

ARCHITECT

580 HARRISON AVE, SUITE 2W

MANAGER OF 864, 909, 910 BROAD ST LLCs AND 1409 COMMERCIAL ST LLC

MCKENZIE ENGINEERING GROUP

150 LONGWATER DRIVE, SUITE 101 NORWELL, MA 02061

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LANDSCAPE MDLA

840 SUMMER STREET SUITE #201A

1 FRANKLIN STREET, UNIT 2308

OWNER

LANDSCAPE PLANTING AND LIGHTING ENLARGEMENT

GRANITE CURBING, SEE CIVIL —

BOSTON, MA 02127 SPRING: OAT ARE

800-873-3321 (ERNMX-132-1)

1. SUBMIT CUT SHEETS FOR APPROVAL; SEE PHOTOMETRIC PLAN PROVIDED WITH THIS DRAWING SET FOR MORE INFORMATION.

617-947-8996 STEVE PRUDHOMME MP LIGHTING - RECESSED WALL LIGHT WALL LIGHT SINGLE COLOR: S.S. L368-8W30HNC-S6


SUBMIT CUT SHEETS FOR APPROVAL; SEE PHOTOMETRIC PLAN PROVIDED WITH THIS DRAWING SET FOR MORE INFORMATION.

2. STREETSCAPE LIGHTING (FIXTURE "EX") TO BE COORDINATED WITH TOWN ENGINEER

LEGEND 100' RIVERFRONT AREA 200' RIVERFRONT AREA LIMIT OF HERRING BROOK FEMA 100-YEAR FLOODPLAIN PROPERTY LINE LIMIT OF WORK _____

NOT FOR CONSTRUCTION

S C A L E I N F E

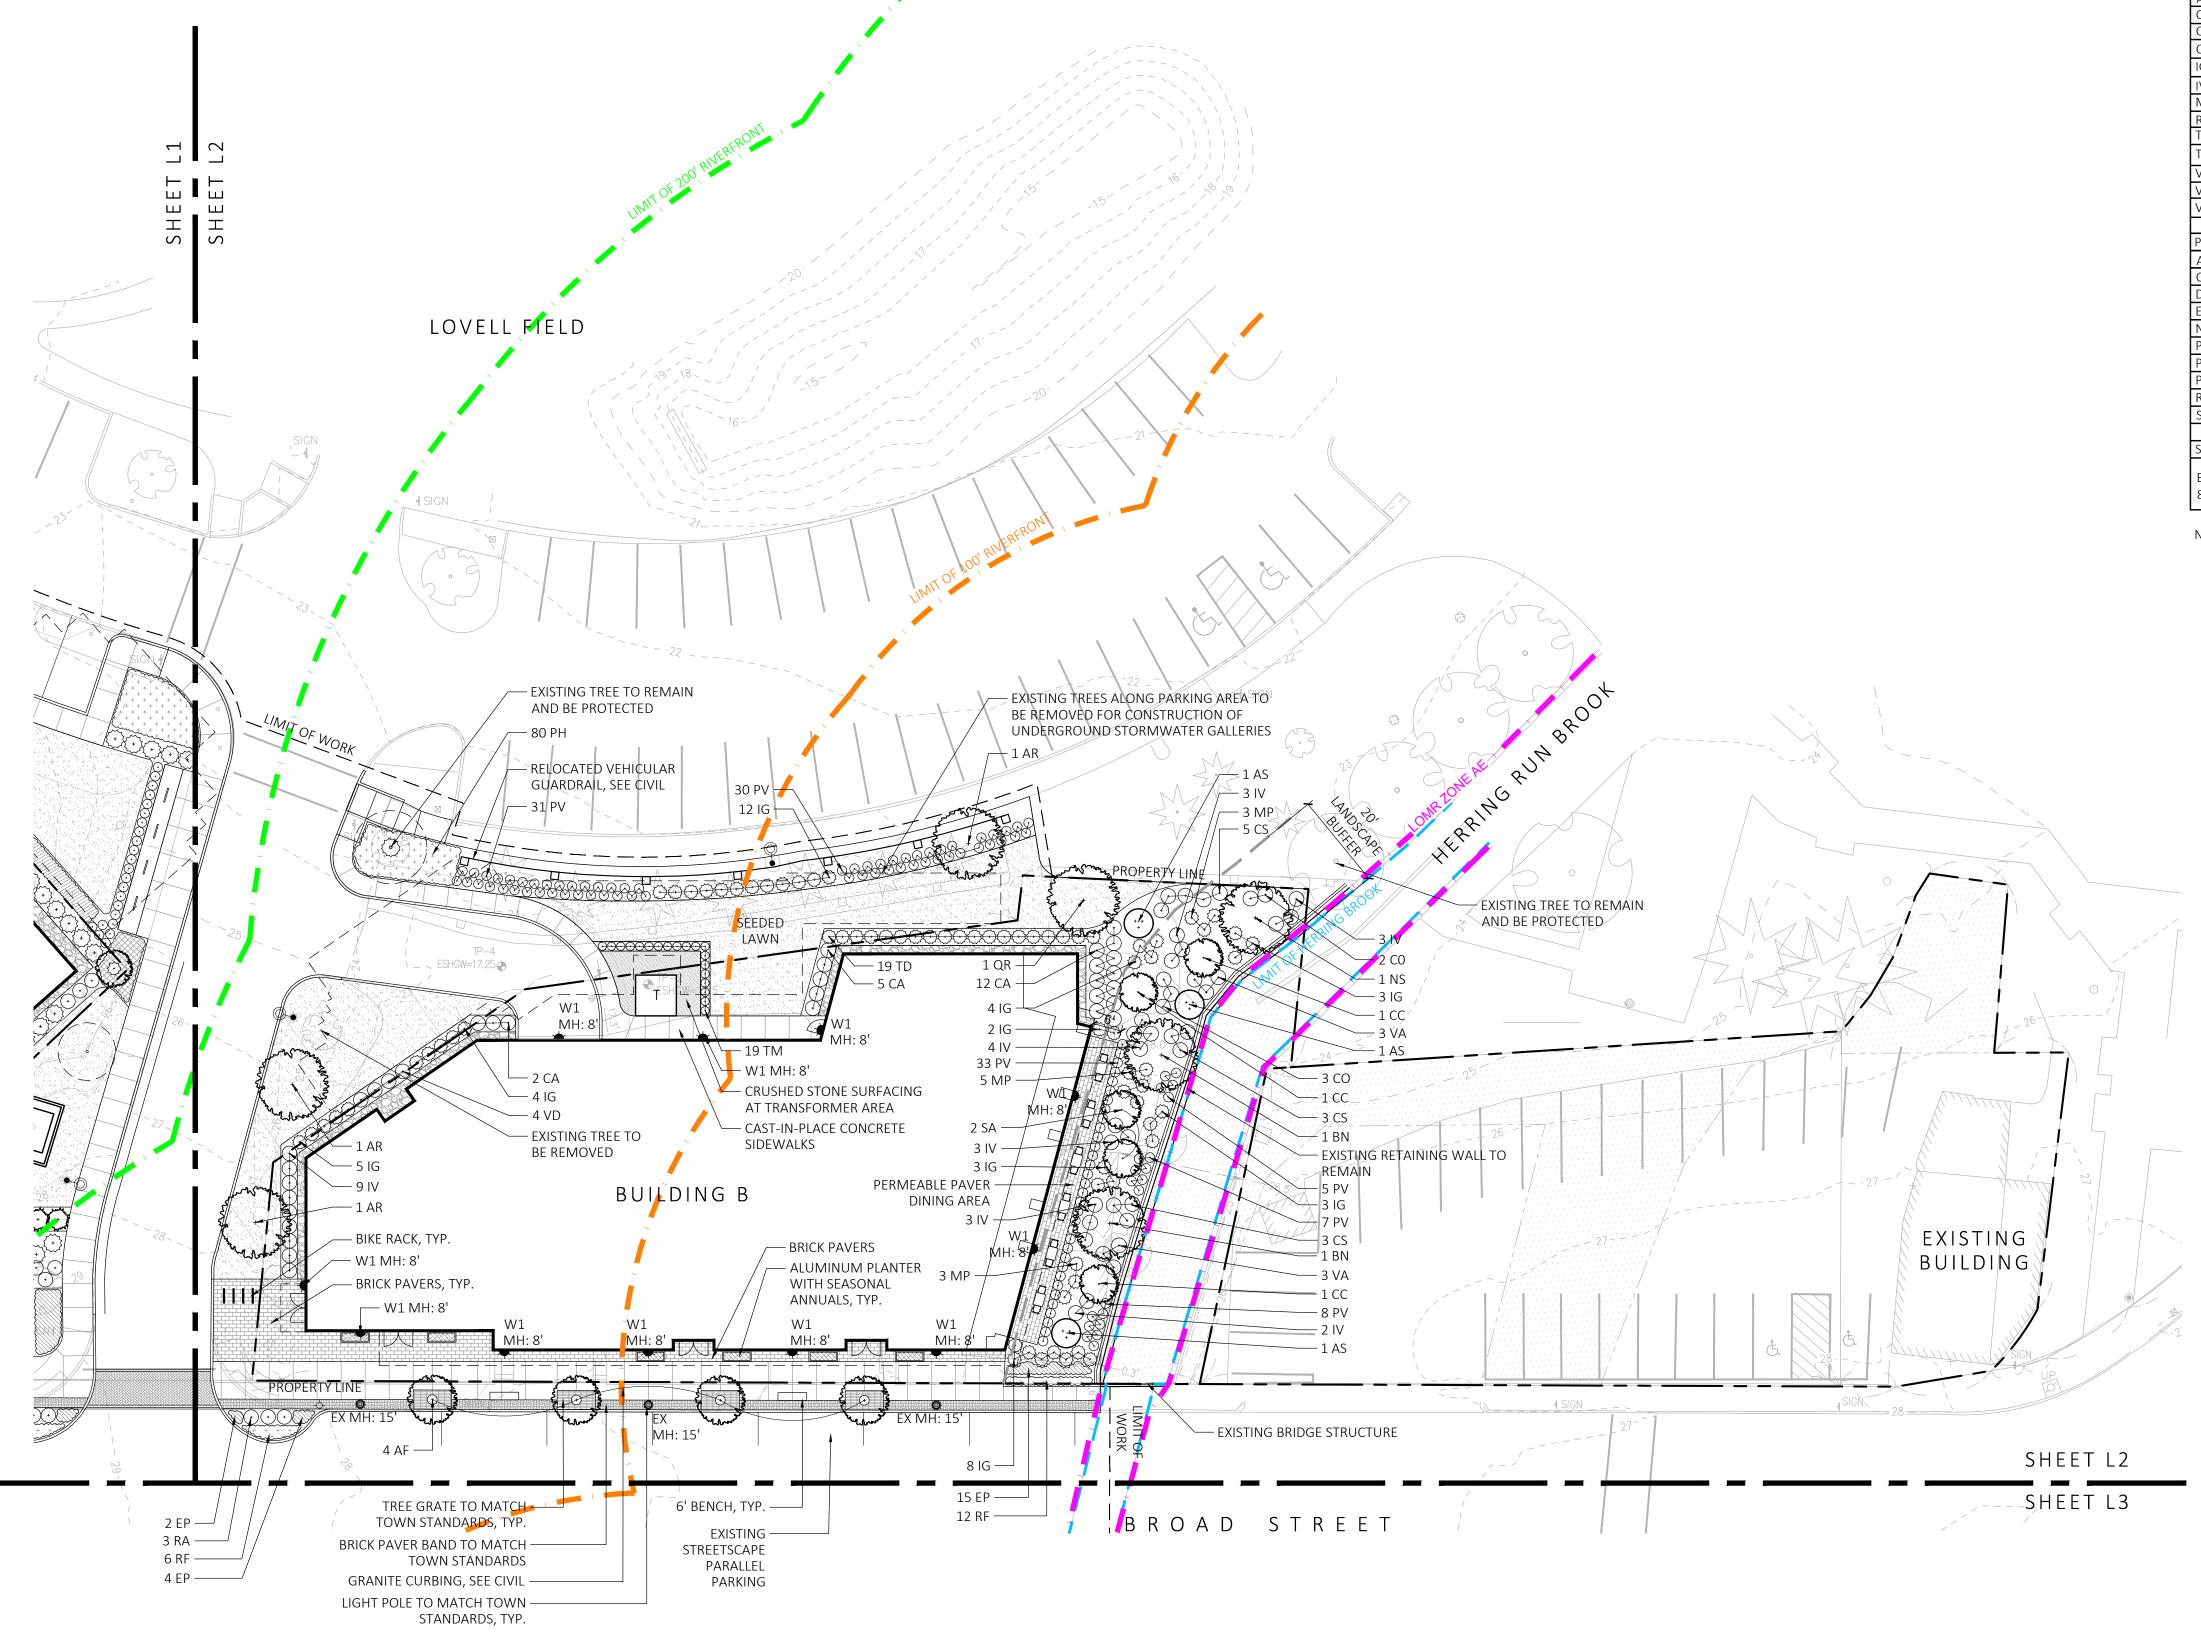

LANDSCAPE PLANTING AND LIGHTING ENLARGEMENT

2. PLANT TYPES NOTED WITH "*" ARE INCLUDED IN THE 20' WIDE LANDSCAPE BUFFER ALONG HERRING RUN BROOK, SEE PLANS FOR

BEGA LED WALL LUMINAIRES **BUILDING MOUNT** SINGLE COLOR: BLK 24219-K3-BLK BEGA LED WALL LUMINAIRES **BUILDING MOUNT** COLOR: BLK SINGLE 24243-K3-BLK

REVISIONS

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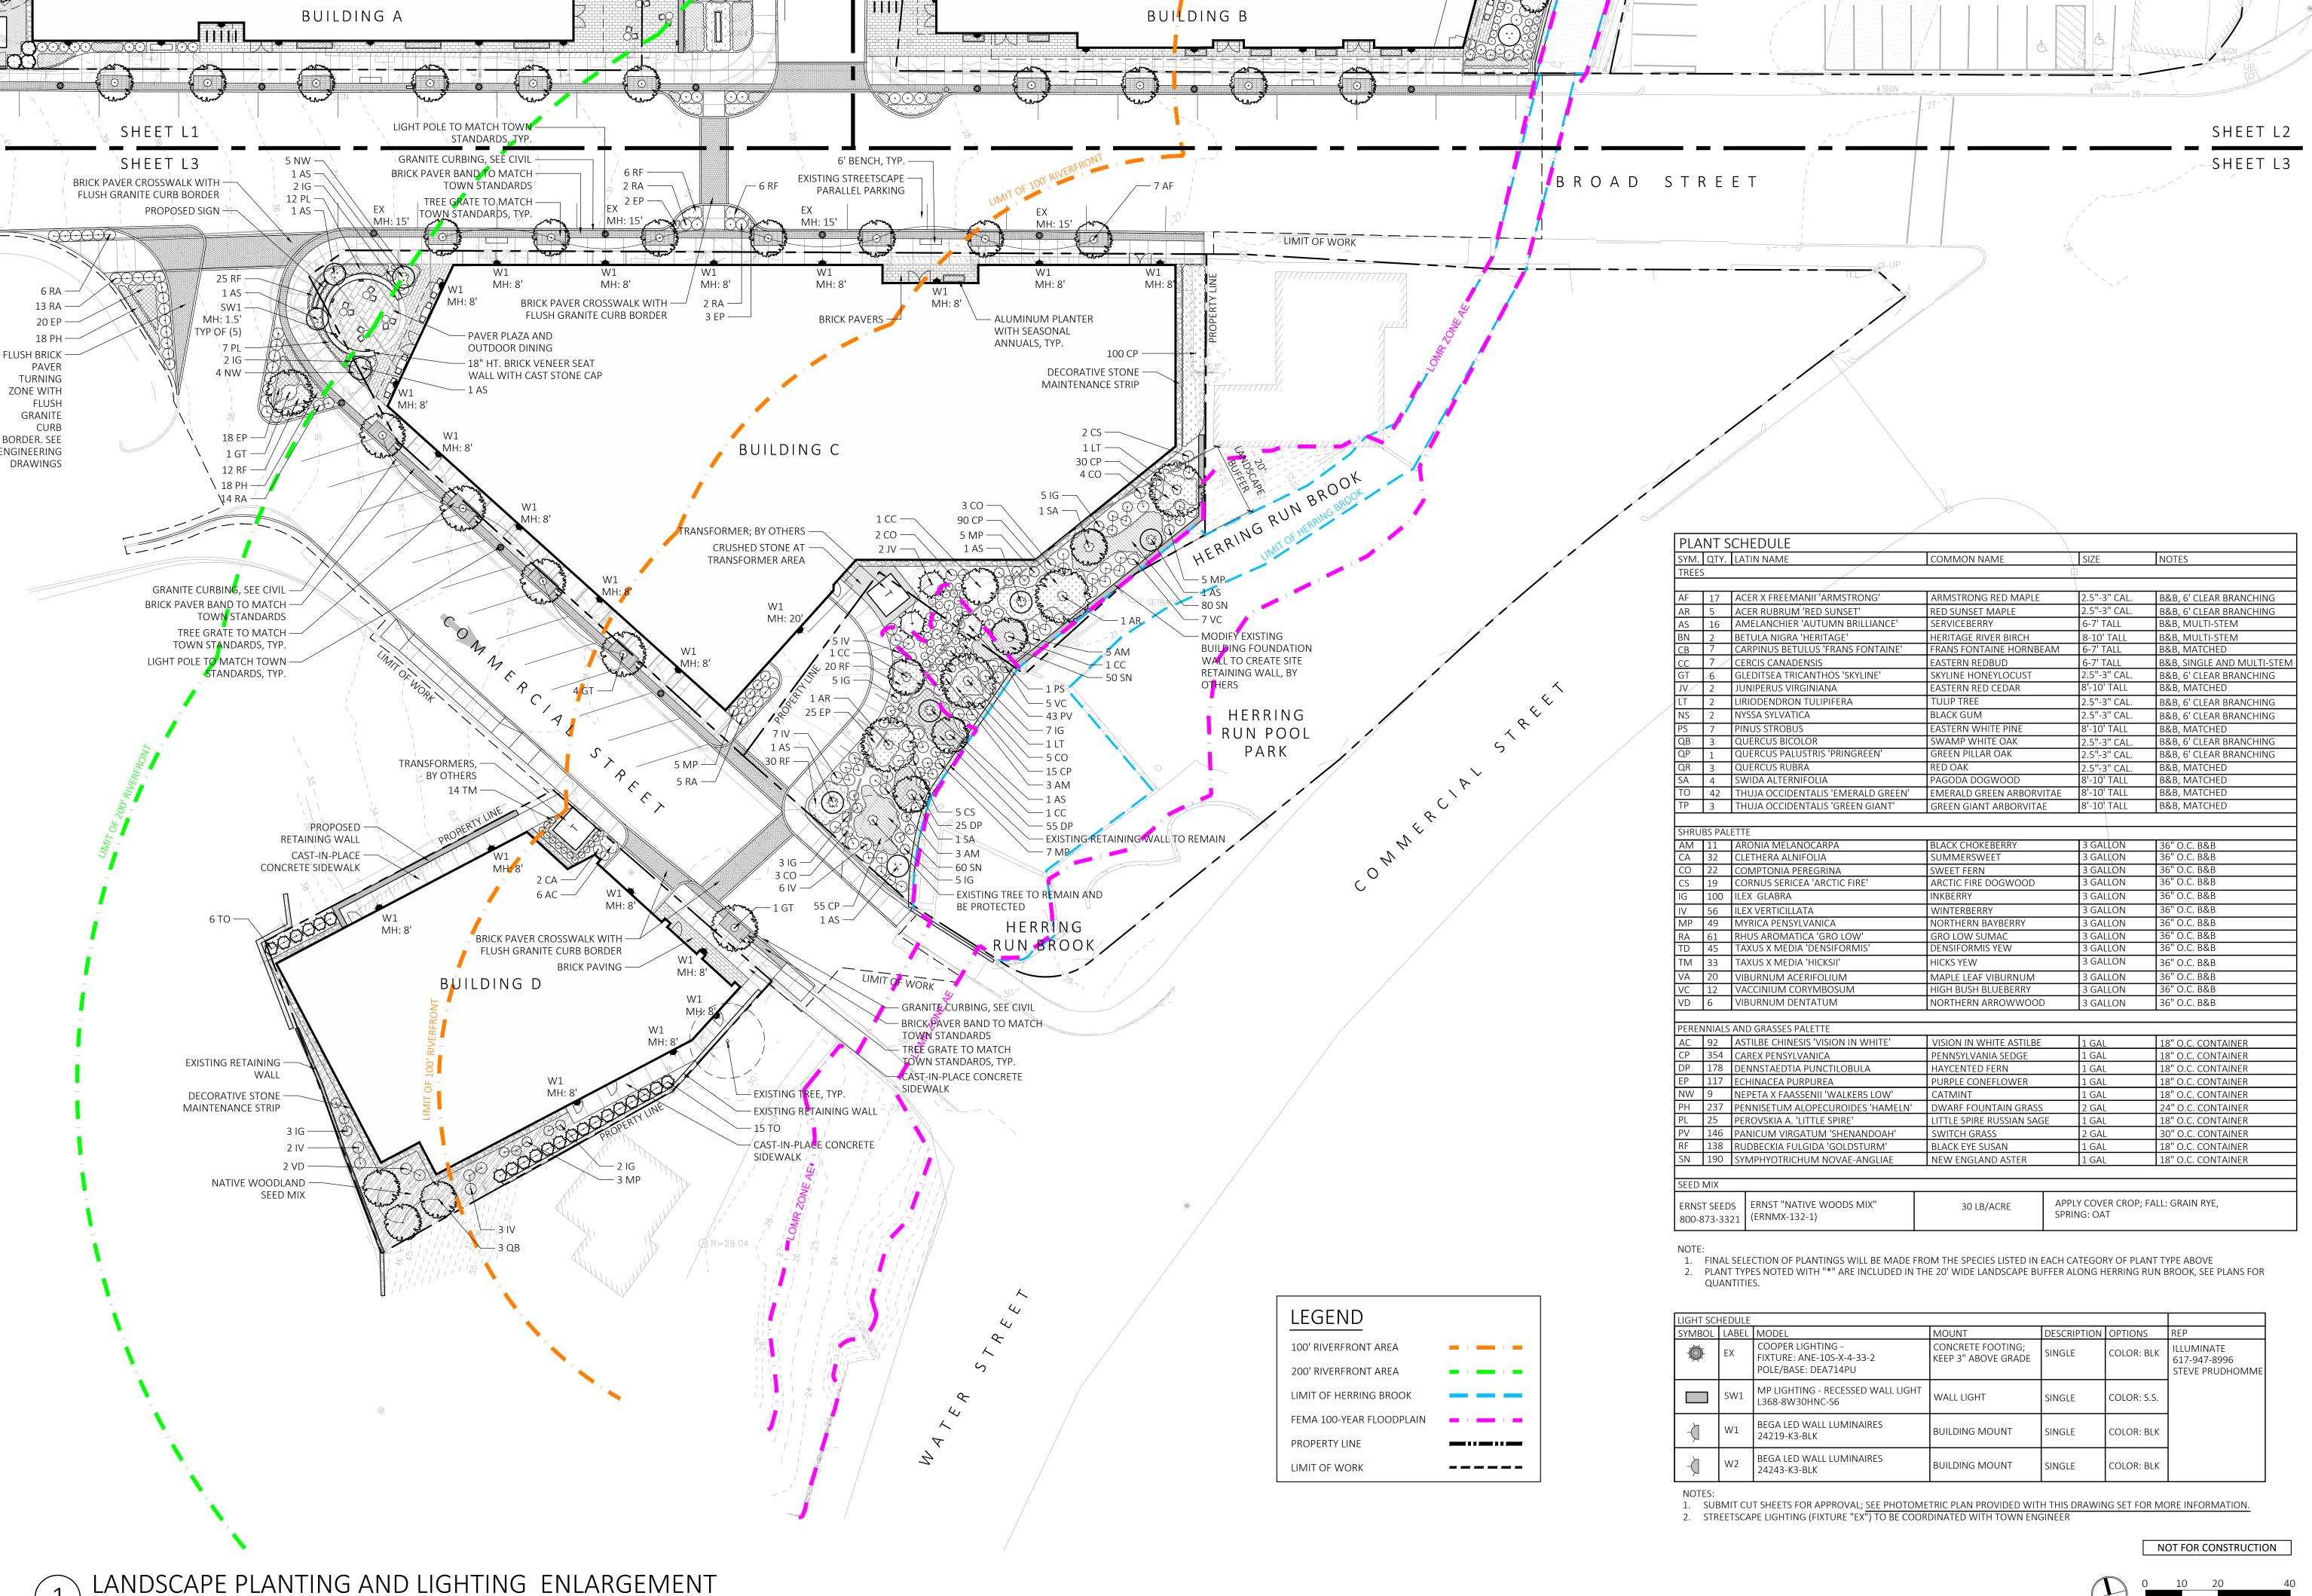
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ARCHITECT **EMBARC**

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LANDSCAPE MDLA

840 SUMMER STREET

SUITE #201A BOSTON, MA 02127

WEYMOUTH,


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TREE GRATE - SECTION

- NEVER CUT TREE LEADER - MAINTAIN RELATIONSHIP OF ROOTFLARE TO FINISH GRADE AS EXISTED PRIOR TO INSTALL, TYP. - HOLD MULCH BACK FROM TRUNK OF TREE - BARK MULCH; SEE SPEC - TEMOPARY EARTH SAUCER – PLANTING MEDIUM; SEE SPEC BELOW-GRADE TREE ANCHORING SYSTEM; SEE SPEC. - COMPACTED OR UNDISTURBED SUBGRADE - SCARIFY SURFACE OF SUBGRADE, TYP. REMOVE ROPE / CAGE AND ROLL BACK BURLAP 1/3 ROOTBALL HT, MIN; TYP.

NEVER CUT TREE LEADER MAINTAIN RELATIONSHIP OF ROOTFLARE TO FINISH GRADE AS EXISTED PRIOR TO INSTALL, TYP. HOLD MULCH BACK FROM TRUNK OF TREE - BARK MULCH; SEE SPEC TEMOPARY EARTH SAUCER - PLANTING MEDIUM; SEE SPEC BELOW-GRADE TREE ANCHORING SYSTEM;

- COMPACTED OR UNDISTURBED SUBGRADE


- REMOVE ROPE / CAGE AND ROLL BACK BURLAP 1/3

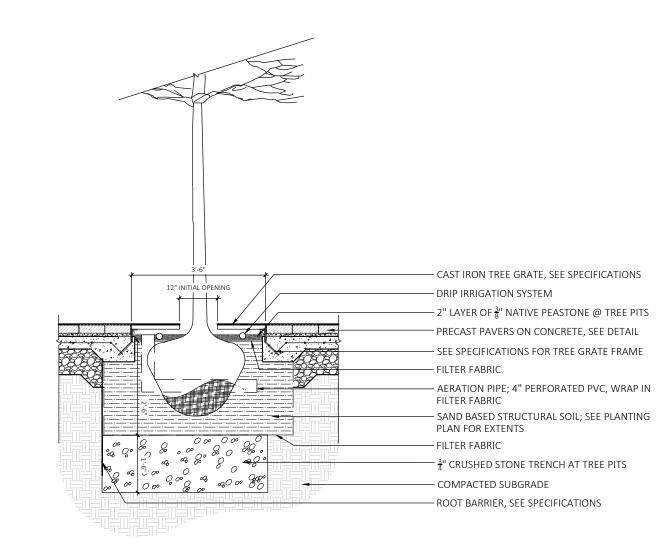- SCARIFY SURFACE OF SUBGRADE, TYP.

ROOTBALL HT, MIN; TYP.

EVERGREEN TREE PLANTING

DECIDUOUS TREE PLANTING

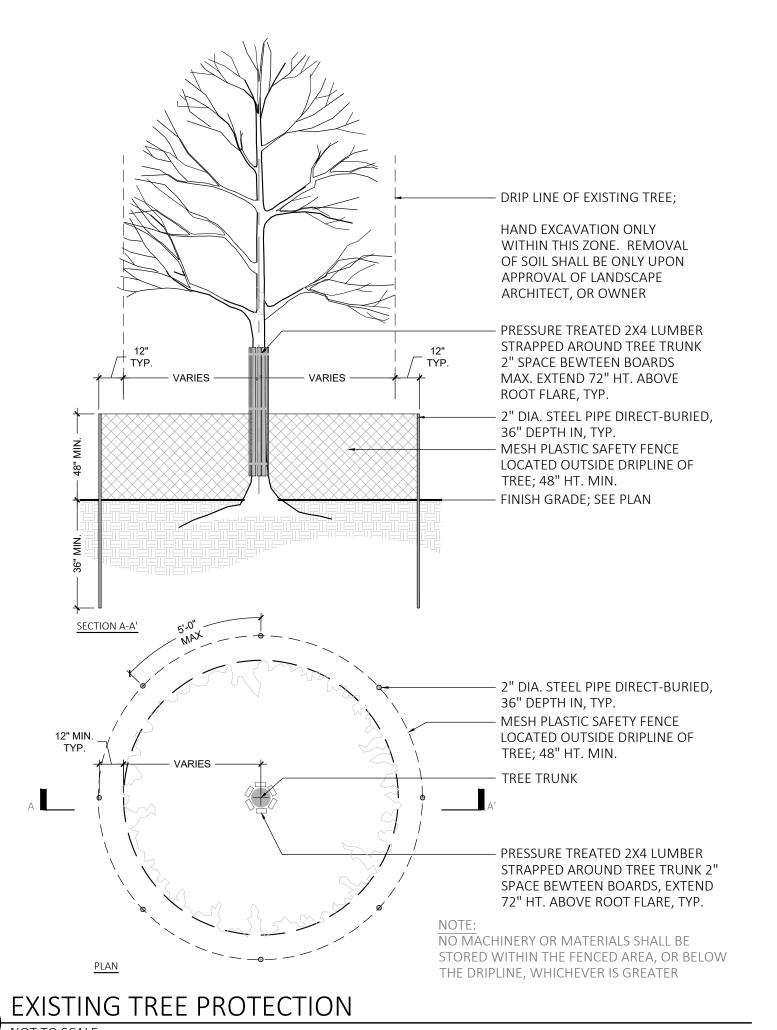

PLANTING NOTES:

1. DURING CONSTRUCTION, PROTECT ALL EXISTING SITE FEATURES, STRUCTURES AND UTILITIES.

2. PLANTS SHALL BE TRUE TO SPECIES AND VARIETY SPECIFIED AND NURSERY GROWN IN ACCORDANCE WITH THE AMERICAN STANDARD FOR NURSERY STOCK UNDER CLIMATIC CONDITIONS SIMILAR TO THOSE IN THE LOCALITY OF THE PROJECT. SUBSTITUTIONS WILL BE

PERMITTED ONLY IF APPROVED BY THE LANDSCAPE ARCHITECT. 3. LANDSCAPE ARCHITECT APPROVAL IS REQUIRED BEFORE PLANT MATERIAL IS PURCHASED. LANDSCAPE ARCHITECT RESERVES THE RIGHT TO SEE ALL MATERIAL IN PERSON AT THE NURSERY. IF TRAVEL OUTSIDE OF MA IS REQUIRED, LANDSCAPE ARCHITECT'S TRAVEL COSTS SHALL BE PAID FOR BY THE CONTRACTOR.

4. ALL EXPOSED BURLAP, WIRE BASKETS AND OTHER MATERIALS ATTACHED TO PLANTS SHALL BE REMOVED PRIOR TO PLANTING. CARE SHALL BE TAKEN NOT TO DISTURB THE ROOT BALL OF PLANTS.

5. THOROUGHLY WATER ALL PLANTS IMMEDIATELY AFTER PLANTING.

6. WHERE DISCREPANCIES IN QUANTITIES OCCUR, DRAWINGS SUPERCEDE PLANT NOTES AND SCHEDULE. 7. TRANSPLANTING SHALL BE DONE IN ACCORDANCE WITH THE AMERICAN STANDARD FOR NURSERY STOCK.

8. LOAM USED IN PLANT BEDS SHALL BE UNIFORM IN COMPOSITION, FREE FROM SUBSOIL, STONES LARGER THAN 1", NOXIOUS SEEDS AND SUITABLE FOR THE SUPPORT OF VEGETATIVE GROWTH. THE pH VALUE SHALL BE BETWEEN 5.5 AND 6.5.

9. MULCH IN TREE AND SHRUB BEDS SHALL BE NATURAL, NATIVE HEMLOCK MULCH FREE OF GROWTH OR GERMINATION INHIBITING

INGREDIENTS. SUBMIT SAMPLES FOR APPROVAL. 10.LOCATIONS FOR PLANTS AND/OR OUTLINE OF AREAS TO BE PLANTED ARE TO BE STAKED OUT AT THE SITE FOR APPROVAL BY THE

11. SOIL DEPTHS: a.) SHRUBS AND PERENNIAL BEDS: 18" MIN.; b.) GROUNDCOVER: 6" MIN.; c.) TREES: SEE DETAIL; d.) SOD/SEED: 6"MIN. 12. PROVIDE A SUBSURFACE ROOTBALL ANCHOR BY PLATIPUS EARTH ANCHORS, SIZE FOR CALIPER

IRRIGATION NOTES:

1. IRRIGATION SHALL BE A DESIGN-BUILD INSTALLATION. CONTRACTOR SHALL SUBMIT SHOP DRAWINGS FOR FINAL LAYOUT OF IRRIGATION SHOWING LOCATIONS AND SIZES OF MAIN LINES AND LATERAL LINES, ZONES, RAIN AND SOIL SENSORS, AND CUT SHEETS FOR CONTROLLER SYSTEM AND COMPONENTS. INCLUDE ANY NECESSARY SLEEVING.

2. IRRIGATION CONTRACTOR SHALL VERIFY PSI/GPM REQUIREMENTS AT THE SITE BEFORE STARTING CONSTRUCTION.

3. TREES SHALL BE ON A SEPARATE ZONE.

4. PROVIDE A REMOTE RAIN SENSOR ON A ROOF AREA THAT IS NOT OBSTRUCTED FROM THE OPEN SKY.

5. COORDINATE WITH OWNER FOR POINT OF CONNECTION LOCATION.

6. COORDINATE WITH OWNER FOR IRRIGATION CONTROLLER LOCATION.

7. INSTALL DRIP TUBING, .6GPH, 12" CENTERS, STAKED EVERY TURN OR EVERY 4' 8. COORDINATE WITH OWNER FOR BACKFLOW PREVENTION LOCATION.

9. INSTALLER SHALL INSTALL LIGHTNING AND SURGE PROTECTION DEVICES THROUGHOUT SYSTEM AS PER MANUFACTURER'S HIGHEST SPECIFICATION LEVELS.

10.INSTALLER SHALL ADHERE TO ALL MANUFACTURER'S SPECIFICATIONS RELATED TO CONTROL SYSTEM INSTALLATION.

11.INSTALLER SHALL INSTALL MOISTURE SENSORS. CONTRACTOR SHALL INSTALL PER MANUFACTURERS'S SPECIFICATIONS AND SHALL BE RESPONSIBLE TO PROGRAM RELATED HYDROZONES TO RESPECTIVE SOIL MOISTURE SENSORS. PROVIDE ONE FOR EACH IRRIGATION ZONE WITH AUTOMATIC SHUT-OFF ONCE MOISTURE REQUIREMENTS ARE MET.

12.PRIOR TO BID, CONTRACTOR TO VERIFY THAT ALL MATERIALS, INSTALLATION PARAMETERS, AND OPERATIONS CONFORM TO ALL APPLICABLE CODES AND ORDINANCES. NO LATER THAN FIVE DAYS BEFORE BID SUBMITTALS CONTRACTOR SHALL NOTIFY DESIGNER AND OWNER OF ANY CHANGES REQUIRED DUE TO CURRENT CODE OR ORDINANCE DISCREPANCIES.

ARCHITECT

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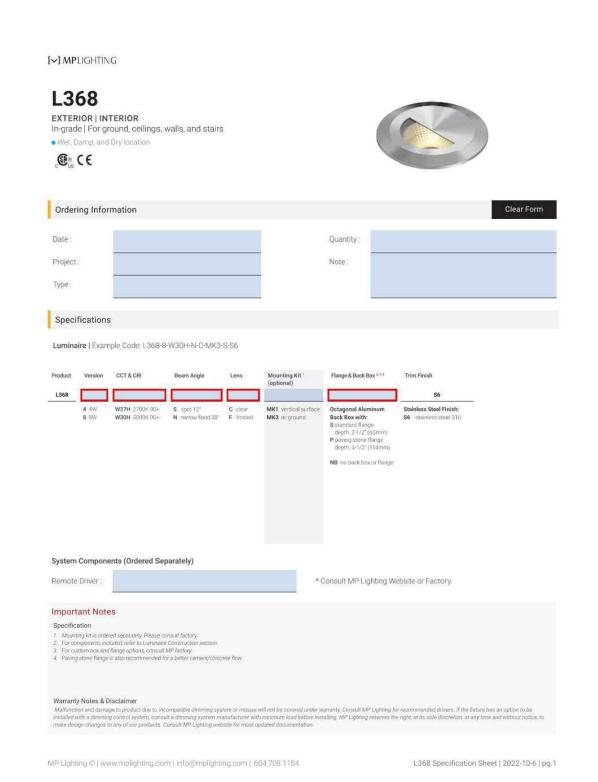


DRAWING INFORMATION

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LANDSCAPE DETAILS

DRAWING NUMBER













Ernst Conservation Seeds 8884 Mercer Pike

Meadville, PA 16335 (800) 873-3321 Fax (814) 336-5191 www.ernstseed.com

Date: August 08, 2022

Right-of-Way Native Woods Mix w/Annual Ryegrass - ERNMX-132-1

	Botanical Name	Common Name	Price/Lb
29.00 %	Panicum clandestinum, Tioga	Deertongue, Tioga	22.14
20.00 %	Lolium multiflorum	Annual Ryegrass	1.20
15.00 %	Elymus virginicus, Madison-NY Ecotype	Virginia Wildrye, Madison-NY Ecotype	10.16
15.00 %	Panicum virgatum, 'Shelter'	Switchgrass, 'Shelter'	12.22
10.00 %	Festuca rubra	Creeping Red Fescue	8.40
5.00 %	Agrostis perennans, Albany Pine Bush-NY Ecotype	Autumn Bentgrass, Albany Pine Bush-NY Ecotype	16.80
3.00 %	Carex vulpinoidea, PA Ecotype	Fox Sedge, PA Ecotype	28.80
3.00 %	Chamaecrista fasciculata, PA Ecotype	Partridge Pea, PA Ecotype	7.20
100.00 %		Mix Price/Lb Bulk:	\$12.78

Seeding Rate: 30 lb per acre

guiding philosophy and function of the mix will not.

Woodland Openings

The shade-tolerant grasses and legumes are ideal for over seeding log landings and bioengineering sites. Mix formulations are subject to change without notice depending on the availability of existing and new products. While the formula may change, the

for current pricing when placing orders.

Price quotes guaranteed for 30 days. All prices are FOB Meadville, PA. Please check our web site at www.ernstseed.com

ARCHITECT

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1 FRANKLIN STREET, UNIT 2308

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DRAWING INFORMATION

PROJECT #: 22034 SCALE:

DRAWING TITLE LANDSCAPE

DETAILS

DRAWING NUMBER