GENERAL NOTES:

ALL WORK SHALL BE PERFORMED IN CONFORMANCE TO THE LATEST EDITION OF THE MASSACHUSETTS STATE BUILDING CODE AND ALL OTHER APPLICABLE CODES AND LAWS.

CONTRACTOR RESPONSIBILITY-CONTRACTOR IS SOLELY RESPONSIBLE FOR:

- . VIEWING SITE AND INCLUDING ANY SPECIAL CONDITIONS NECESSARY TO PERFORM THE WORK AS DESCRIBED IN THE DRAWINGS.
- 2. ESTABLISHING CONTROL OF THE SITE VIA SURVEY, AND LAYOUT.
- 3. OBTAINING AND PAYING FOR ALL PERMITS.
- 4. PAYING FOR ALL TEMPORARY UTILITIES AND FACILITIES. 5. CHECKING AND CONFIRMING ALL DIMENSIONS, AND LAYOUTS.
- 6. SCHEDULING AND SEQUENCING.
- 7. CONSTRUCTION MEANS, METHODS AND TECHNIQUES
- 8. MAINTAINING DRAWINGS AND PERMITS ON SITE.
- 9. JOB SITE SAFETY
- 10. COORDINATION BETWEEN TRADES, AND SUPPLIERS.
- 11. PROVIDE SCHEDULE TO OWNER AND ENGINEER.
- 12. PROVIDE A SCHEDULE OF VALUES TO THE OWNER AND ENGINEER. 13. TEMPORARY HEAT, ICE AND SNOWPLOWING IS THE RESPONSIBILITY OF THE CONTRACTOR.
- 14. SITE CLEANLINESS AND CONFORMANCE TO NFPA 241 REQUIREMENTS.
- 15. REPAIRING ANY WORK DAMAGED BY HIS FORCES WHILE PERFORMING THIS CONTRACT.
- 16. GIVING WARRANTY FOR HIS WORK FOR A PERIOD OF ONE YEAR FROM THE DATE OF FINAL COMPLETION.

REVIEW OF WORK BY DESIGNERS-

CONTRACTOR SHALL NOTIFY ARCHITECT BEFORE PROJECT STARTS.

CONTRACTOR SHALL NOTIFY ARCHITECT, ONE WEEK PRIOR TO:

17. POURING CONCRETE

18. INSULATING

19. INSTALLING DRYWALL 20. FINAL INSPECTION

SHOP DRAWINGS-

ALL SHOP DRAWINGS SHALL BE SUBMITTED 30 DAYS AFTER CONTRACT AWARD.

GENERAL CONTRACTOR SHALL APPROVE SHOP DRAWINGS, PRIOR TO SUBMITTING TO ARCHITECT OR ENGINEER.

NON SUBMISSION DOES NOT CONSTITUTE APPROVAL OF ANY WORK.

NO EXCEPTIONS TAKEN DOES NOT RELIEVE THE CONTRACTOR OF PERFORMING ANY OTHER WORK ON THE DRAWINGS.

CONTRACTOR SHALL EXPECT A MINIMUM OF 2 WEEKS FOR DESIGNERS' REVIEW TIME.

ANY VARIANCE FROM THE ORIGINAL DESIGN SHALL BE NOTED.

ANY SUBSTITUTION NOT INDICATED SHALL NOT CONSTITUTE APPROVAL OF A CHANGE.

SHOP DRAWINGS ARE NOT COORDINATION DRAWINGS.

DESIGNERS ARE NOT RESPONSIBLE FOR DIMENSIONS.

CHANGE ORDERS-

CONTRACTOR SHALL VISIT THE SITE AND BE THOROUGHLY ACOUAINTED WITH THE PROJECT PRIOR TO SUBMITTING A PRICE. ADDITIONAL MONEY WILL NOT BE GRANTED FOR WORK NOT CLARIFIED PRIOR TO BIDDING.

DESIGNER SHALL BE NOTIFIED OF ANY CHANGE TO THE DRAWINGS, UNFORESEEN FIELD CONDITIONS OR DISCREPANCIES PRIOR TO PERFORMING WORK.

ANY PROPOSED CHANGES SHALL BE ACCOMPANIED WITH A WRITTEN DESCRIPTION OR A SKETCH FOR CLARIFICATION.

ALL CHANGE ORDERS SHALL BE APPROVED PRIOR TO PERFORMING WORK.

CHANGE ORDERS SHALL BE PRICED EITHER LUMP SUM OR UNIT PRICE OR TIME AND MATERIALS.

ANY SUBSTITUTION REQUEST SHALL BE MADE VIA CHANGE ORDER, AND NOT VIA SHOP DRAWINGS UNLESS AGREED TO.

ANY CHANGE SHALL STATE THE CREDIT OR COST ADD AND/OR ANY CHANGE TO THE SCHEDULE. **REQUISITIONS-**

ANY REQUISITION REQUIRED TO BE SIGNED BY THE ARCHITECTED SHALL BE SUBMITTED A MINIMUM OF ONE WEEK PRIOR TO BEING SUBMITTED TO THE BANK FOR REVIEW.

CONTRACTOR SHALL PROVIDE RECEIPTS AND INSURANCE CERTIFICATES FOR ANY MATERIALS FOR PAYMENT FOR ANY UNINSTALLED MATERIALS.

NOTE: THERE HAS BEEN NO SOIL TESTING PROVIDED TO THIS OFFICE FOR THIS PROJECT. THE DESIGNING ARCHITECT OR STRUCTURAL ENGINEER ACCEPTS NO **RESPONSIBILITY FOR EXISTING SOIL CONDITIONS. ANY SOIL BEARING CAPACITY** OF THIS FOUNDATION SYSTEM IS DESIGNED BASED ON A 2 TON MINIMUM SOIL BEARING CAPACITY. IT SHALL BE THE CONTRACTORS OR OWNERS' RESPONSIBILITY TO DETERMINE SUITABLE SOIL CONDITIONS AND VERIFY THE BEARING PRESSURE. IF A SUITABLE SOIL THAT CAN WITHSTAND A 2 TON BEARING CAPACITY IS NOT AVAILABLE, THIS OFFICE SHOULD BE CONTACTED BY THE CONTRACTOR OR OWNER FOR A FOUNDATION REDESIGN.

FOUNDATION NOTES:

THE FOUNDATION HAS BEEN DESIGNED FOR 4000 PSF FOR ALLOWABLE SOIL BEARING CAPACITY. ALL BACKFILL UNDER STRUCTURAL SLABS, MATS, AND FOOTINGS WILL BE ENGINEERED BACKFILL COMPACTED IN SPECIFIC LIFTS TO 95 PERCENT OF MAXIMUM DRY DENSITY, UNLESS OTHERWISE INDICATED OR SPECIFIED. 3. ALL EMBANKMENTS AND BACKFILL COMPACTED IN SPECIFIED LIFTS TO 90 PERCENT OF MAXIMUM DRY DENSITY, UNLESS OTHERWISE INDICATED OR SPECIFIED.

PROVIDE SHEETING, BRACING, AND UNDERPINNING AS REQUIRED TO PRESERVE ADJACENT STRUCTURES. FOUNDATIONS SHALL NOT BE POURED IN WATER OR ON FROZEN GROUND.

PENETRATIONS WITH RESPECTIVE TRADES BEFORE PLACING CONCRETE DOWELS FROM FOUNDATIONS INTO PIERS, COLUMNS, BUTTRESSES OR WALLS SHALL BE THE SAME SIZE AND NUMBER AS REINFORCEMENT IN PIERS, COLUMNS, BUTTRESSES OR WALLS ABOVE, EXCEPT AS OTHERWISE

SHOWN. CONTRACTOR SHALL PROVIDE CONTINUOUS DRAINAGE BY MECHANICAL METHODS TO CONTROL SURFACE AND UNDERGROUND WATER, AS REQUIRED DURING CONSTRUCTION. CONTRACTOR SHALL ENSURE THAT GROUND WATER LEVELS UNDER ADJACENT STRUCTURES AND

PLANS.

PLUMBING DRAWINGS AND THE REQUIREMENTS OF THE GEOTECHNICAL ENGINEER. 12. ALL BEARING MATERIALS SHALL BE INSPECTED BY THE INDEPENDENT TESTING AGENCY PRIOR TO CONCRETE PLACEMENT. THE INDEPENDENT TESTING AGENCY SHALL DETERMINE THE SUITABILITY OF THE BEARING MATERIAL. FOOTING ELEVATIONS SHALL BE ADJUSTED AS REQUIRED.

13. BOTTOM OF ALL EXTERIOR FOOTINGS SHALL BEAR A MINIMUM OF 4'-0" BELOW FINAL FINISHED GRADE FOR FROST PROTECTION.

14. FOUNDATION WALLS THAT RETAIN EARTH SHALL BE BRACED AGAINST BACKFILLING PRESSURES UNTIL FLOOR SLABS AT TOP AND BOTTOM ARE IN PLACE. 15. WHERE FOUNDATION WALLS ARE TO HAVE EARTH PLACED ON EACH SIDE, PLACE FILL SIMULTANEOUSLY

17. SEE THE REQUIREMENTS OF THE SPECIFICATIONS FOR BACKFILLING UNDER OR ADJACENT TO ANY PORTION OF THE BUILDING. 18. PROTECT IN-PLACE FOUNDATIONS, SLABS AND ADJACENT STRUCTURES, NEW CONSTRUCTION, STREET

COMPLETED.

20. WHERE BEDROCK IS ENCOUNTED AT OR WITHIN 12" OF DESIGN FOOTING GRADE, IT SHOULD BE OVER EXCAVATED A MIN. OF 12" BELOW THE BOTTOM OF PROPOSED FOOTING. BEDROCK EXCAVATIONS SHOULD EXTEND A MIN. OF 12" BEYOND FOOTING EDGE. LOOSE ROCK PIECES SHOULD BE REMOVED WITHIN THE FOOTING BEARING ZONE, AND OPEN BEDROCK JOINTS SHOULD BE CHOKED WITH CRUSHED STONE OR FILLED WITH CONCRETE PRIOR TO PLACING THE SOIL CUSHION.

CONCRETE NOTES:

OF:

- 3000 PSI

- 3500 PSI

AGGREGATE SIZE SHALL NOT EXCEED 3/4" IN DIAMETER. 3. ALL CONCRETE SLABS ON GRADE SHALL BE POURED IN 900 SQUARE FOOT

PANELS, MAXIMUM; OR, PROVIDE CONTROL JOINTS BY SAW CUTTING THE SLAB WHILE THE CONCRETE IS STILL GREEN.

1. ALL REINFORCEMENT, EXCEPT FOR TIES AND STIRRUPS, SHALL CONFORM TO ASTM 615-60. ALL REINFORCEMENT FOR TIES AND STIRRUPS SHALL CONFORM TO ASTM 615-40. ALL WELDED WIRE FABRIC SHALL CONFORM TO ASTM A185-70 SPECIFICATIONS. 4. ALL REINFORCEMENT SHALL BE INSPECTED AND APPROVED BY THE ARCHITECT OR HIS ENGINEER PRIOR TO THE PLACEMENT OF ANY CONCRETE.

- SHALL BE AS FOLLOWS: A. FOOTINGS

- ON GRADE FROM TOP SURFACE

73 REGATTA ROAD, WEYMOUTH, MA, 02191

VERIFY LOCATIONS AND REQUIREMENTS FOR INSERTS, SLEEVES, CONDUITS, EMBEDMENT AND

PROPERTIES ARE NOT ALTERED.

10. ALL FOUNDATION UNITS (PIERS) SHALL BE CENTERED SUPPORT MEMBERS, UNLESS OTHERWISE NOTED ON

11. COORDINATE UNDER FLOOR AND PERIMETER DRAIN REQUIREMENTS WITH ARCHITECTURAL, CIVIL AND

SO AS TO MAINTAIN A COMMON ELEVATION ON EACH SIDE OF THE WALL.

16. ALL FOOTING EXCAVATIONS ARE TO BE FINISHED BY HAND.

UTILITIES FROM FROST PENETRATION OR DAMAGE FROM CONSTRUCTION ACTIVITIES UNTIL THE PROJECT IS

19. SLAB ON GRADE SHALL BEAR DIRECTLY ON A MIN. 12" THICK LAYER OF COMPACTED STRUCTURAL FILL, OR MIN. 6" THICK LAYER OF CRUSHED STONE, PLACED ABOVE PROOFROLLED AND COMPACTED EXISTING FILL, OR ABOVE UNDISTURBED NATURAL TILL. SHOULD BEDROCK BE ENCOUNTED AT OR WITHIN 12" OF BOTTOM OF SLAB, BEDROCK SHALL BE OVER EXCAVATED A MIN. OF 12" BELOW BOTTOM OF SLAB.

1. ALL CONCRETE SHALL ATTAIN A MINIMUM COMPRESSIVE STRENGTH

FOR BASEMENT SLABS, FOUNDATION WALL, EXTERIOR WALLS AND

- OTHER VERTICAL CONCRETE SURFACES EXPOSED TO THE WEATHER FOR DRIVEWAYS, CURBS, WALKS, PATIOS, PORCHES, CARPORT SLAB,
- STEPS AND OTHER FLATWORK EXPOSED TO WEATHER AND GARAGE FLOOR SLABS

2. MAXIMUM SLUMP SHALL NOT EXCEED 4"; AND MAXIMUM; COARSE

REINFORCING NOTES:

5. THE CONTRACTOR SHALL SUBMIT FOUR PRINTS OF SHOP DRAWINGS: SHOWING ALL

REINFORCING DETAILS, CHAIR BARS, HIGH CHAIRS, SLAB BOLSTERS, ETC. TO THE ARCHITECT FOR HIS APPROVAL. THE CONTRACTOR SHALL RECEIVE WRITTEN APPROVED SHOP DRAWINGS FROM THE ARCHITECT OR HIS ENGINEER PRIOR TO THE

FABRICATION OF REINFORCEMENT.

6. CLEARANCES OF MAIN REINFORCING FROM ADJACENT CONCRETE SURFACES

3 INCHES B. SIDES OF FOUNDATIONS WALLS.

EXPOSED FACES OF FOUNDATIONS.

SIDES OF COLUMNS/PIERS, SLABS

2 INCHES

C. INTERIOR FACES OF FOUNDATIONS,

TOP REINFORCING IN SLABS EXPOSED

TO THE WEATHER 1-1/2 INCHES D. TOP STEEL OF INTERIOR SLABS 1 INCHES

7. MAXIMUM DEVIATION FROM THESE REQUIREMENTS SHALL BE 1/4" OF SECTIONS 10" OR LESS, 1/2" FOR SECTIONS GREATER THAN 10".

DESIGNER:

AGILE ENGINEERING LIANG CHENG, PE

188 SOUTH STREET, QUINCY, MA, 02169 617-818-3621 ANDYCHENGPE@GMAIL.COM

REVISIONS:

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CONTRACTOR NOTE:

PRIOR TO COMMENCEMENT OF WORK OR FABRICATION OF COMPONENTS,

CONTRACTOR SHALL INVESTIGATE AND VERIFY IN THE FIELD ALL CONDITIONS, DIMENSIONS, AND ELEVATIONS OF THE EXISTING CONSTRUCTION. ALL DISCREPANCIES BETWEEN FIELD-VERIFIED CONDITIONS, DIMENSIONS AND ELEVATIONS AND THOSE INDICATED ON THE DRAWINGS SHALL BE IMMEDIATELY MADE KNOWN TO THE ENGINEER IN WRITING. THE USE OF (V.I.F.) OR (+/-) OR OTHER SIMILAR NOTES AT CERTAIN LOCATIONS ON THE DRAWINGS DOES NOT RELIEVE THE CONTRACTOR OF RESPONSIBILITY FOR VERIFYING ALL CONDITIONS DESCRIBED ABOVE.

CONTRACTOR TO PROVIDE TEMPORARY SHORING, BRACING, AND SUPPORT AS REQUIRED DURING CONSTRUCTION.


PROJECT NUMBER: DATE: 2-10-2023 AS NOTED SCALE: DRAWING NUMBER:

DRAWING TITLE:

GENERAL NOTES

PERMIT ONLY

PROVIDE NEW JOIST HANGERS AND HURRICANE TIES BY SIMPSON STRONG-TIE AT LOCATIONS WHERE MEMBERS FRAME IN TO SIDE OF EXISTING MEMBERS OR NEW

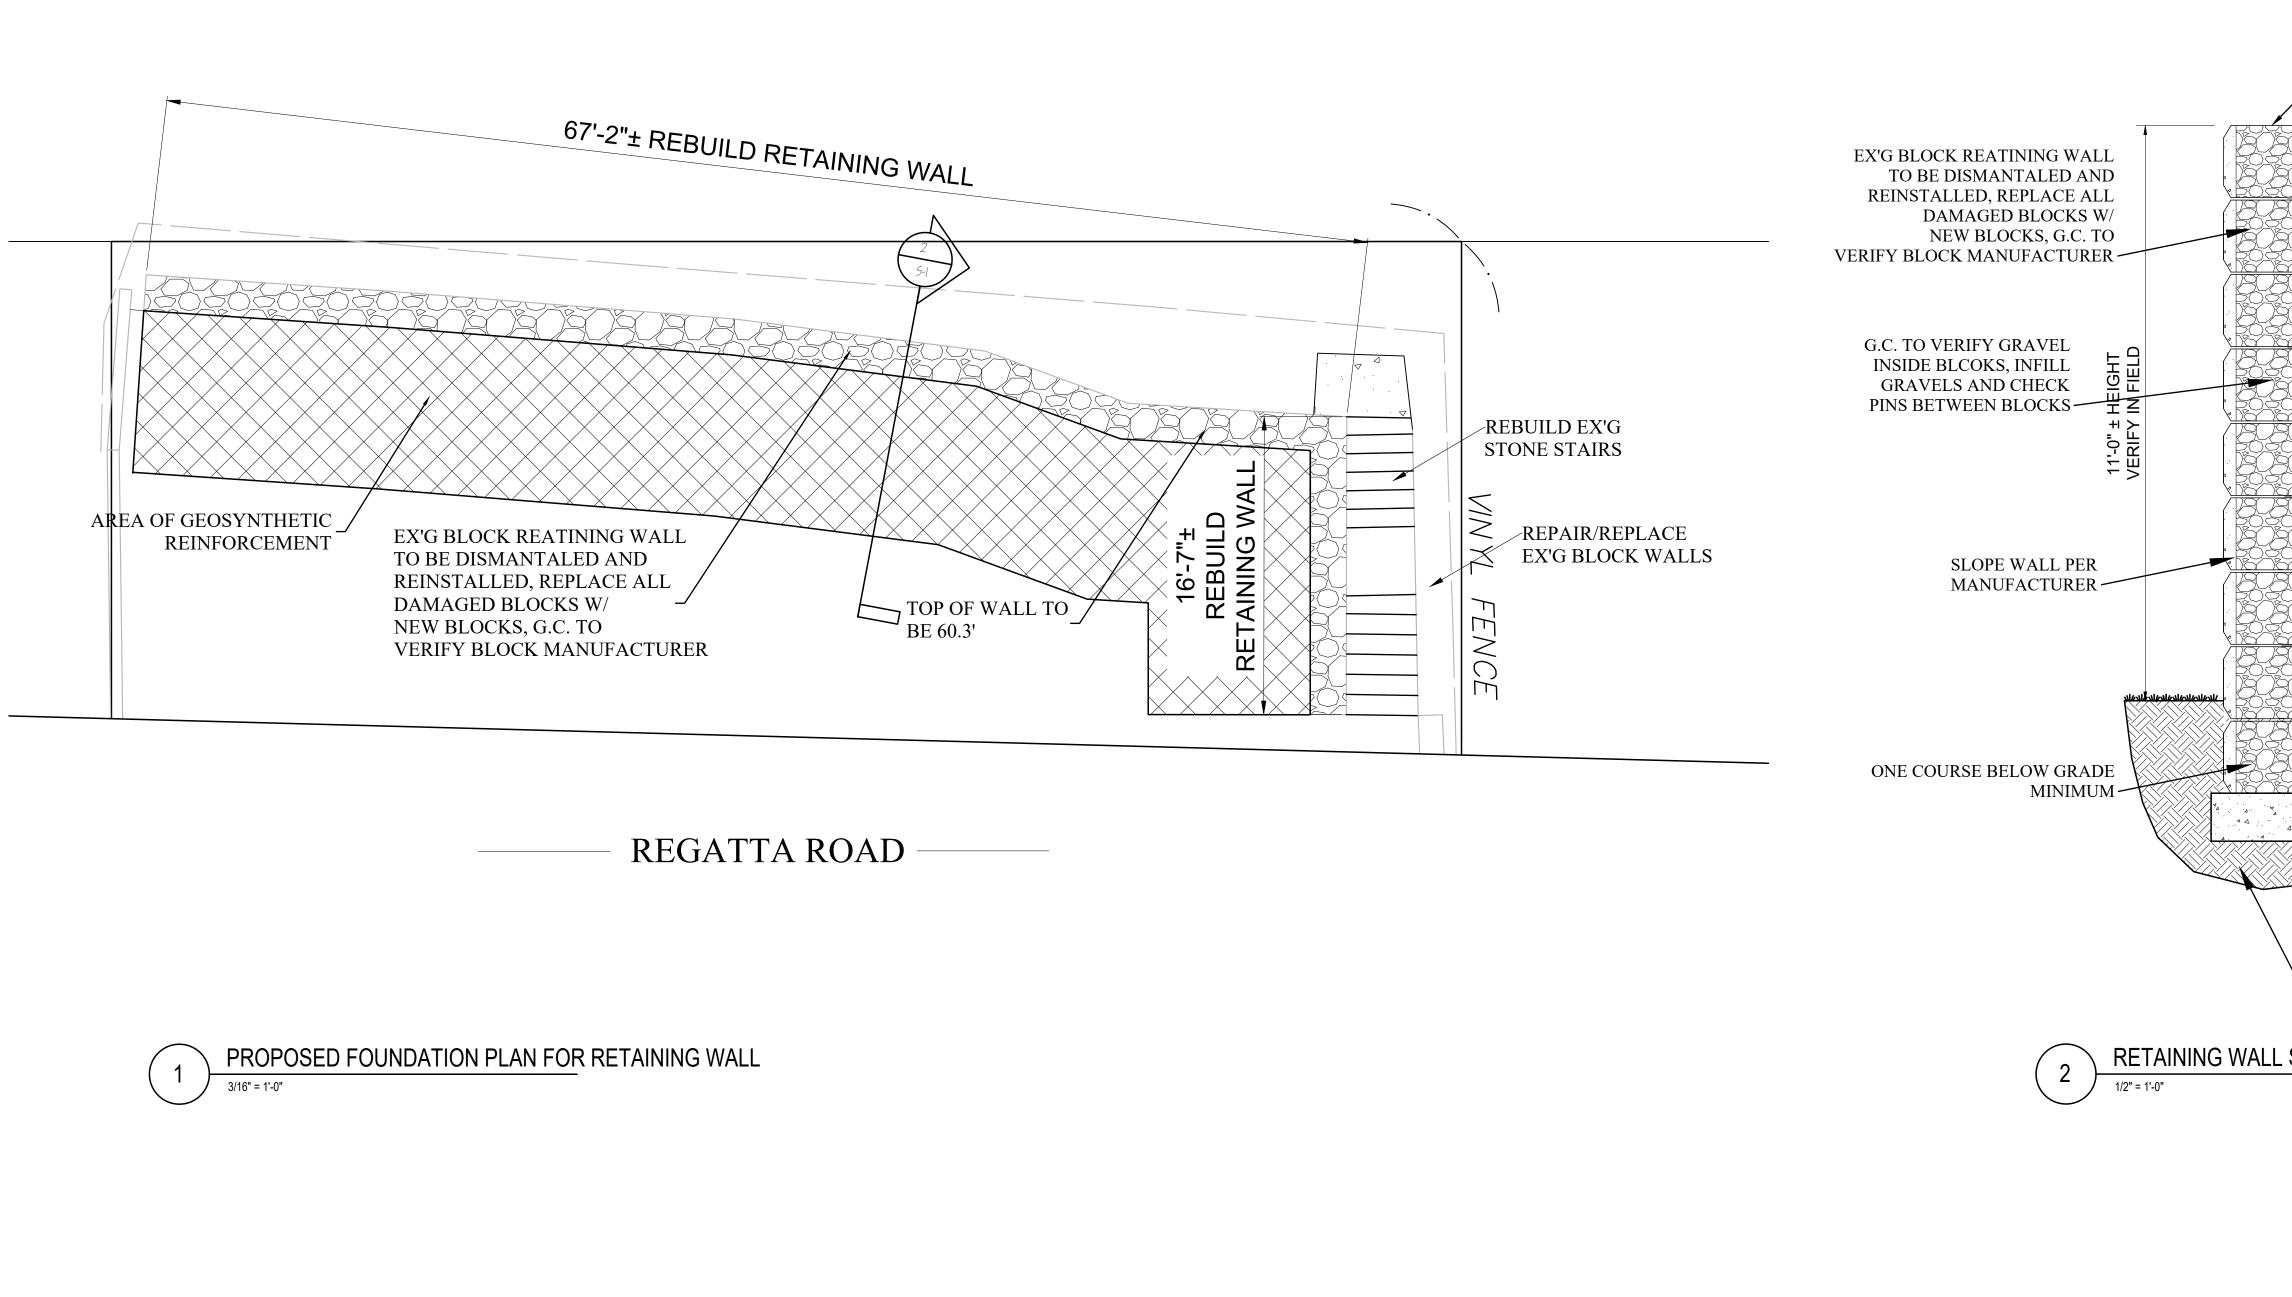

	DESIGNER: AGILE ENGINEERING. LIANG CHENG, PE 188 SOUTH STREET, QUINCY, MA, 02169 617-818-3621 ANDYCHENGPE@GMAIL.COM
- KEEP TOP OF WALL EL. TO 60.3'	REVISIONS:
GEOSYNTHETIC REINFORCEMENT TOTAL 4 LAYERS MINIMUM. 9'-0" DEEP BEHIND WALL. DRAINAGE AGGREGATE 18" THICK MIN.	NG WALL
6" DIA. (MIN.) DRAIN PIPE OUTLET @ END OF WALL OR @ 40' CENTERS MAX. SLOPE TO DRAIN TO WELL (1/8"/FT.)	EXISTING RETAINING WALL TTA ROAD JTH, MA, 02191
SECTION	PROJECT TITLE: REPAIR EX 73 REGAT WEYMOUT
	DRAWING TITLE: FLOOR PLANS
PERMIT	PROJECT NUMBER: DATE: 2-10-2023 SCALE: AS NOTED DRAWING NUMBER: SCALE