

## DEFINITIVE SUBDIVISION PLAN


# FOR WEATHERVANE MASSAPOAG, LLC.


MASSAPOAG STREET, WEYMOUTH, MA

0 MASSAPOAG (SOUTH), ASSESSOR'S REF: 44-505-1 0 MASSAPOAG (NORTH), ASSESSOR'S REF: 44-505-2 68 MASSAPOAG, ASSESSORS REF: 44-504-8

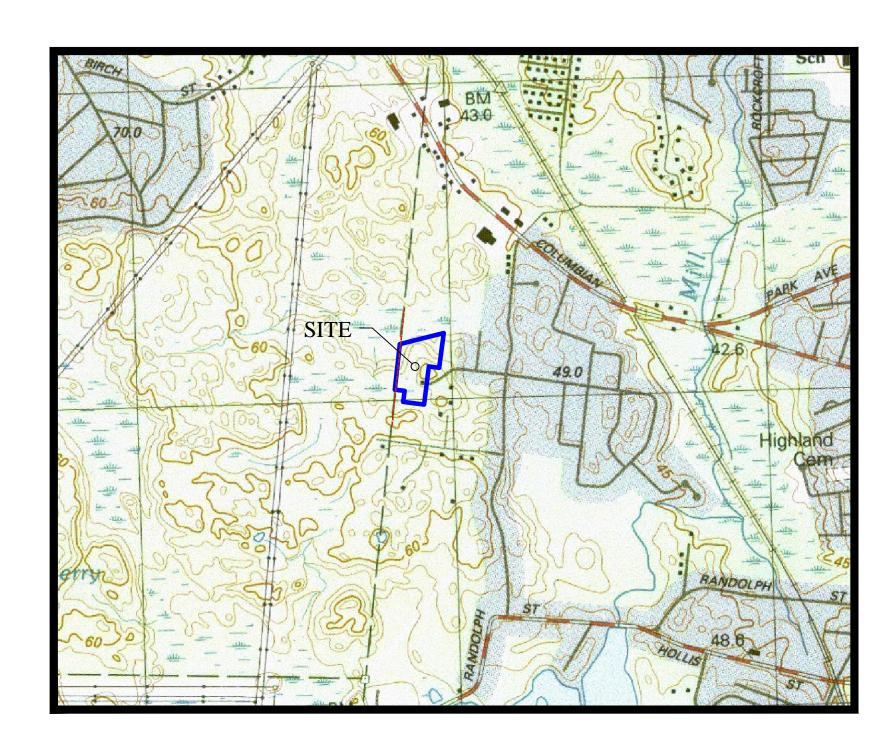

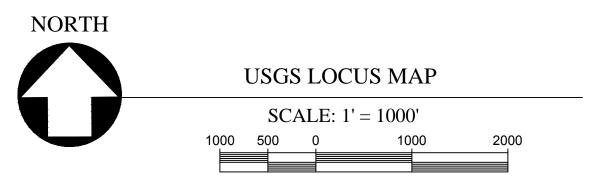

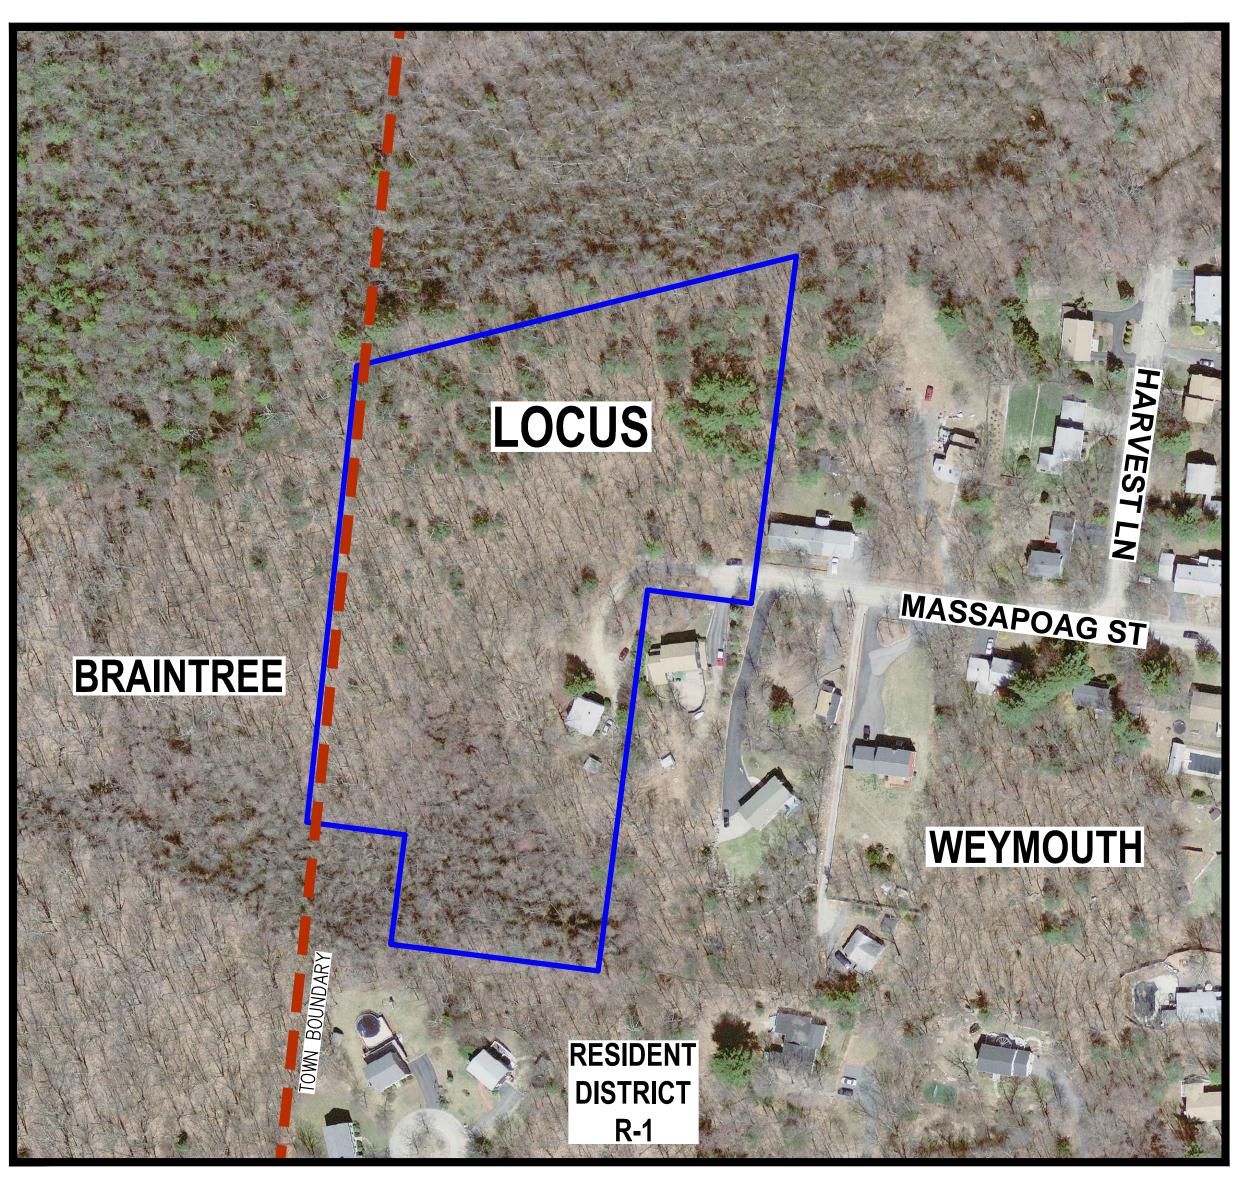

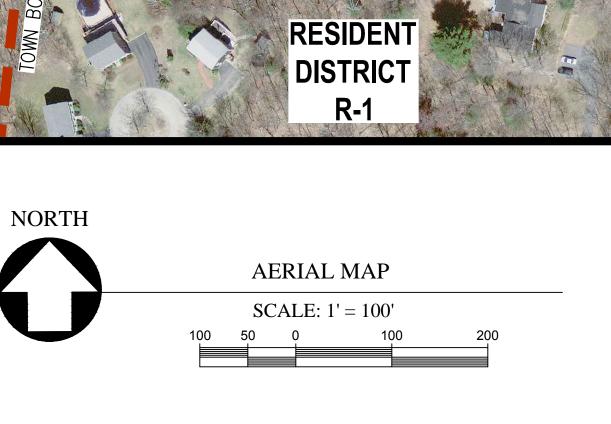

#### DRAWING INDEX:

C-1 COVER SHEET
C-2 LOTTING PLAN
C-3 SITE PLAN
C-4 GRADING AND DRAINAGE PLAN
C-5 UTILITIES PLAN
C-6 SOIL EROSION AND SEDIMENT CONTROL PLAN
C-7 ROADWAY PLAN AND PROFILE
C-8.1 DETAIL SHEET (1 OF 2)
C-8.2 DETAIL SHEET (2 OF 2)

#### SUPPLEMENTAL PLANS:

PLAN OF LAND 0 MASSAPOAG STREET (SHEET 1& 2) (PREPARED BY HOYT LAND SURVEYING)

#### OWNER/APPLICANT:

WEATHERVANE MASSAPOAG, LLC. 190 OLD DERBY STREET, SUITE 311 HINGHAM, MA 02043

#### SURVEYOR

(FOR THE EXISTING CONDITION PLAN)

HOYT LAND SURVEYING 1287 WASHINGTON STREET WEYMOUTH, MA 02189 781-682-9142

#### ENGINEER/ SURVEYOR:

CROCKER DESIGN GROUP, LLC.

2 SHARP STREET, UNIT B
HINGHAM, MA 02043
781-820-0416

APPROVAL UNDER THE SUBDIVISION CONTROL LAW WEYMOUTH PLANNING BOARD				
DATE:				
PLANNING BOARD ENDORSEMENT		F0D	DEGICTRY LICE	ONII V
DOES NOT IMPLY CONFORMANCE WITH TOWN OF WEYMOUTH ZONING BY-LAW.		FOR	REGISTRY USE	ONLY
	,			

11.19.21 REV. PER CON. COMM. AND TOWN ENG. COMMENTS 3.
4.23.20 REVISED PER TOWN STAFF COMMENTS 2.
2.05.19 REVISED WETLAND FLAGS AND LOT 1.
Date Description No Revisions



#### CROCKER DESIGN GROUP, LLC

2 SHARP STREET, UNIT HINGHAM, MA 02043 P: 781-820-0416

MASSACHUSETTS

## DEFINITIVE SUBDIVISION PLAN

MASSAPOAG STREET WEYMOUTH, MA

VVETWOO

### WEATHERVANE MASSAPOAG, LLC.

190 OLD DERBY STREET, SUITE 311 HINGHAM, MA 02043


Drawing Title

**COVER SHEET** 

Project No.	100-029	Drawing No.
ate	12.20.2018	
Scale	AS NOTED	
Orawn By	SZA	

Approved By GC

C-1

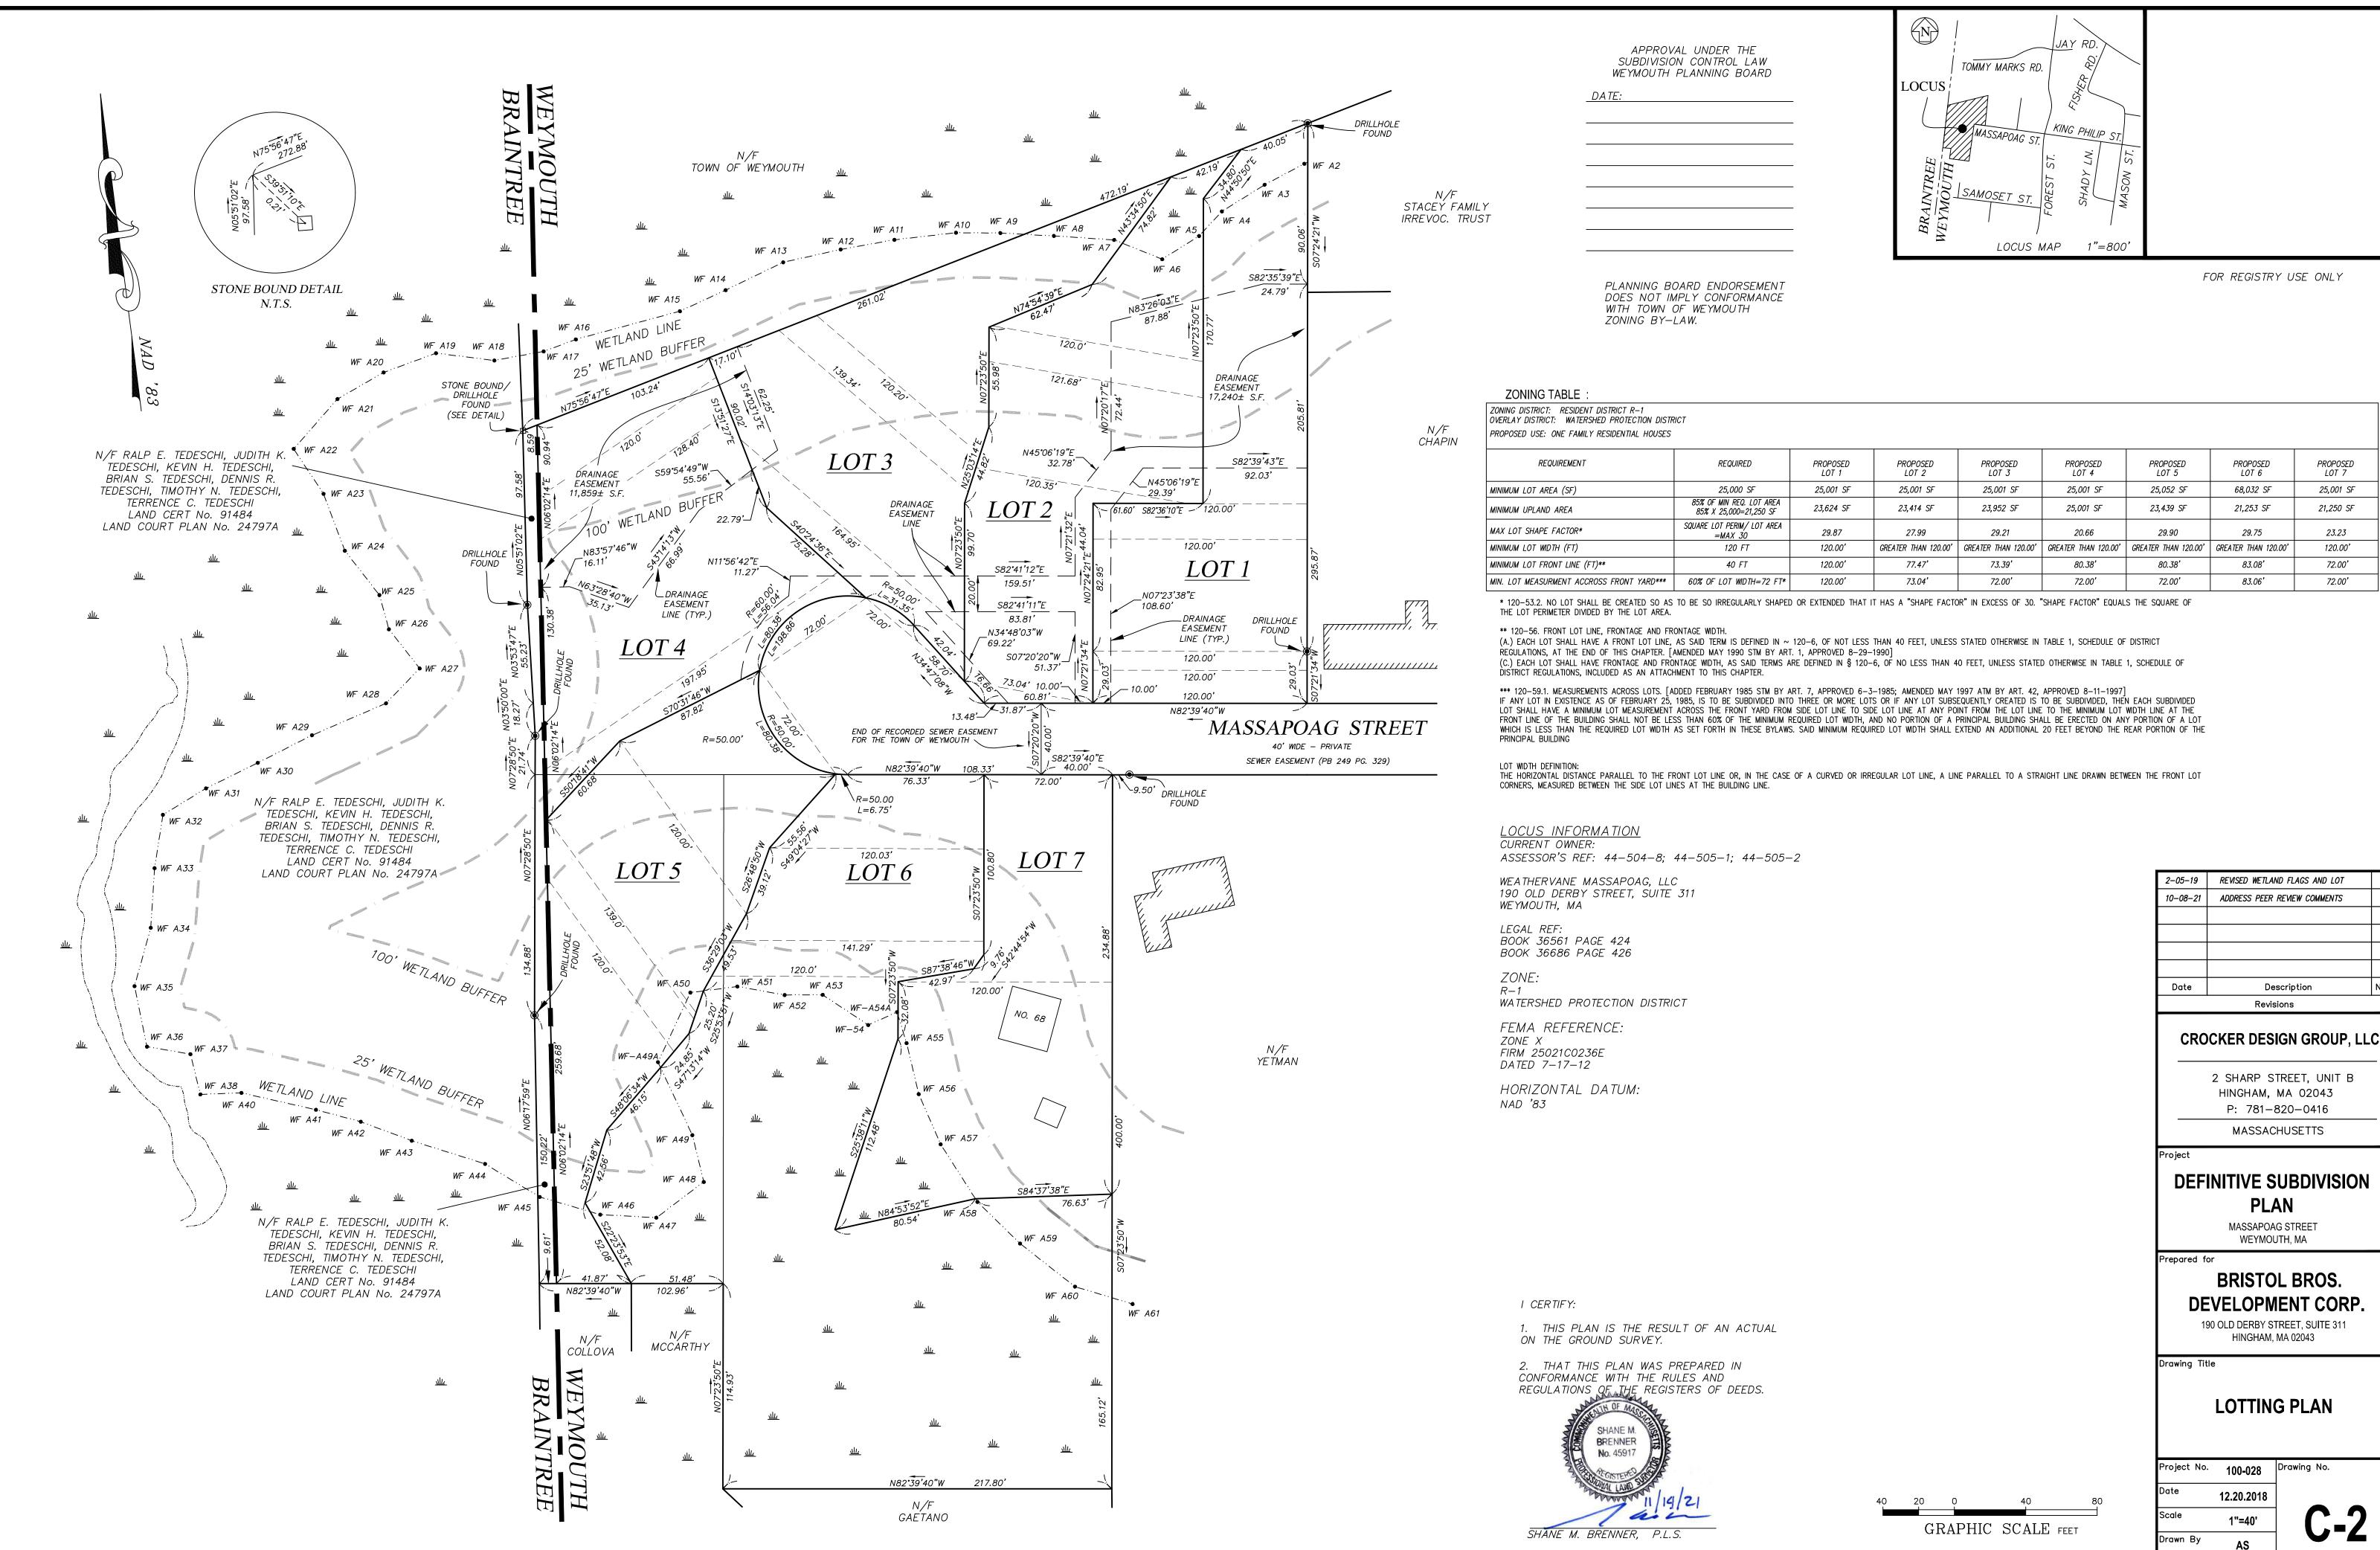

25,001 SF

21,250 SF

23.23


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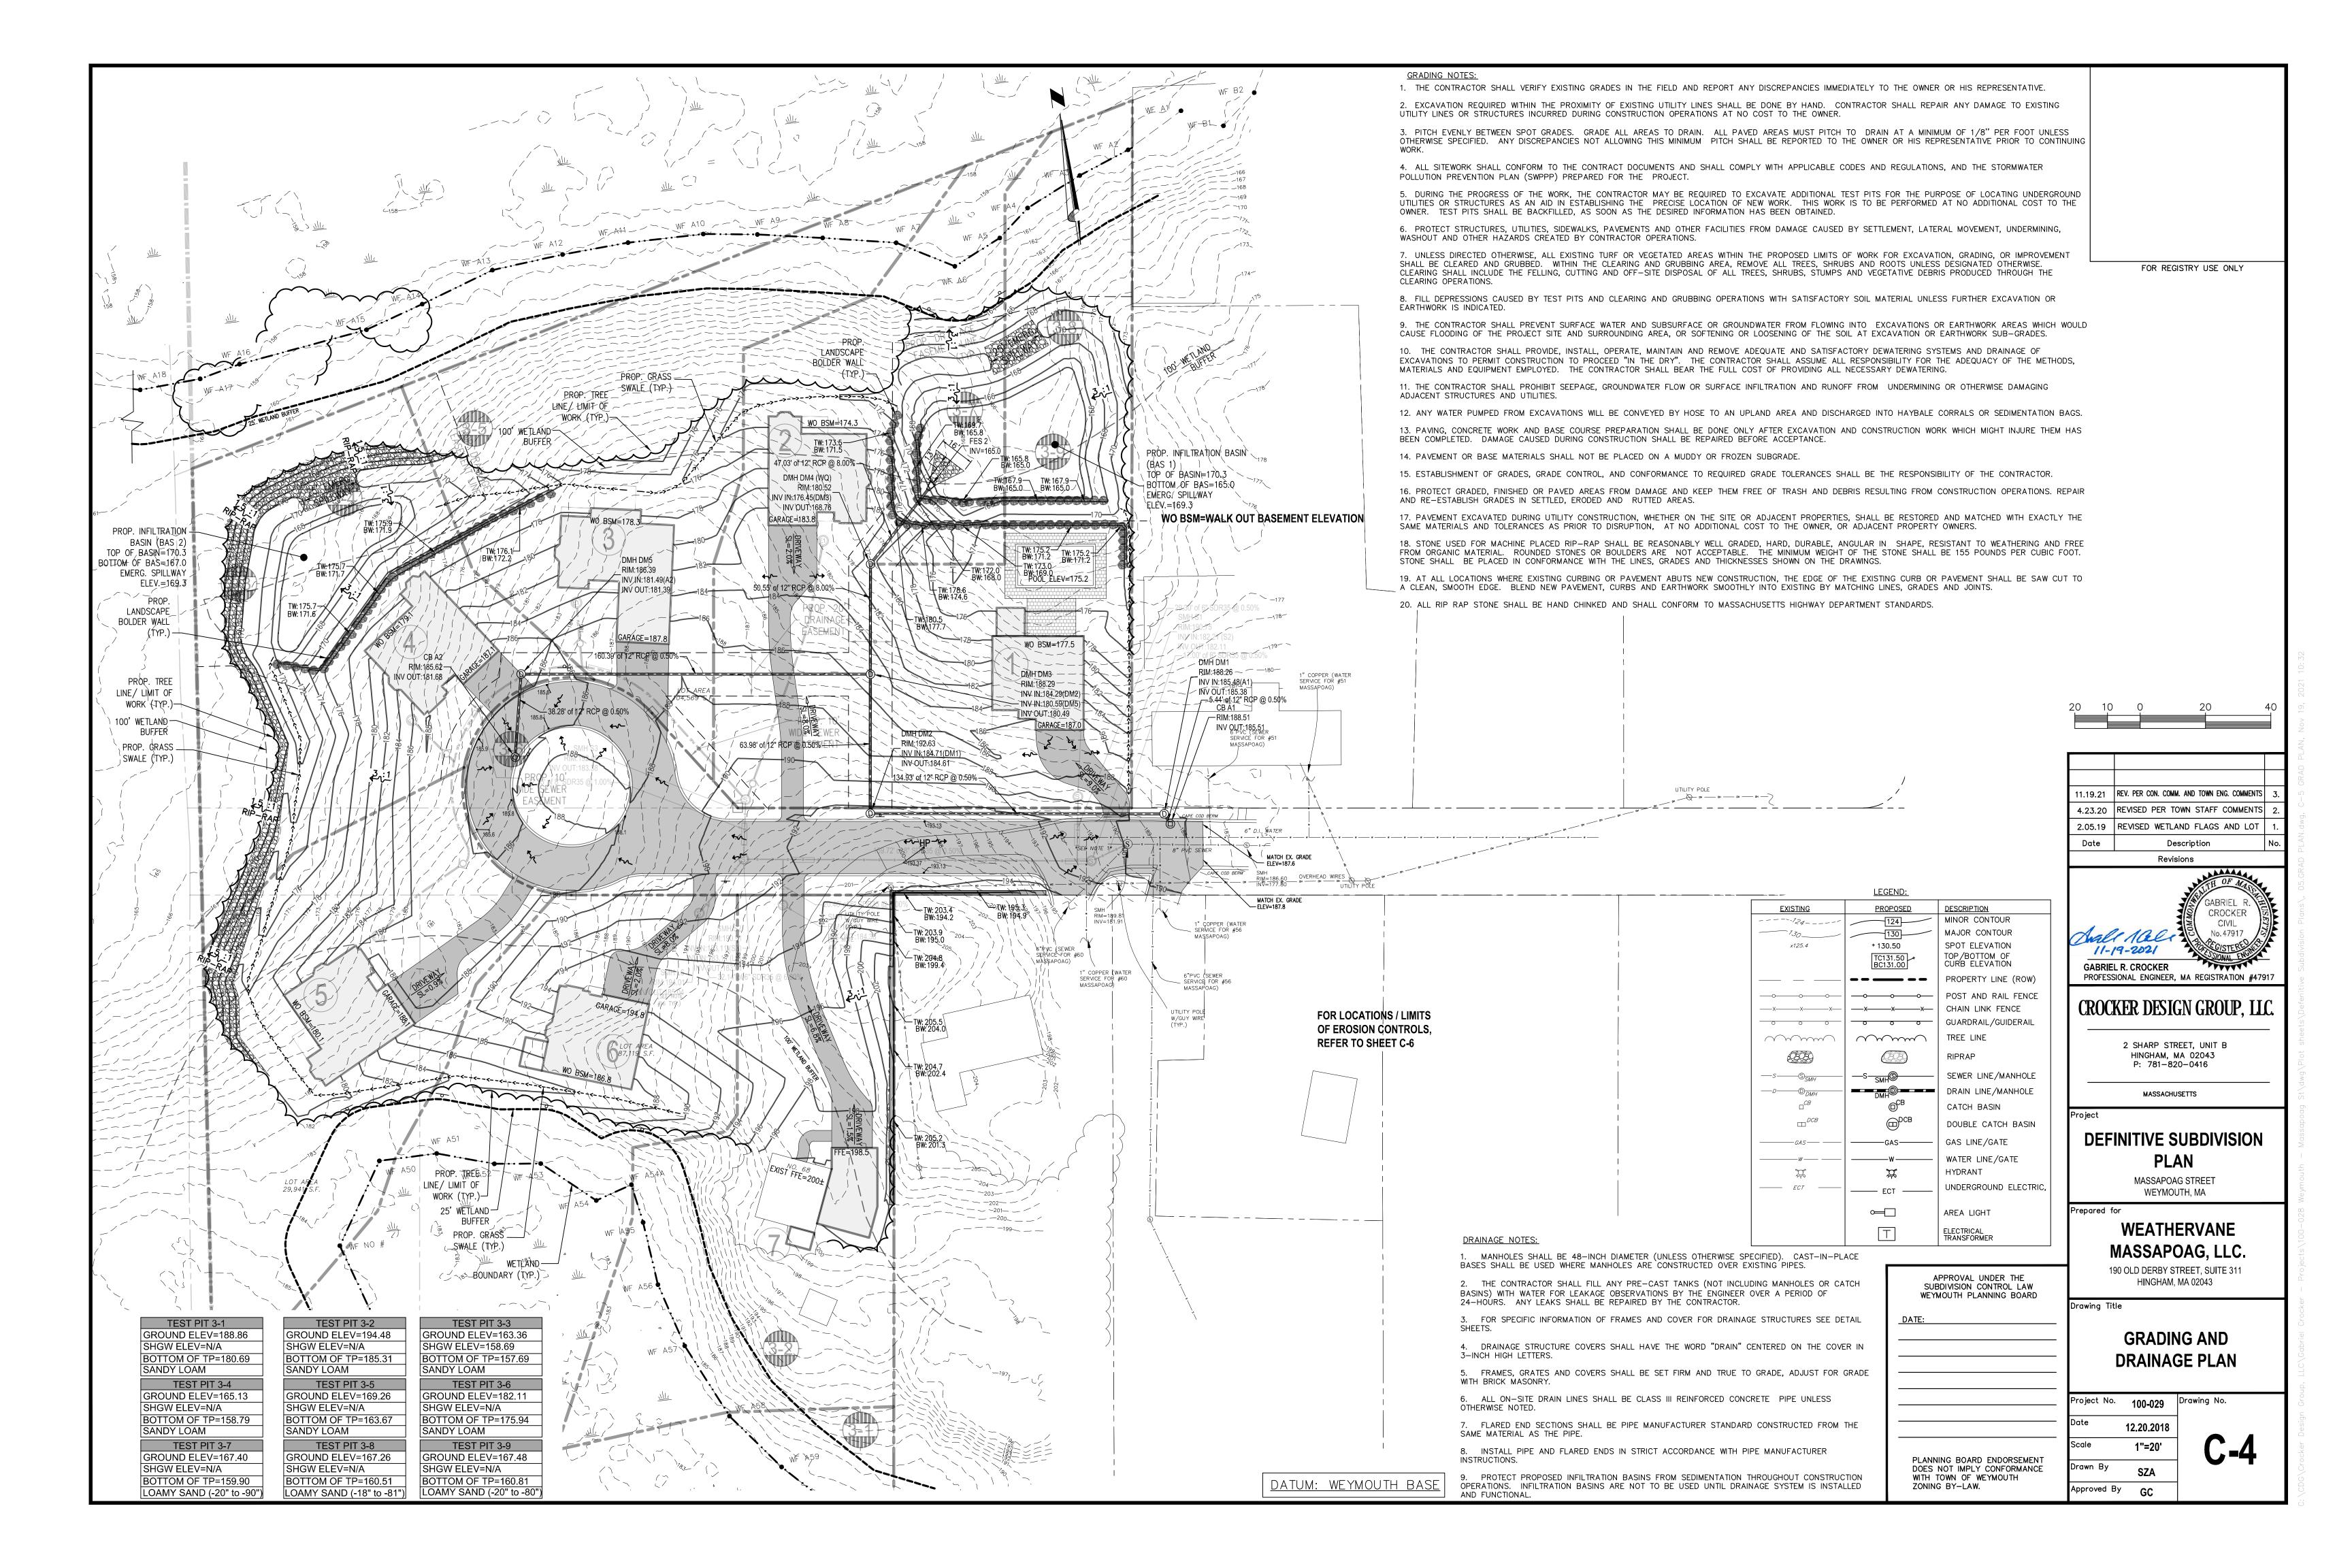
72.00**'** 


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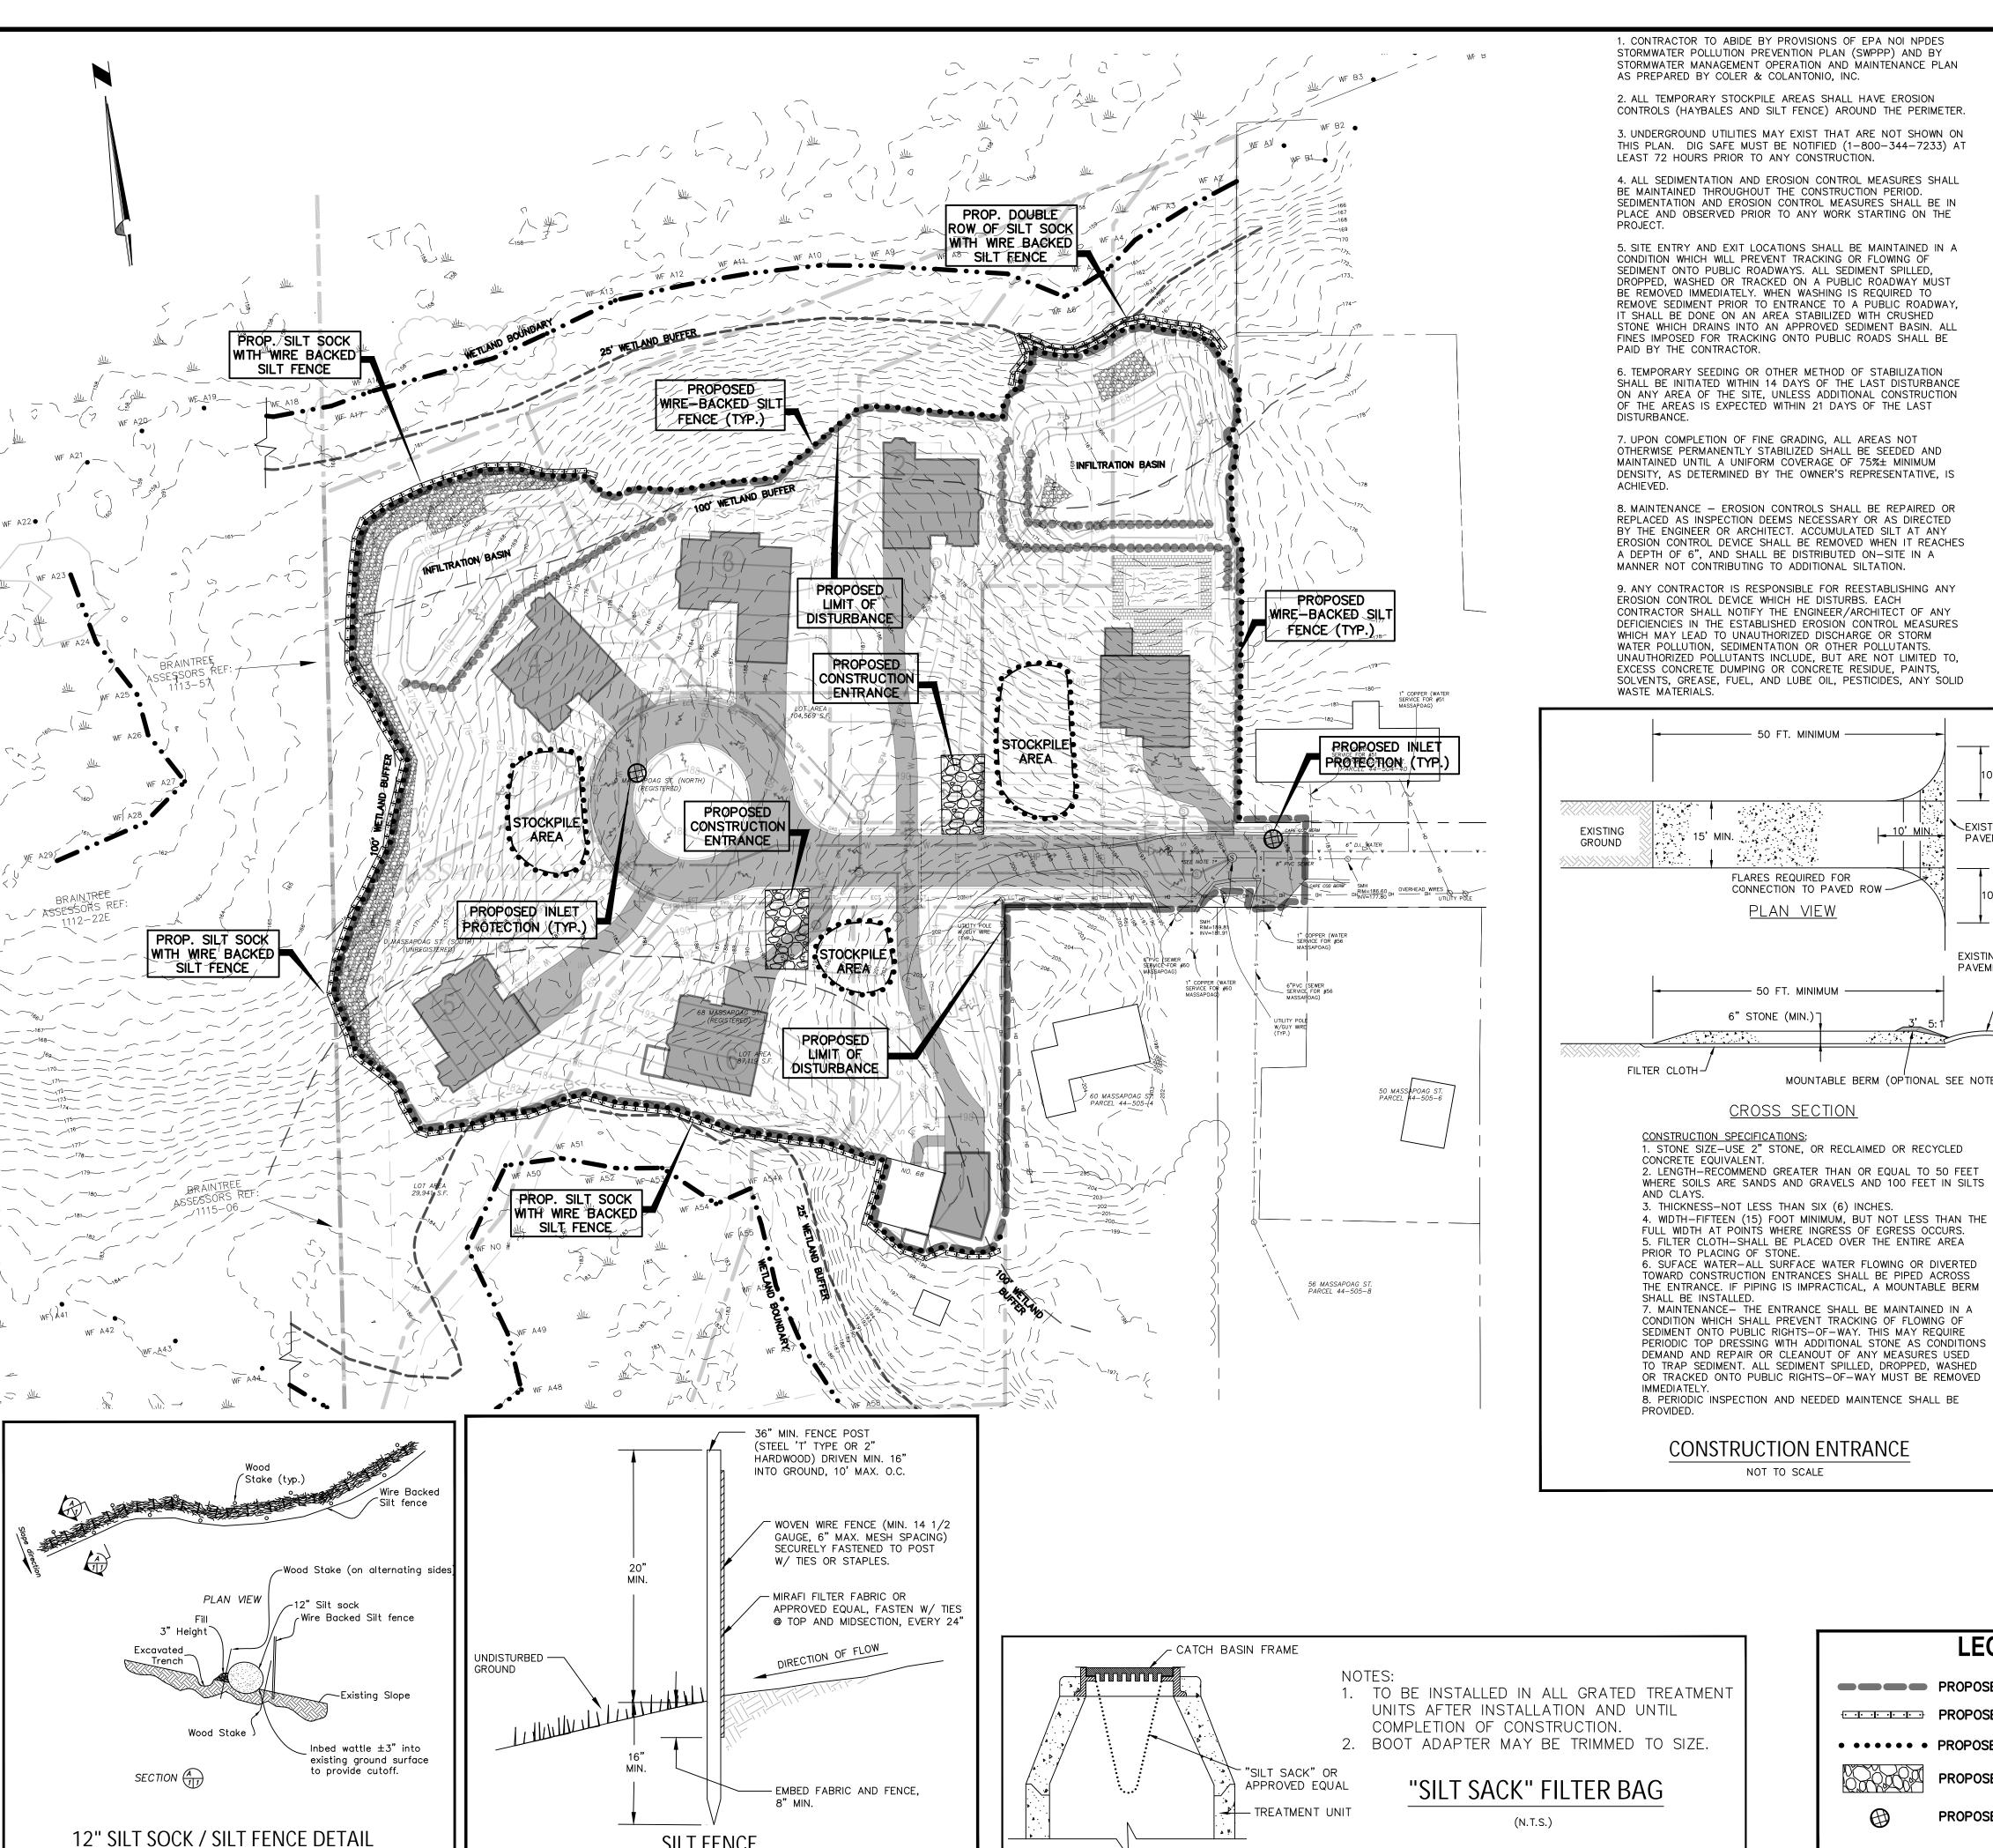
100-028 Drawing No.

Approved By SMB





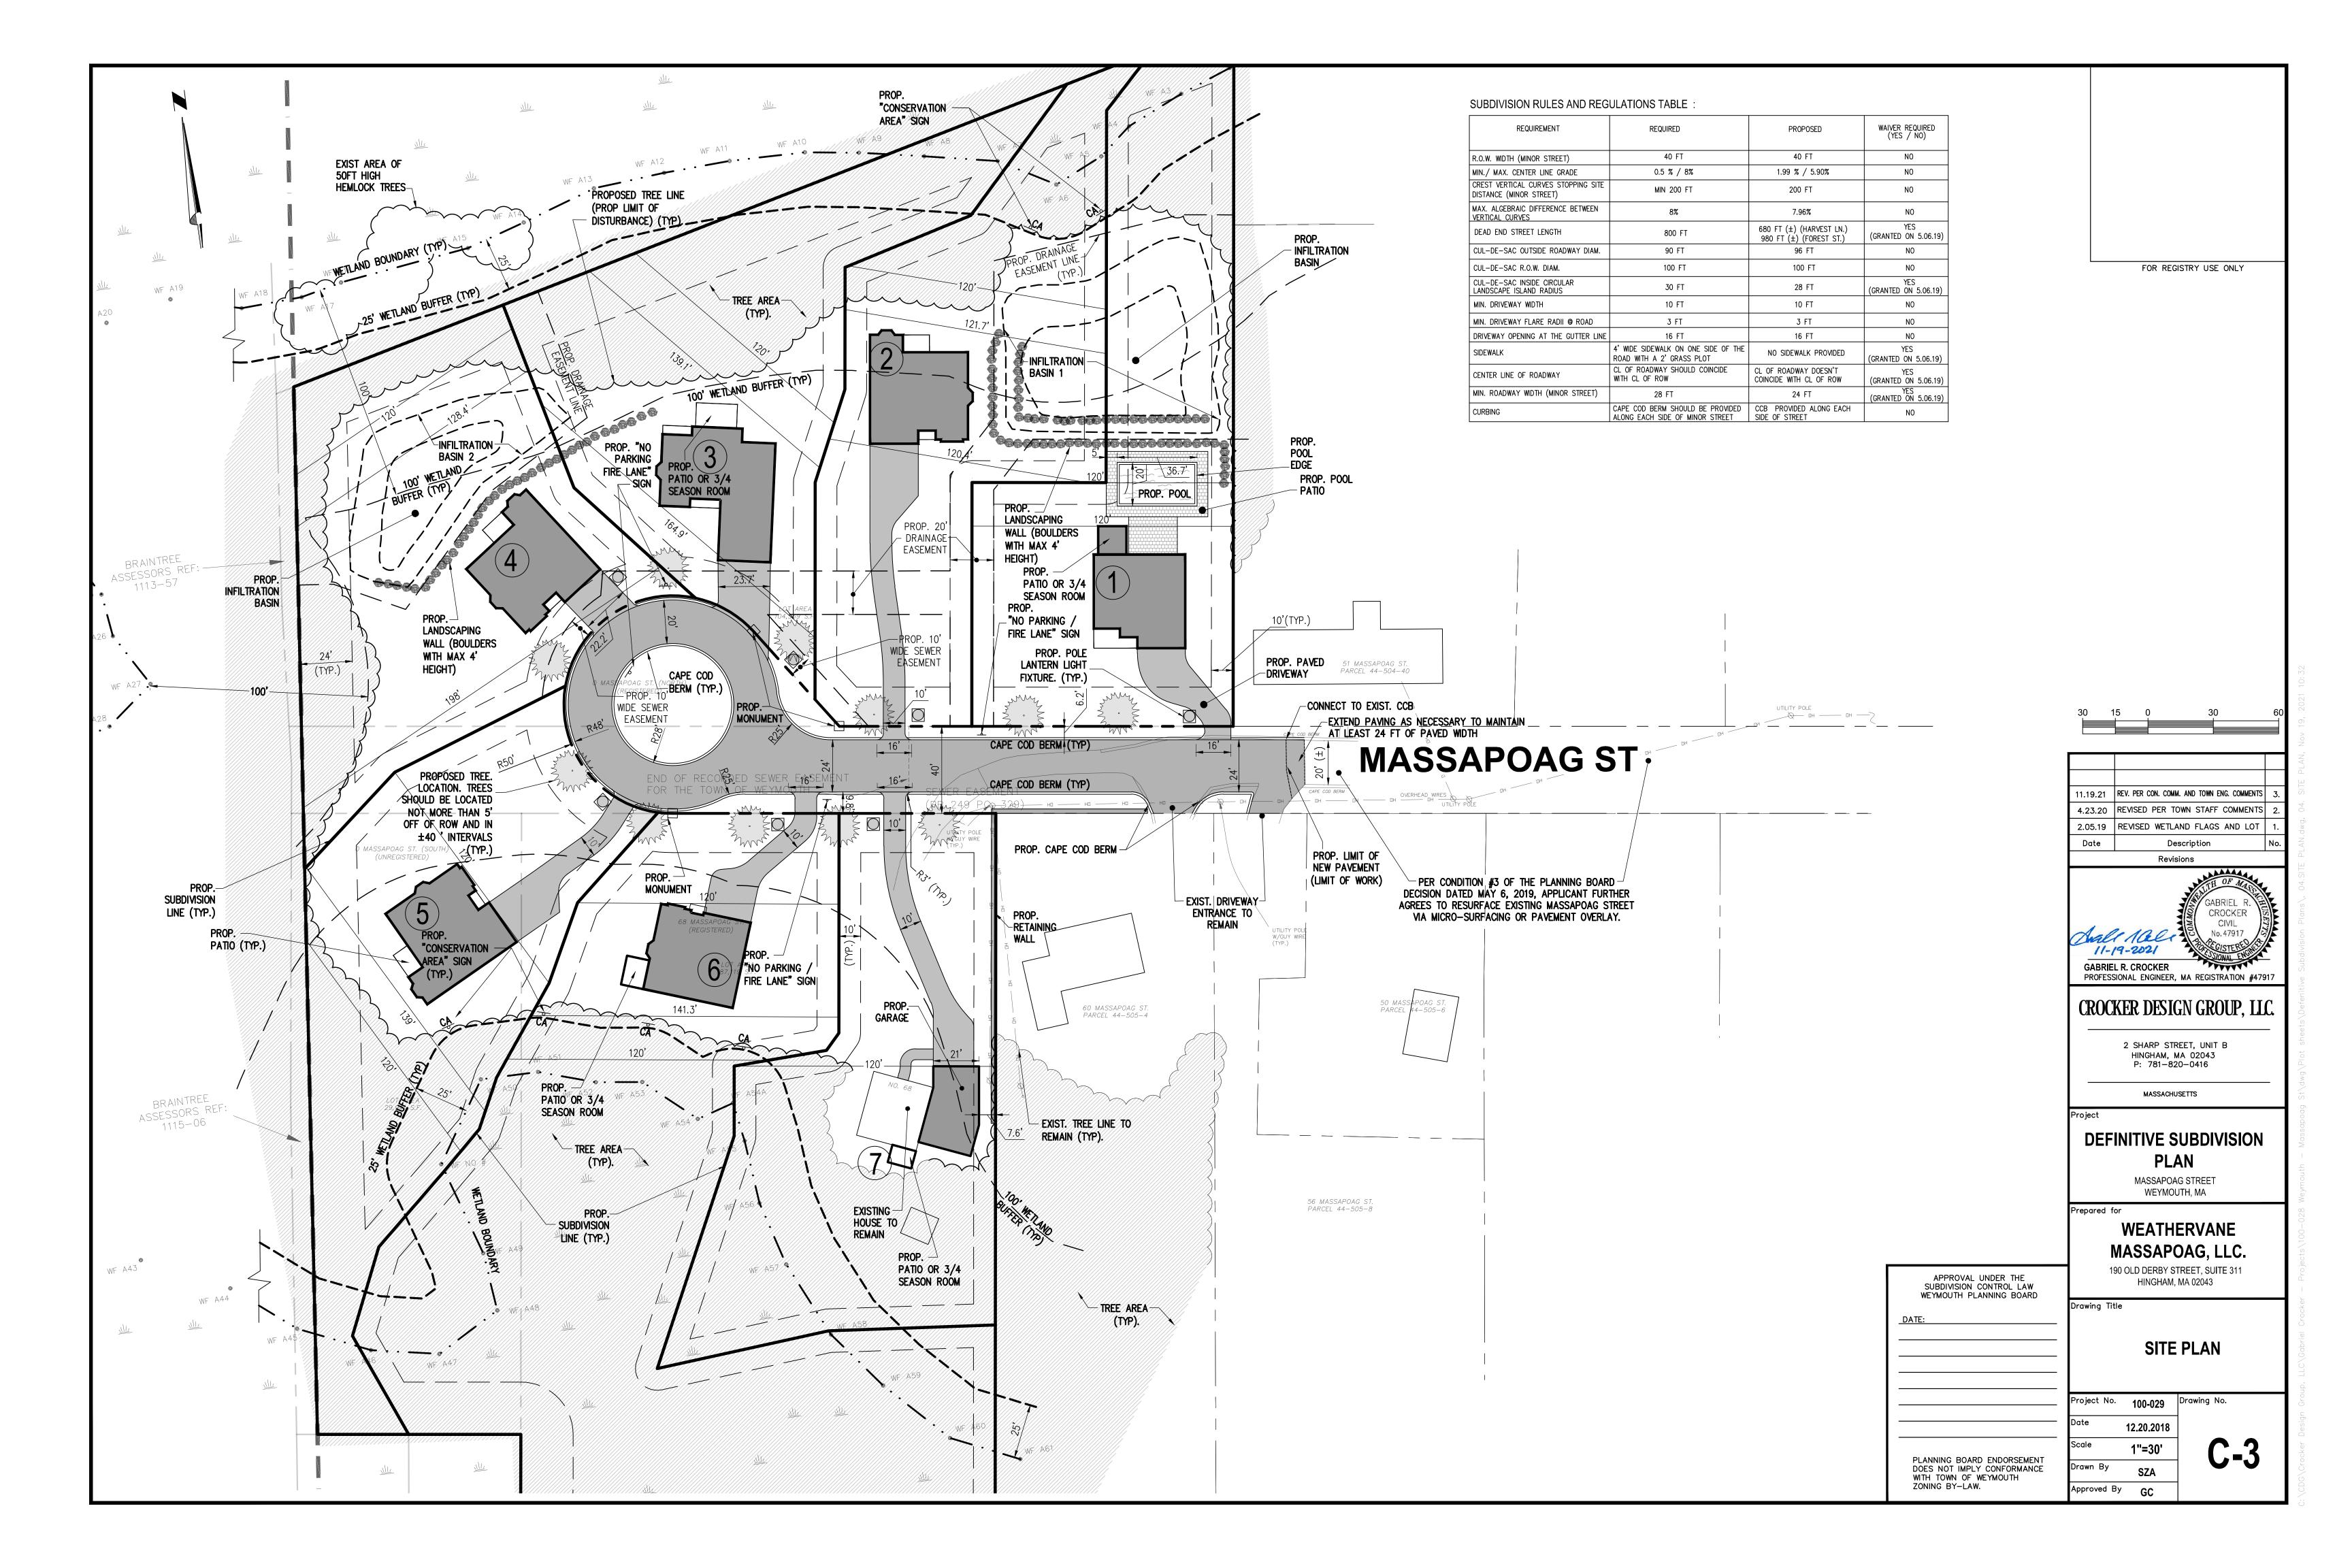

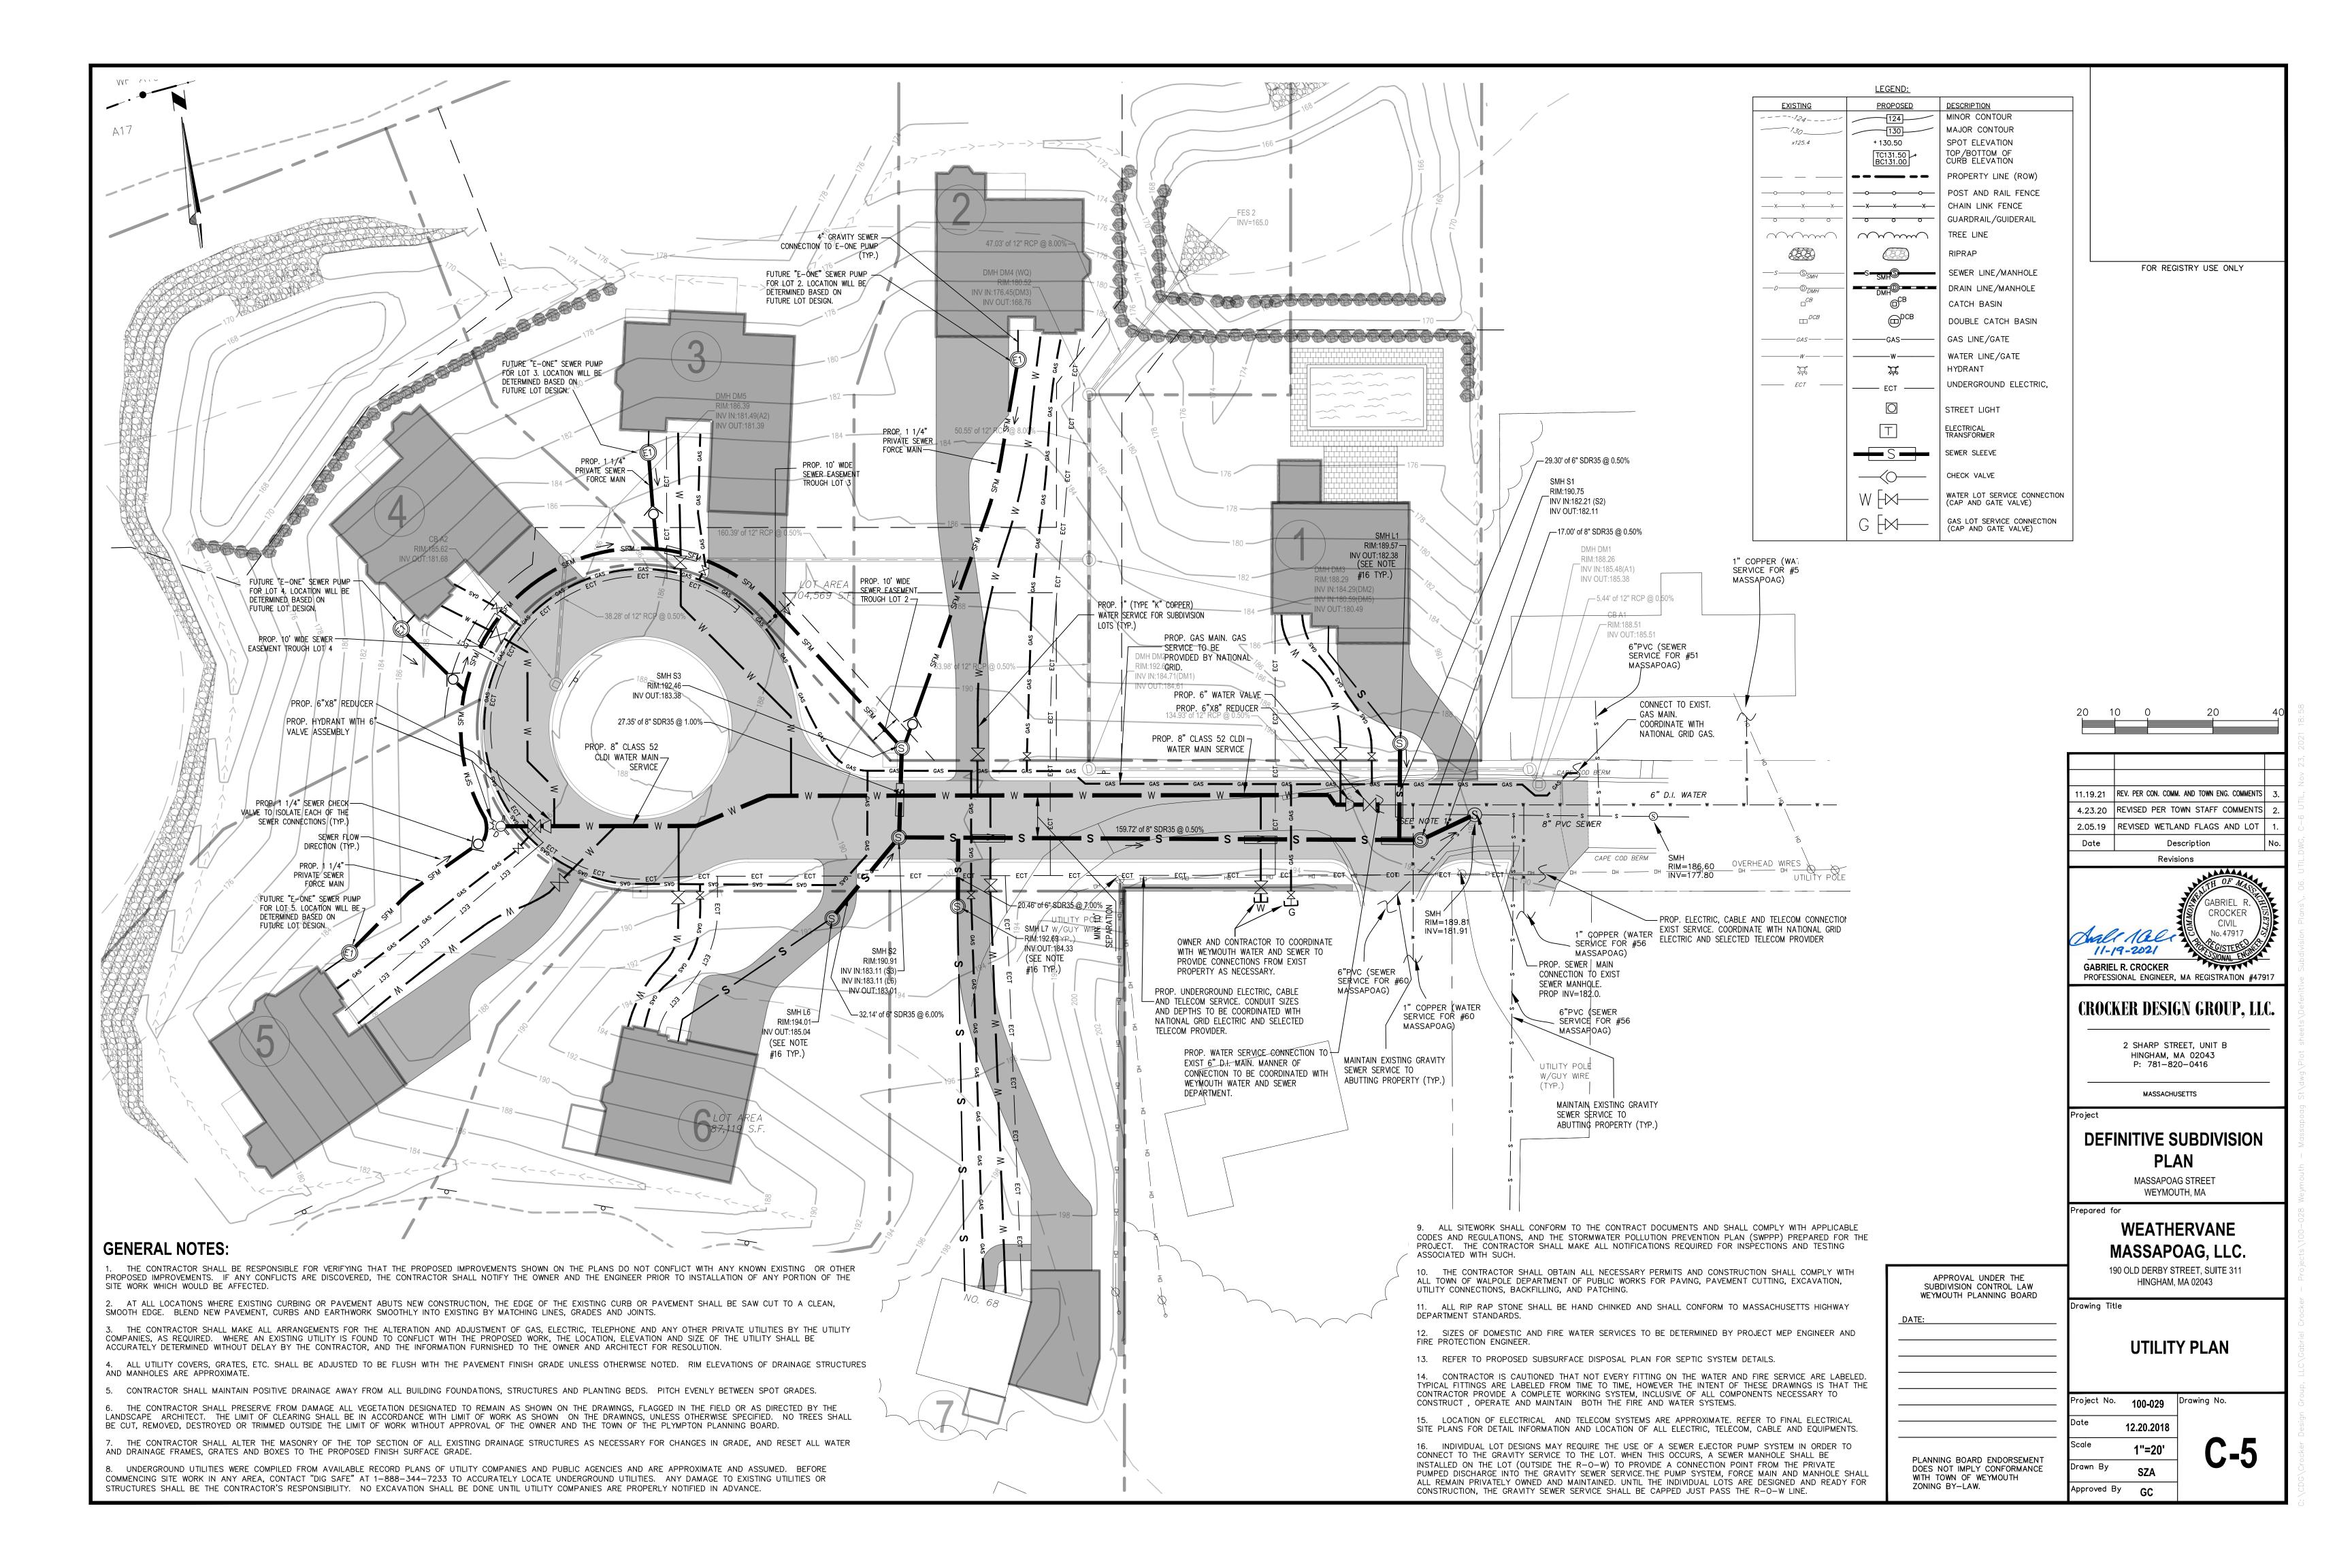

SILT FENCE

NOT TO SCALE

NOT TO SCALE

1. CONTRACTOR TO ABIDE BY PROVISIONS OF EPA NOI NPDES STORMWATER POLLUTION PREVENTION PLAN (SWPPP) AND BY STORMWATER MANAGEMENT OPERATION AND MAINTENANCE PLAN AS PREPARED BY COLER & COLANTONIO, INC.

2. ALL TEMPORARY STOCKPILE AREAS SHALL HAVE EROSION CONTROLS (HAYBALES AND SILT FENCE) AROUND THE PERIMETER.

3. UNDERGROUND UTILITIES MAY EXIST THAT ARE NOT SHOWN ON THIS PLAN. DIG SAFE MUST BE NOTIFIED (1-800-344-7233) AT LEAST 72 HOURS PRIOR TO ANY CONSTRUCTION.

4. ALL SEDIMENTATION AND EROSION CONTROL MEASURES SHALL BE MAINTAINED THROUGHOUT THE CONSTRUCTION PERIOD. SEDIMENTATION AND EROSION CONTROL MEASURES SHALL BE IN PLACE AND OBSERVED PRIOR TO ANY WORK STARTING ON THE

5. SITE ENTRY AND EXIT LOCATIONS SHALL BE MAINTAINED IN A CONDITION WHICH WILL PREVENT TRACKING OR FLOWING OF SEDIMENT ONTO PUBLIC ROADWAYS. ALL SEDIMENT SPILLED. DROPPED, WASHED OR TRACKED ON A PUBLIC ROADWAY MUST BE REMOVED IMMEDIATELY. WHEN WASHING IS REQUIRED TO REMOVE SEDIMENT PRIOR TO ENTRANCE TO A PUBLIC ROADWAY, IT SHALL BE DONE ON AN AREA STABILIZED WITH CRUSHED STONE WHICH DRAINS INTO AN APPROVED SEDIMENT BASIN. ALL FINES IMPOSED FOR TRACKING ONTO PUBLIC ROADS SHALL BE PAID BY THE CONTRACTOR.

6. TEMPORARY SEEDING OR OTHER METHOD OF STABILIZATION SHALL BE INITIATED WITHIN 14 DAYS OF THE LAST DISTURBANCE ON ANY AREA OF THE SITE, UNLESS ADDITIONAL CONSTRUCTION OF THE AREAS IS EXPECTED WITHIN 21 DAYS OF THE LAST

7. UPON COMPLETION OF FINE GRADING, ALL AREAS NOT OTHERWISE PERMANENTLY STABILIZED SHALL BE SEEDED AND MAINTAINED UNTIL A UNIFORM COVERAGE OF 75%± MINIMUM DENSITY, AS DETERMINED BY THE OWNER'S REPRESENTATIVE, IS

8. MAINTENANCE - EROSION CONTROLS SHALL BE REPAIRED OR REPLACED AS INSPECTION DEEMS NECESSARY OR AS DIRECTED BY THE ENGINEER OR ARCHITECT, ACCUMULATED SILT AT ANY EROSION CONTROL DEVICE SHALL BE REMOVED WHEN IT REACHES A DEPTH OF 6", AND SHALL BE DISTRIBUTED ON-SITE IN A MANNER NOT CONTRIBUTING TO ADDITIONAL SILTATION.

9. ANY CONTRACTOR IS RESPONSIBLE FOR REESTABLISHING ANY EROSION CONTROL DEVICE WHICH HE DISTURBS. EACH CONTRACTOR SHALL NOTIFY THE ENGINEER/ARCHITECT OF ANY DEFICIENCIES IN THE ESTABLISHED EROSION CONTROL MEASURES WHICH MAY LEAD TO UNAUTHORIZED DISCHARGE OR STORM WATER POLLUTION, SEDIMENTATION OR OTHER POLLUTANTS. UNAUTHORIZED POLLUTANTS INCLUDE, BUT ARE NOT LIMITED TO, EXCESS CONCRETE DUMPING OR CONCRETE RESIDUE, PAINTS, SOLVENTS, GREASE, FUEL, AND LUBE OIL, PESTICIDES, ANY SOLID WASTE MATERIALS.

- 50 FT. MINIMUM -

FLARES REQUIRED FOR

PLAN VIEW

— 50 FT. МІПІМИМ —

CROSS SECTION

1. STONE SIZE-USE 2" STONE, OR RECLAIMED OR RECYCLED

7. MAINTENANCE- THE ENTRANCE SHALL BE MAINTAINED IN A

TO TRAP SEDIMENT. ALL SEDIMENT SPILLED, DROPPED, WASHED

CONSTRUCTION ENTRANCE

NOT TO SCALE

6" STONE (MIN.)

CONSTRUCTION SPECIFICATIONS:

PRIOR TO PLACING OF STONE.

SHALL BE INSTALLED.

CONNECTION TO PAVED ROW

(CONTINUATION OF GENERAL NOTES)

10. ALL SIDE SLOPES SHALL BE SEEDED WITH GRASS OR INSTALL JUTE NETTING TO PREVENT EROSION.

11. MAINTENANCE: EROSION CONTROLS SHALL BE REPAIRED OR REPLACED AS INSPECTION DEEMS NECESSARY OR AS DIRECTED BY THE ENGINEER OR ARCHITECT. ACCUMULATED SILT AT ANY EROSION CONTROL DEVICE SHALL BE REMOVED WHEN IT REACHES A DEPTH OF 6", AND SHALL BE DISTRIBUTED ON-SITE IN A MANNER NOT CONTRIBUTING TO ADDITIONAL SILTATION.

12. INSPECTIONS: INSPECTIONS ARE TO BE PERFORMED BY QUALIFIED PERSONNEL. DISTURBED AREAS THAT HAVE NOT BEEN FINALLY STABILIZED, AREAS USED FOR STORAGE, STRUCTURAL CONTROL MEASURES, AND LOCATIONS WHERE VEHICLES ENTER OR EXIT THE SITE, MUST BE INSPECTED ONCE EVERY 7 DAYS AND WITHIN 24 HOURS OF A STORM EVEN OF 0.5 INCHES OR GREATER. STABILIZED AREAS ARE TO BE INSPECTED ONCE PER MONTH DISTURBED AREAS AND STORAGE AREAS EXPOSED TO PRECIPITATION SHALL BE INSPECTED FOR EVIDENCE OF OR POTENTIAL FOR POLLUTANTS ENTERING THE DRAINAGE SYSTEM. CONTROL MEASURES SHALL BE OBSERVED TO ENSURE THEY ARE WORKING PROPERLY. DISCHARGE LOCATIONS AND POINTS SHALL BE INSPECTED TO ASCERTAIN WHETHER CONTROLS ARE PREVENTING SIGNIFICANT IMPACT. BASED ON THE RESULTS OF THE ABOVE INSPECTIONS, ANY NECESSARY CHANGES TO THE PLAN WILL BE MADE WITHIN 7 DAYS OF THE INSPECTION AND SUBMITTED TO THE TOWN...... PLANNING BOARD. THE CHANGES MUST BE IMPLEMENTED IN THE FIELD BEFORE THE NEXT STORM EVEN IF PRACTICABLE, OTHERWISE AS SOON AS

13. INSTALL AND MAINTAIN CATCH BASIN INSERTS IN ALL PROPOSED AND EXISTING CATCH BASINS.

14. PROVIDE TEMPORARY SEDIMENTATION BASINS, HAY BALES, ETC. AS NECESSARY.

15. STOCKPILES ARE TO BE AT LEAST 100 FEET FROM WETLAND AREAS. STOCKPILES NOT TO BE REUSED WITHIN 30 DAYS ARE TO BE STABILIZED WITH SEED OR MULCH.

16. CONTRACTOR TO MAINTAIN WITHIN LIMITS OUTSIDE NSTAR EASEMENT EXCEPT FOR SPECIFIC AREAS IDENTIFIED TO BE DISTURBED WITHIN EASEMENT.

17. POTENTIAL STOCK PILE AREAA TO BE PROTECTED WITH EROSION CONTROL MEASURES.

18. THE CONTRACTOR SHALL HAVE A WATER TRUCK ON-SITE AT ALL TIMES AND SHALL PROVIDE TEMPORARY PLANTINGS OR OTHER COVERINGS SUCH AS WOOD CHIPS TO MINIMIZE THE AMOUNT OF DUST LEAVING THE PREMISES.

CONSTRUCTION PHASING

1. BELOW IS PRESENTED A GENERAL CONSTRUCTION PHASING. A MORE DETAILED SCHEDULE IS PRESENTED IN THE STORMWATER POLLUTION PREVENTION PLAN (SWPPP).

CENTERLINE OF ROAD AND EXTENTS OF CONSTRUCTION TO BE DELINEATED BY CONTRACTOR.

3. EROSION AND SEDIMENTATION CONTROL MEASURES INCLUDING HAY BALES AND SILT FENCE (OR OPTIONAL FILTER SACK IN LIEU OF HAY BALES AND SILT FENCE) WILL BE INSTALLED. CONTRACTOR SHALL INSPECT CONTROL MEASURES MONTHLY AND AFTER RAIN EVENTS OF 0.5" OR GREATER.

4. THE PROJECT AREA WILL BE CLEARED OF DEBRIS AND BOULDERS. MATERIAL REMOVED FROM THE SITE WILL BE TRANSPORTED TO AN APPROPRIATE FACILITY OR WILL BE DISPOSED OF ELSEWHERE ACCORDING TO FEDERAL, STATE, AND LOCAL GUIDELINES. INACTIVE STOCKPILES OR AREAS OF GRANULAR MATERIAL OR TOPSOIL SHALL BE TEMPORARILY SEEDED OR MULCHED IN ORDER TO CONTROL SEDIMENT LADEN

5. CONTRACTOR IS RESPONSIBLE TO SET OUT UTILITIES AND ANY NECESSARY GRADES.

6. GRADING OF SITE INCLUDING BUILDING PADS, PARKING AREAS, AND DETENTION BASINS AND DIGGING OF UTILITY RENCHES TO DEFINED INVERT LEVELS. MATERIAL TO BE STORED ON AN UNUSED SITE AREA FOR FILL OR PROPERLY REMOVED FROM THE JOB SITE. IF SUITABLE TOPSOIL IS FOUND, IT WILL BE REMOVED AND STOCKPILED IN AN UPLAND AREA AT LEAST 100' FROM WETLANDS TO BE REUSED AS TOPSOIL ON THE PROJECT.

7. PLACING OF FILL OR SUITABLE MATERIAL ON ALL ACCESS ROADS FOR EASY ACCESS. SETTING OUT OF FOUNDATIONS AND SURROUNDING ROADS.

8. LAYING OF ALL UTILITIES INCLUDING DRAINAGE PIPES AND STRUCTURES FOLLOWED BY BACK-FILL, TAKING CARE TO LEAVE ONLY TRENCHES BEING WORKED ON OPEN.

9. FINE GRADING FOR THE PARKING AREAS, ROADWAYS, AND DRAINAGE BASINS TO BE COMPLETED.

10. DRAINAGE BASIN VEGETATION TO BE ESTABLISHED PRIOR TO DISCHARGE FROM CONSTRUCTED DRAINAGE STRUCTURES. 11. ONCE THE DRAINAGE STRUCTURES ARE INSTALLED, PROVIDE PROTECTION AT ALL CATCH BASINS AND INLETS TO PREVENT

12. INSTALL BINDER COURSE AND SPREAD TOPSOIL AS NEEDED.

SEDIMENT FROM ENTERING THE DRAINAGE SYSTEM.

13. LIGHT POLES, SIGNAGE, ETC. WILL BE INSTALLED. 14. INSTALL TOP COURSE OF PAVING AND SIDEWALK.

15. THE FINAL PHASE OF CONSTRUCTION IS RESTORATION AND STABILIZATION OF ALL EXPOSED SURFACES. DISTURBED AREAS SHALL BE LANDSCAPED OR SEEDED (SEE ADDITIONAL DISCUSSION IN SWPPP). IN THE EVENT THAT WEATHER CONDITIONS PREVENT FINAL STÁBILIZATION, TEMPORARY EROSION AND SEDIMENTATION MEASURES WILL BE EMPLOYED UNTIL THE TEMPERATURE AND WEATHER IS SUITABLE FOR GRASS GROWING. A FINAL INSPECTION WILL ENSURE THAT THE SITE IS CLEARED OF ALL PROJECT DEBRIS AND THAT EROSION AND SEDIMENTATION CONTROLS ARE FUNCTIONING PROPERLY. HAYBALES AND SILT FENCE WILL REMAIN IN PLACE UNTIL THE SITE IS FULLY STABILIZED AND THE SITE HAS PASSED FINAL INSPECTION. VEGETATION IS TO BE OF A UNIFORM DENSITY OF AT LEAST 75% FOR ACCEPTANCE.

FOR REGISTRY USE ONLY

11.19.21 | REV. PER CON. COMM. AND TOWN ENG. COMMENTS | 4.23.20 | REVISED PER TOWN STAFF COMMENTS 2.05.19 | REVISED WETLAND FLAGS AND LOT Description

> CROCKER 11-19-2021 GABRIEL R. CROCKER

Revisions

CROCKER DESIGN GROUP, LI

PROFESSIONAL ENGINEER, MA REGISTRATION #47917

2 SHARP STREET, UNIT B HINGHAM, MA 02043 P: 781-820-0416

**DEFINITIVE SUBDIVISION PLAN** 

MASSACHUSETTS

MASSAPOAG STREET WEYMOUTH, MA

Prepared for WEATHERVANE

> MASSAPOAG, LLC 190 OLD DERBY STREET, SUITE 311 HINGHAM, MA 02043

**SOIL EROSION AND** SEDIMENT CONTROL PLAN

100-029 Drawing No. Project No. 12.20.2018

1"=40' SZA Approved By GC

APPROVAL UNDER THE

SUBDIVISION CONTROL LAW

WEYMOUTH PLANNING BOARD

PLANNING BOARD ENDORSEMENT DOES NOT IMPLY CONFORMANCE WITH TOWN OF WEYMOUTH ZONING BY-LAW.

**LEGEND** 

PROPOSED LIMIT OF DISTURBANCE

EXISTING

**PAVEMENT** 

PAVEMENT

\_\_\_10' MIN.

MOUNTABLE BERM (OPTIONAL SEE NOTE 6)

PROPOSED SILT SOCK • • • • • • • PROPOSED WIRE BACKED SILT FENCE

PROPOSED CONSTRUCTION ENTRANCE

PROPOSED INLET PROTECTION

